
HILLIARD N. FLETCHER WATER RESOURCE RECOVERY FACILITY PHASE II IMPROVEMENTS




CITY OF TUSCALOOSA

FILE NO. OCA-23-1043 ENGINEERING PROJECT NO. 2024.702.001

BID SET

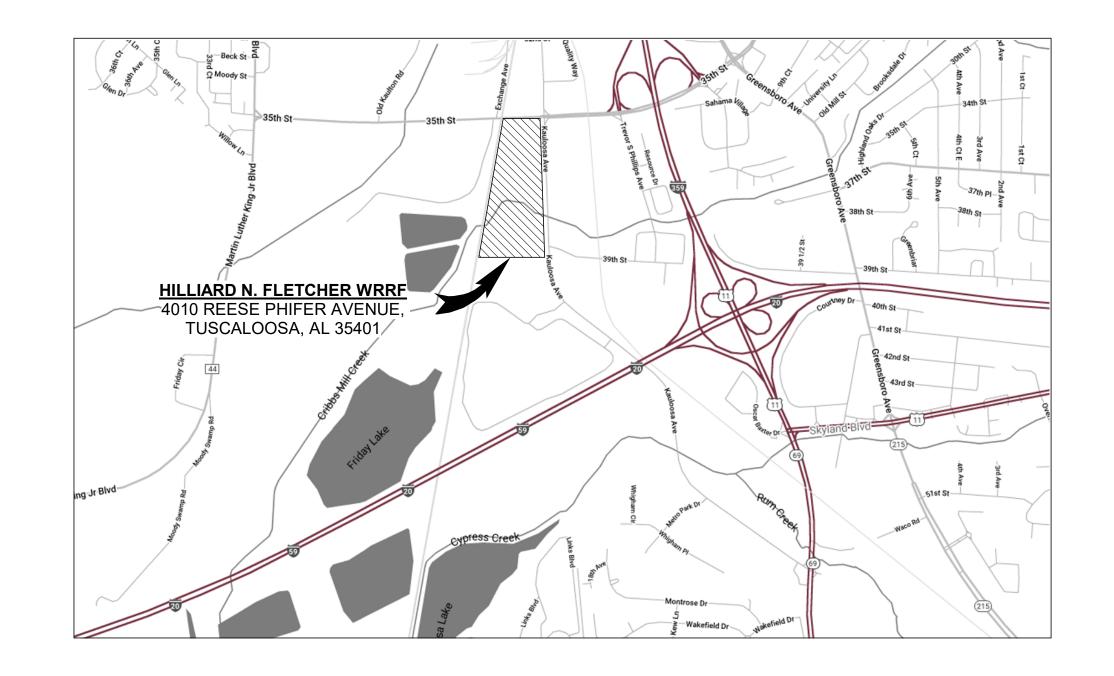

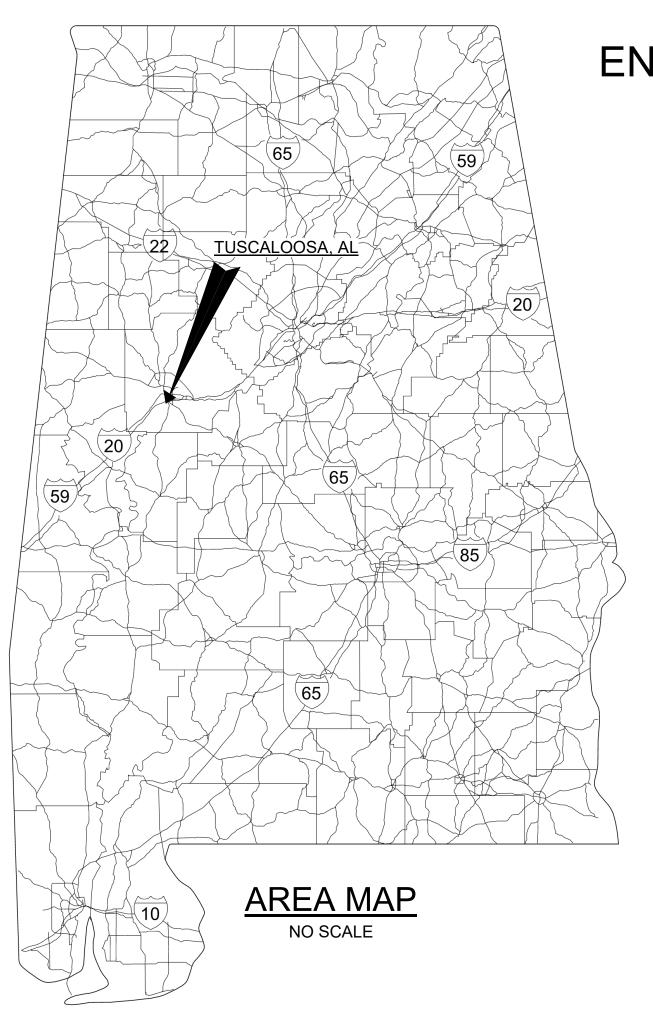

GARVER PROJECT NO. 19W10160 JANUARY 2024



2111 Parkway Office Circle Suite 100 Birmingham, AL 35244 Phone: 205-443-3080



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MATER S. SEWER

SCALOOSA, AL
LLIARD N. FLETCHER

COVER SHEET

JOB NO.: 19W10160 DATE: JAN. 2024 DESIGNED BY: RWC DRAWN BY: SAC CHECKED BY: RDT

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01-G001

SHEET 001

05 - SITE CIVIL			
DWG.			
NO.	DESCRIPTION		
05-C101	EXISTING SITE PLAN - OVERVIEW		
05-X102	PROPOSED DEMOLITION PLAN		
05-C103	PROPOSED SITE PLAN - ENLARGED		
05-C201	PROPOSED GRADING AND PAVING - ENLARGED		
05-X301	YARD PIPING DEMOLITION PLAN		
05-C302	PROPOSED YARD PIPING PLAN - ENLARGED		
05-E101	ELECTRICAL SITE PLAN		
	NO. 05-C101 05-X102 05-C103 05-C201 05-X301 05-C302		

08 - PROCESS & INSTRUMENTATION CONTROLS DIAGRAMS				
SHEET	DWG.			
NO.	NO.	DESCRIPTION		
020	08-1111	ANAEROBIC DIGESTER NO. 1 P&ID		
021	08-1121	ANAEROBIC DIGESTER NO. 2 P&ID		
022	08-1131	ANAEROBIC DIGESTER NO. 3 AND DEWATERING FEED PUMPS P&ID		

11 - ANAEROBIC DIGESTER NO. 1 IMPROVEMENTS				
SHEET	DWG.			
NO.	NO.	DESCRIPTION		
023	11-X101	ANAEROBIC DIGESTION FACILITY UPPER DEMOLITION PLAN		
024	11-X102	ANAEROBIC DIGESTER NO. 1 UPPER DEMOLITION PLAN		
025	11-X103	ANAEROBIC DIGESTER NO. 1 LOWER DEMOLITION PLAN		
026	11-X301	ANAEROBIC DIGESTER NO. 1 DEMOLITION SECTION		
027	11-S101	ANAEROBIC DIGESTER NO. 1 REHABILITATION PLAN		
028	11-S102	ANAEROBIC DIGESTER NO. 1 REHABILITATION SECTIONS AND DETAILS		
029	11-S301	ANAEROBIC DIGESTER NO. 1 REHABILITATION SECTIONS		
030	11-S501	ANAEROBIC DIGESTER PIPE SUPPORT NO. 1 REHABILITATION DETAIL AND SECTION		
031	11-S502	ANAEROBIC DIGESTER PIPE SUPPORT NO. 1 REHABILITATION DETAIL		
032	11-P101	OVERALL ANAEROBIC DIGESTION REHABILITATION PLAN		
033	11-P102	ANAEROBIC DIGESTER NO. 1 IMPROVEMENTS LOWER PLAN		
034	11-P103	ANAEROBIC DIGESTER NO. 1 IMPROVEMENTS UPPER PLAN		
035	11-P301	ANAEROBIC DIGESTER NO. 1 DIGESTER MIXING SECTIONS AND DETAILS		
036	11-P302	ANAEROBIC DIGESTER NO. 1 DIGESTED SLUDGE TRANSFER BOX SECTION AND DETAILS		
037	11-P303	ANAEROBIC DIGESTER NO. 1 DIGESTER BIOGAS HANDLING SECTION AND DETAIL		
038	11-P901	ANAEROBIC DIGESTER NO. 1 DIGESTER MIXING ISOMETRIC		
039	11-P902	ANAEROBIC DIGESTER NO. 1 DIGESTER COVER BIOGAS PIPING ISOMETRIC		
040	11-E101	ANAEROBIC DIGESTER NO. 1 MIXER ELECTRICAL PLAN (TYP OF 3)		
041	11-E601	ANAEROBIC DIGESTER MIXING SYSTEM - CONTROL SCHEMATIC (TYP OF 3)		

	12 - ANAEROBIC DIGESTER NO. 2 IMPROVEMENTS					
SHEET	DWG.					
NO.	NO.	DESCRIPTION				
042	12-X101	ANAEROBIC DIGESTION FACILITY UPPER DEMOLITION PLAN				
043	12-X102	ANAEROBIC DIGESTER NO. 2 UPPER DEMOLITION PLAN				
044	12-X103	ANAEROBIC DIGESTER NO. 2 LOWER DEMOLITION PLAN				
045	12-X301	ANAEROBIC DIGESTER NO. 2 DEMOLITION SECTION				
046	12-S101	ANAEROBIC DIGESTER NO. 2 REHABILITATION PLAN				
047	12-S102	ANAEROBIC DIGESTER NO. 2 REHABILITATION SECTIONS AND DETAILS				
048	12-S301	ANAEROBIC DIGESTER NO. 2 REHABILITATION SECTIONS				
049	12-S501	ANAEROBIC DIGESTER PIPE SUPPORT NO. 2 REHABILITATION DETAIL AND SECTION				
050	12-S502	ANAEROBIC DIGESTER PIPE SUPPORT NO. 2 REHABILITATION DETAIL				
051	12-P101	OVERALL ANAEROBIC DIGESTION REHABILITATION PLAN				
052	12-P102	ANAEROBIC DIGESTER NO. 2 IMPROVEMENTS LOWER PLAN				
053	12-P103	ANAEROBIC DIGESTER NO. 2 IMPROVEMENTS UPPER PLAN				
054	12-P301	ANAEROBIC DIGESTER NO. 2 DIGESTER MIXING SECTIONS AND DETAILS				
055	12-P302	ANAEROBIC DIGESTER NO. 2 DIGESTED SLUDGE TRANSFER BOX SECTION AND DETAILS				
056	12-P303	ANAEROBIC DIGESTER NO. 2 DIGESTER BIOGAS HANDLING SECTION				
057	12-P901	ANAEROBIC DIGESTER NO. 2 DIGESTER MIXING ISOMETRICS				

058 | 12-P902 | ANAEROBIC DIGESTER NO. 2 DIGESTER COVER BIOGAS PIPING ISOMETRIC

	13 - ANAEROBIC DIGESTER NO. 3 IMPROVEMENTS				
SHEET	DWG.				
NO.	NO.	DESCRIPTION			
059	13-X101	ANAEROBIC DIGESTION FACILITY UPPER DEMOLITION PLAN			
060	13-X102	ANAEROBIC DIGESTER NO. 3 UPPER DEMOLITION PLAN			
061	13-X103	ANAEROBIC DIGESTER NO. 3 LOWER DEMOLITION PLAN			
062	13-X301	ANAEROBIC DIGESTER NO. 3 DEMOLITION SECTION			
063	13-S101	ANAEROBIC DIGESTER NO. 3 REHABILITATION PLAN AND DETAILS			
064	13-S102	ANAEROBIC DIGESTER NO. 3 REHABILITATION SECTIONS AND DETAILS			
065	13-S301	ANAEROBIC DIGESTER NO. 3 REHABILITATION SECTIONS			
066	13-S501	ANAEROBIC DIGESTER PIPE SUPPORT NO. 3 REHABILITATION DETAIL AND SECTION			
067	13-S502	ANAEROBIC DIGESTER PIPE SUPPORT NO.3 REHABILITATION DETAIL			
068	13-P101	OVERALL ANAEROBIC DIGESTION REHABILITATION PLAN			
069	13-P102	ANAEROBIC DIGESTER NO. 3 IMPROVEMENTS LOWER PLAN			
070	13-P103	ANAEROBIC DIGESTER NO. 3 IMPROVEMENTS UPPER PLAN			
071	13-P301	ANAEROBIC DIGESTER NO. 3 DIGESTER MIXING SECTIONS AND DETAILS			
072	13-P302	ANAEROBIC DIGESTER NO. 3 DIGESTED SLUDGE TRANSFER BOX SECTION AND DETAILS			
073	13-P303	ANAEROBIC DIGESTER NO. 3 DIGESTER BIOGAS HANDLING SECTION			
074	13-P901	ANAEROBIC DIGESTER NO. 3 DIGESTER MIXING ISOMETRICS			
075	13-P902	ANAEROBIC DIGESTER NO. 3 DIGESTER COVER BIOGAS PIPING ISOMETRIC			

20 - DIGESTER CONTROL BUILDING IMPROVEMENTS					
SHEET	DWG.				
NO.	NO.	DESCRIPTION			
076	20-X101	DIGESTER CONTROL BUILDING SELECTIVE DEMOLITION ROOF PLAN			
077	20-S401	DIGESTER CONTROL BUILDING SECTION AND DETAIL			
078	20-S501	DIGESTER CONTROL BUILDING DETAILS			
079	20-P101	DIGESTER CONTROL BUILDING ROOF PLAN			
080	20-P301	DIGESTER CONTROL BUILDING SECTIONS AND DETAILS 1			
081	20-P302	DIGESTER CONTROL BUILDING SECTIONS AND DETAILS 2			
082	20-P901	DIGESTER CONTROL BUILDING ISOMETRIC			
083	20-M101	ELECTRICAL ROOM HVAC PLAN			
084	20-E101	DIGESTER CONTROL BUILDING ELECTRICAL ROOM DEMOLITION			
085	20-E102	DIGESTER CONTROL BUILDING LOWER LEVEL ELECTRICAL IMPROVEMENTS			
086	20-E601	DIGESTER CONTROL BUILDING - MCC CONTROL SCHEMATIC 1			
087	20-E602	DIGESTER CONTROL BUILDING - MCC CONTROL SCHEMATIC 2			

35 - DIGESTER GAS SCRUBBER IMPROVEMENTS				
SHEET DWG.				
NO.	NO.	DESCRIPTION		
088	35-X101	DIGESTER GAS SCRUBBER DEMOLITION PLAN		
089	35-S101	DIGESTER GAS SCRUBBER SLAB PLAN		
090	35-S301	DIGESTER GAS SCRUBBER SLAB SECTIONS		
091	35-P101	DIGESTER GAS SCRUBBER OVERALL PLAN		
092	35-P301	DIGESTER GAS SCRUBBER SECTIONS		
093	35-P901	DIGESTER GAS SCRUBBER ISOMETRIC		
094	35-E101	DIGESTER GAS SCRUBBER ELECTRICAL PLAN		

CUEET	DIMO	0 - NORTH AERATION BASINS IMPROVEMENTS
SHEET NO.	DWG. NO.	DESCRIPTION
095	40-X101	NORTH AERATION BASINS - DEMOLITION PLAN 1
096	40-X102	NORTH AERATION BASINS - DEMOLITION PLAN 2
097	40-X301	NORTH AERATION BASINS - DEMOLITION SECTIONS AND DETAILS 1
098	40-X302	NORTH AERATION BASINS - DEMOLITION SECTIONS AND DETAILS 2
099	40-X303	NORTH AERATION BASINS - DEMOLITION SECTIONS AND DETAILS 3
100	40-S101	NORTH AERATION BASINS - OVERALL STRUCTURAL PLAN
101	40-S401	NORTH AERATION BASINS - BLOWER PIPING BRIDGE SECTIONS AND DETAILS 1
102	40-S402	NORTH AERATION BASINS - BLOWER PIPING BRIDGE SECTIONS AND DETAILS 2
103	40-S403	NORTH AERATION BASINS - BLOWER PIPING BRIDGE SECTIONS AND DETAILS 3
104	40-S404	NORTH AERATION BASINS - BLOWER PIPING BRIDGE SECTIONS AND DETAILS 4
105	40-S405	NORTH AERATION BASINS - BLOWER PIPING BRIDGE SECTIONS AND DETAILS 5
106	40-S406	NORTH AERATION BASINS - BLOWER PIPING BRIDGE SECTIONS AND DETAILS 6
107	40-S407	NORTH AERATION BASINS - BLOWER PIPING BRIDGE SECTIONS AND DETAILS 7
108	40-S408	NORTH AERATION BASINS - BLOWER PIPING SUPPORT DETAILS 1
109	40-S409	NORTH AERATION BASINS - BLOWER PIPING SUPPORT DETAILS 2
110	40-S410	NORTH AERATION BASINS - BLOWER PIPING SUPPORT DETAILS 3
111	40-S411	NORTH AERATION BASINS - BLOWER PIPING SUPPORT DETAILS 4
112	40-S412	NORTH AERATION BASINS - BLOWER PIPING SUPPORT DETAILS 5
113	40-S413	NORTH AERATION BASINS - BLOWER PIPING SUPPORT DETAILS 6
114	40-S414	NORTH AERATION BASINS - BLOWER BUILDING DETAILS 1
115	40-S415	NORTH AERATION BASINS - BLOWER BUILDING DETAILS 2
116	40-S416	NORTH AERATION BASINS - BLOWER BUILDING DETAILS 3
117	40-S417	NORTH AERATION BASINS - BLOWER BUILDING DETAILS 4
118	40-S418	NORTH AERATION BASINS - BLOWER BUILDING DETAILS 5
119	40-P101	NORTH AERATION BASINS - BLOWER PIPING OVERALL PLAN
120	40-P102	NORTH AERATION BASIN IMPROVEMENTS - ENLARGED PLAN
121	40-P301	NORTH AERATION BASINS - BLOWER PIPING SECTIONS AND DETAILS 1
122	40-P302	NORTH AERATION BASINS - BLOWER PIPING SECTIONS AND DETAILS 2
123	40-P303	NORTH AERATION BASINS - BLOWER PIPING SECTIONS AND DETAILS 3
124	40-P901	NORTH AERATION BASINS - BLOWER PIPING ISOMETRIC VIEW OVERALL
125	40-P902	NORTH AERATION BASINS - BLOWER PIPING ISOMETRIC VIEWS
126	40-E101	NORTH AERATION BASINS - ELECTRICAL SITE PLAN
127	40-E102	FLOW METER RELOCATION/ INSTALLATION

	90 - ELECTRICAL				
SHEET	DWG.				
NO.	NO.	DESCRIPTION			
128	90-E501	ANAEROBIC DIGESTION EXISTING ONELINE DIAGRAM			
129	90-E502	ANAEROBIC DIGESTION ONELINE DIAGRAM MODIFICATION			
130	90-E701	20CP1 PLC I/O			

INDEX OF DRAWINGS JOB NO.: 19W10160

DATE: JAN. 2024 DESIGNED BY: RWC DRAWN BY: SAC CHECKED BY: RDT

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SHEET **002**

DRAWING NUMBER EXAMPLE G – GENERAL C – CIVIL - INSTRUMENTATION PREDOMINATE FACILITY —/ AREA CODE & CONTROL VIEW OR X – DEMOLITION **ELEMENT** ☐ DISCIPLINE F - FIRE & LIFE SAFETY T - TELECOMMUNICATIONS

A – ARCHITECTURAL S – STRUCTURAL P – PROCESS MECHANICAL 200 – GRADING & PAVING 200 – ELEVATIONS

E – ELECTRICAL

M – BUILDING MECHANICAL 300 – PIPING & PROFILES 300 – SECTIONS


CIVIL DISCIPLINE OTHER DISCIPLINES 100 – SITE PLANS

DRAWING NUMBER LEGEND

100 - PLAN VIEWS

400 – LARGE SCALE VIEWS 500 - DETAILS 600 – DIAGRAM OR SCHED 900 - ISOMETRICS

ALL DISCIPLINES

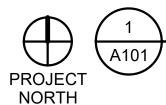

SCALE: 1/8" = 1'-0"

TITLE DENOTES A PLAN VIEW LAYOUT (THIS EXAMPLE IS PLAN VIEW No. 1 ON SHEET A101)


TITLE SCALE: 1/8" = 1'-0" A101 A201

TITLE DENOTES AN ELEVATION, SECTION, OR DETAIL VIEW LAYOUT (THIS EXAMPLE IS DETAIL 1 ON SHEET A201 WHICH HAS A BACK REFERENCE ON SHEET A101)

CALLOUT DENOTES A CUT SECTION TYPICAL REFERENCE (THIS EXAMPLE OCCURS ON SHEET A101 A201 A101 REFERENCING SECTION No. 1 ON SHEET A201)



REFERENCE (THIS EXAMPLE OCCURS ON SHEET A101 REFERENCING ELEVATION No. 1 ON SHEET A201)

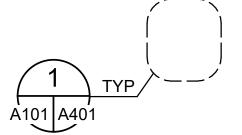

CALLOUT DENOTES AN ENLARGED AREA

CALLOUT DENOTES AN ELEVATION

TYPICAL REFERENCE (THIS EXAMPLE OCCURS ON SHEET A101 REFERENCING DETAIL No. 1 ON SHEET A401)



CALLOUT DENOTES A STANDARD DETAIL REFERENCE



CALLOUT DENOTES A KEYED NOTE REFERENCE




CLOUDED REGION INDICATES A REVISED AREA

ROOM NAME 101

150 SF

SYMBOL INDICATES A ROOM / AREA DESIGNATION WITH ROOM NUMBER AND SQUARE FOOTAGE

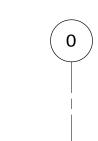

SYMBOL INDICATES A STRUCTURAL GRIDLINE OR DATUM

1ST FLOOR EL. 602.50

SYMBOL INDICATES A DATUM IN A **SECTION OR ELEVATION**

ABBREV DESCRIPTION ABV ABOVE AFF ABOVE FINISHED FLOOR ANSI AMERICAN NATIONAL STANDARDS INSTITUTE ASTM AMERICAN SOCIETY OF TESTING AND MATERIALS AUX AUXILIARY AMERICAN WATER WORKS AWWA ASSOCIATION BKR BREAKER BOP **BOTTOM OF PIPE** BOS BOTTOM OF STRUCTURE CI CONTRACTOR INSTALLED CJ **CONSTRUCTION JOINT** CKT CIRCUIT CL CENTERLINE CMU CONCRETE MASONRY UNIT COGEN COMBINED HEAT AND POWER **GENERATION** COL COLUMN CONT CONTINUOUS DG DIGESTER GAS DIA DIAMETER EΑ EXHAUST AIR, EXPANSION ANCHOR, EACH EL, ELEV ELEVATION **ELEC ELECTRICAL ENCL ENCLOSURE** FA FIRE ALARM FFE FINISHED FLOOR ELEVATION FL FLOW LINE FLR **FLOOR** FRP FIBERGLASS REINFORCED PLASTIC FT FEET, FOOT GΑ GAUGE, GAGE GALV GALVANIZED WT GFI. GFCI GROUND FAULT CIRCUIT XMFR INTERRUPTER GRND GROUND H, HT HEIGHT HAND-OFF-AUTOMATIC HORIZONTAL HP HORSEPOWER, HEAT PUMP HYDRANT HYD ID INSIDE DIAMETER **INVERT ELEVATION** kVA KILOVOLT-AMPERES kW KILOWATTS LBS, # POUNDS LF LINEAR FEET MAX MAXIMUM NOT AVAILABLE N/A NATIONAL FIRE PROTECTION NFPA ASSOCIATION NIC NOT IN CONTRACT NTS NOT TO SCALE OC ON CENTER OVERHEAD OH

OCCUPATIONAL SAFETY & HEALTH ADMINISTRATION

POST INDICATOR VALVE

PRESSURE RELIEF VALVE

POUNDS PER SQUARE FOOT

PROCESS DRAIN

PANEL

ABBREVIATIONS

OSHA

PD

PIV

PNL

PRV

PSF

	<u>ABBREV</u>	DESCRIPTION
	PSI	POUNDS PER SQUARE INCH
	PSIA	POUNDS PER SQUARE INCH ABSOLUTE
2	PSIG	POUNDS PER SQUARE INCH GAUGE
	PVC	POLYVINYL CHLORIDE
	RE:	REFERENCE, REFER
	REINF	
	REQD	REQUIRED
	RM	ROOM
	SEC	SECTION
	SF	SQUARE FEET
	SHT	SHEET
	SPEC	SPECIFICATIONS
	SQ	SQUARE
	STA	STATION
	STD	STANDARD
	SURF	SURFACE
	SUSP	SUSPEND, SUSPENDED
	T&B	TOP AND BOTTOM
	THRU	THROUGH
	TYP	TYPICAL
	U/F	UNDER FLOOR
	U/G	UNDER GROUND
	U/S	UNDER SLAB
	UL	UNDERWRITERS LABORATORIES, INC.
	UNO	UNLESS NOTED OTHERWISE
	V	VOLT, VALVE
	VA	VOLT-AMPERE
	VERT	VERTICAL
	W	WATT, WIRE, WIDTH, WINDOW, WATER
	W/	WITH
	W/O	WITHOUT
	WS	WATERSTOP
	\	WATERTICUT WEIGHT

WATERTIGHT, WEIGHT

TRANSFORMER

ABBREVIATIONS



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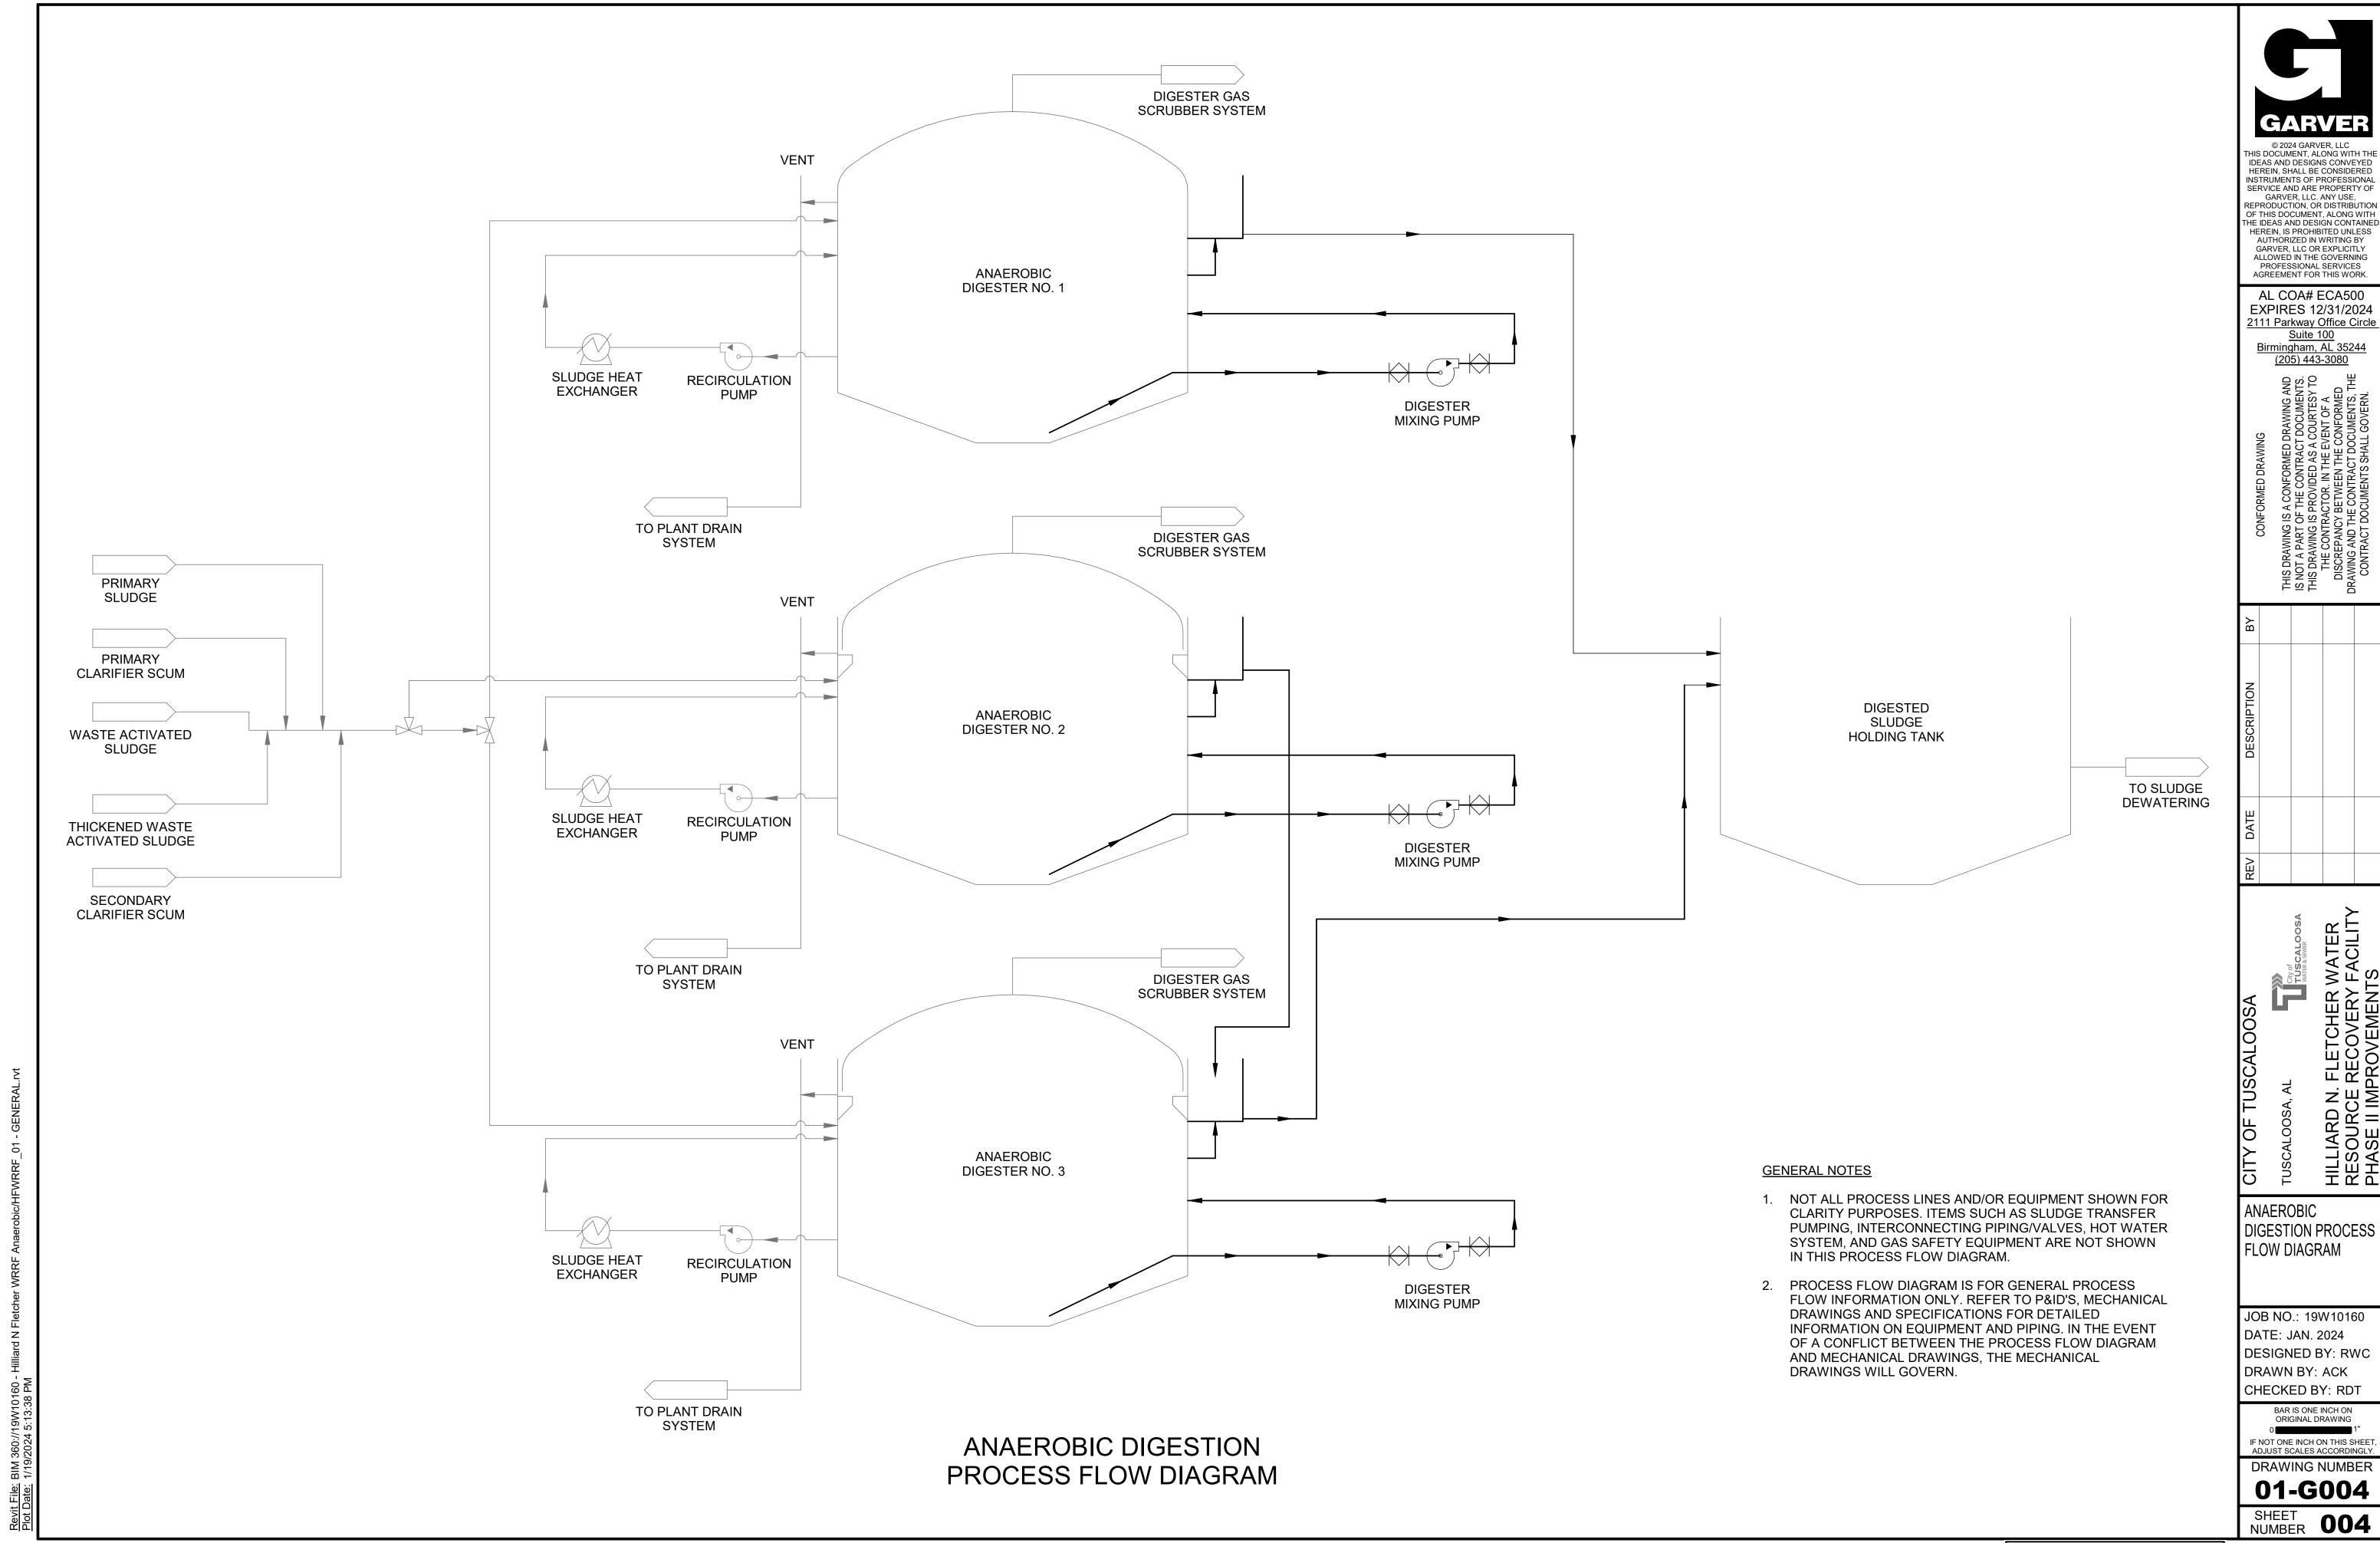
JOB NO.: 19W10160 DATE: JAN. 2024 DESIGNED BY: RWC DRAWN BY: SAC CHECKED BY: RDT


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NUMBER 003

01-G003





BIOGAS SYSTEM PROCESS FLOW DIAGRAM

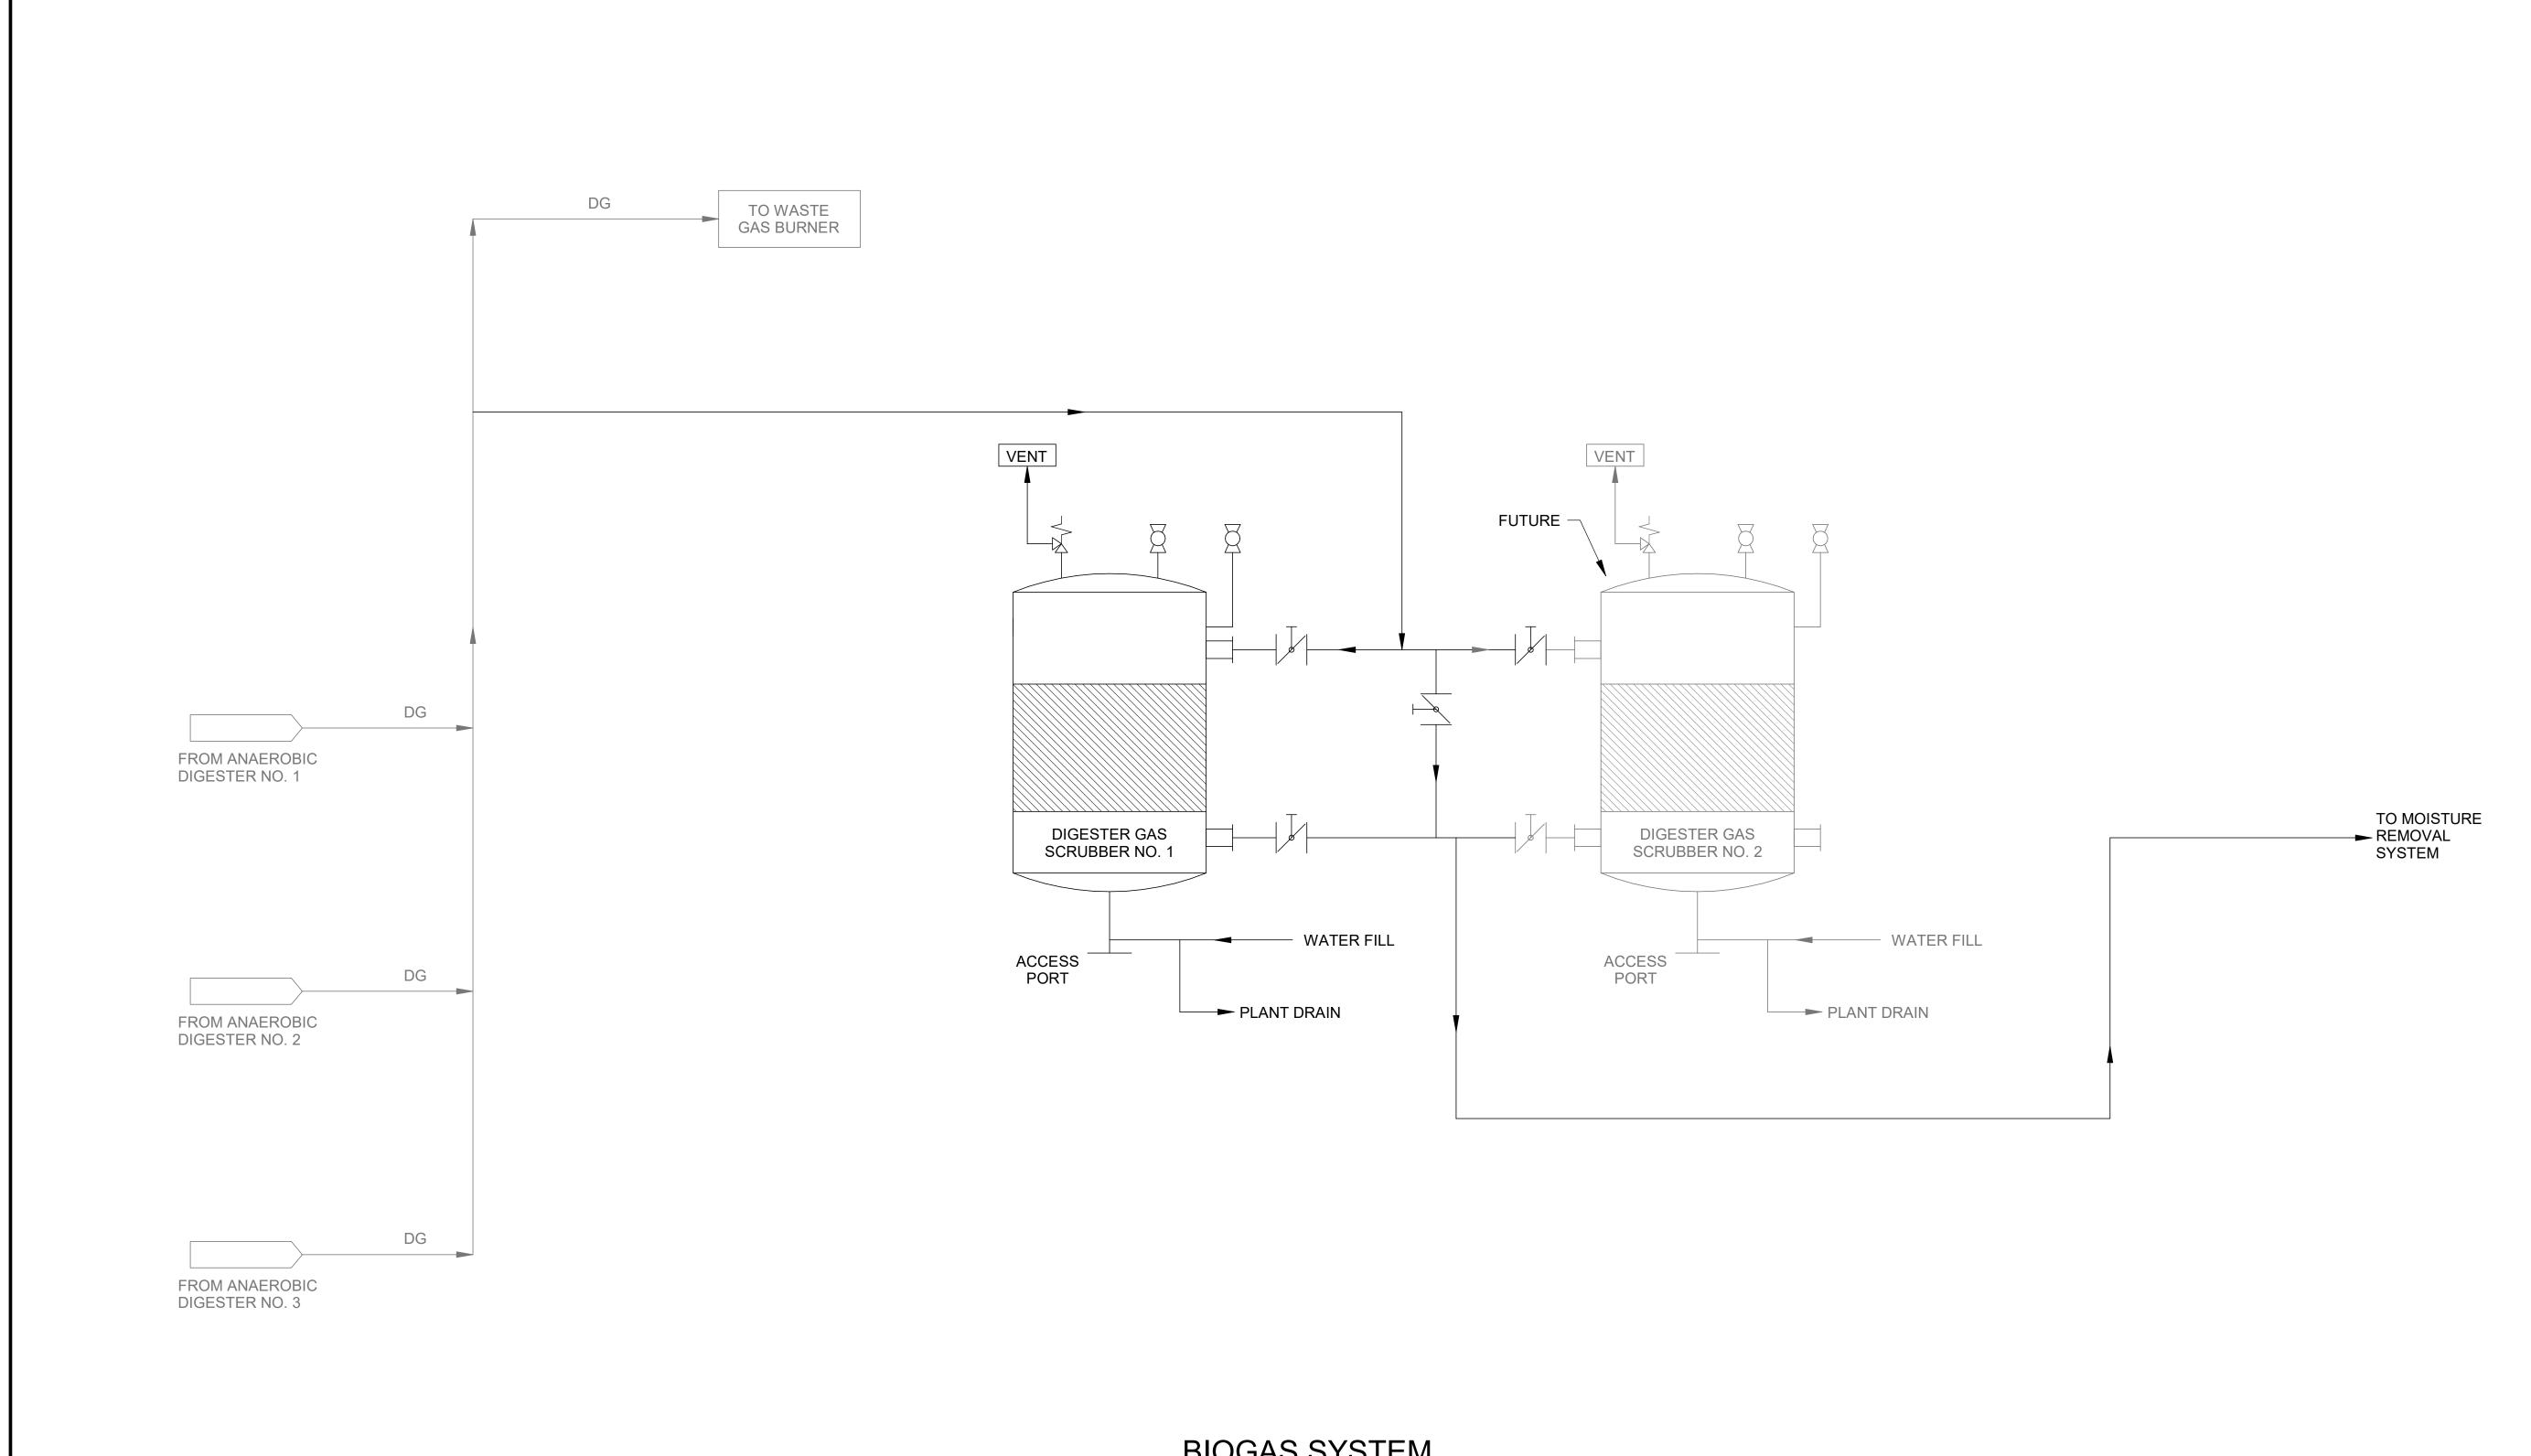GENERAL NOTES

- NOT ALL PROCESS LINES AND/OR EQUIPMENT SHOWN FOR CLARITY PURPOSES. ITEMS SUCH AS SLUDGE TRANSFER PUMPING, INTERCONNECTING PIPING/VALVES, HOT WATER SYSTEM, AND GAS SAFETY EQUIPMENT ARE NOT SHOWN IN THIS PROCESS FLOW DIAGRAM.
- 2. PROCESS FLOW DIAGRAM IS FOR GENERAL PROCESS FLOW INFORMATION ONLY. REFER TO P&ID'S, MECHANICAL DRAWINGS AND SPECIFICATIONS FOR DETAILED INFORMATION ON EQUIPMENT AND PIPING. IN THE EVENT OF A CONFLICT BETWEEN THE PROCESS FLOW DIAGRAM AND MECHANICAL DRAWINGS, THE MECHANICAL DRAWINGS WILL GOVERN.

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REV DATE DESCRIPTION BY

USCALOOSA, AL

ILLIARD N. FLETCHER WATE
RESOURCE RECOVERY FACIL

BIOGAS SYSTEM PROCESS FLOW DIAGRAM

JOB NO.: 19W10160 DATE: JAN. 2024 DESIGNED BY: RWC DRAWN BY: KLB CHECKED BY: RDT

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01-G005
SHEET 005

- 2. THE CONTRACTOR SHALL BE RESPONSIBLE FOR CONTACTING ALABAMA ONE CALL AND ALL APPROPRIATE AGENCIES BEFORE WORK COMMENCES TO VERIFY THE TYPE, LOCATION, PROTECTION REQUIREMENTS, DEPTH OF ALL EXISTING UTILITIES, DRAINAGE FACILITIES, AND OTHER OBSTRUCTIONS. CONTRACTOR SHALL BE RESPONSIBLE FOR ALL COSTS ASSOCIATED WITH REPAIRING AND/OR REPLACING ANY SUCH ITEMS DAMAGED DURING CONSTRUCTION.
- 3. CAUTION: UNDERGROUND UTILITIES SHOWN ARE TAKEN FROM EXISTING RECORDS AND ARE SHOWN FOR THE CONVENIENCE OF THE CONTRACTOR ONLY. THE CONTRACTOR SHALL CONTACT ALL UTILITY OWNERS AND CONFIRM LOCATIONS OF UTILITIES AT LEAST 48 HOURS BEFORE BEGINNING CONSTRUCTION. THE CONTRACTOR SHALL ACCURATELY LOCATE AND UNCOVER ALL EXISTING UTILITIES BEFORE BEGINNING CONSTRUCTION. ANY DAMAGE RESULTING FROM THE CONTRACTOR'S OPERATIONS SHALL BE REPAIRED AT THE CONTRACTOR'S EXPENSE. WHERE CROSSING OF EXISTING UTILITIES OCCUR, PROVIDE 12" MINIMUM CLEARANCE EXCEPT WATER MAINS SHALL BE 24". CROSS UNDER ALL WATER MAINS WHERE NOT POSSIBLE TO PROVIDE 18" CLEARANCE.
- 4. SEWER AND WATER SERVICE SHALL BE MAINTAINED DURING ENTIRE CONSTRUCTION PERIOD OR TEMPORARY FACILITIES PROVIDED.
- 5. CONTRACTOR IS RESPONSIBLE FOR ALL DEWATERING ACTIVITIES AND ASSOCIATED PERMITS REQUIRED FOR ALL EXCAVATIONS REQUIRED TO COMPLETE THE PROJECT.
- 6. APPROXIMATE LOCATIONS OF OVERHEAD POWER LINES MAY OR MAY NOT BE SHOWN ON PLANS. CONTRACTOR SHALL BE SOLELY RESPONSIBLE FOR VERIFYING ALL LOCATIONS IN THE FIELD AND PLAN WORK IN THESE AREAS ACCORDINGLY.
- 7. CONTRACTOR SHALL BE RESPONSIBLE FOR SITE DRAINAGE AND COMPLIANCE WITH ALL GOVERNMENTAL STORM WATER REGULATIONS AND PERMITS (SWPPP) AS REQUIRED. CONTRACTOR SHALL OBTAIN NOTICE OF INTENT (NOI) FROM APPROPRIATE STATE BODY PRIOR TO ANY CONSTRUCTION. CONTRACTOR SHALL BE RESPONSIBLE FOR ANY PERMITS REQUIRED FOR WORK WITHIN STREAMS.
- 8. IT SHALL BE THE CONTRACTOR'S SOLE RESPONSIBILITY TO PROVIDE TRAFFIC CONTROL AND SIGNAGE FOR THE DURATION OF PROJECT AS REQUIRED BY THE NATIONAL MANUAL ON UNIFORM TRAFFIC CONTROL DEVICES -PART VI, AND/OR ALL OTHER APPLICABLE GUIDELINES OF ALDOT, COUNTY, CITY OR ANY OTHER AUTHORITIES HAVING JURISDICTION OVER THE PROJECT AREAS. ALL ROAD CLOSURE MUST BE APPROVED BY THE CITY OF TUSCALOOSA TRAFFIC ENGINEER PRIOR TO ANY PUBLIC ROAD CLOSURES.
- 9. CONTRACTOR SHALL MAINTAIN TRAFFIC FLOW TO RESIDENCES AND BUSINESSES WITH MINIMUM DISRUPTION OF ACCESS.
- 10. ALL STREETS AND DRIVEWAYS SHALL BE OPEN CUT UNLESS NOTED OTHERWISE. CONTRACTOR MAY REQUEST HORIZONTAL DIRECTION DRILLING ON A CASE-BY-CASE BASIS.
- 11. ALL EXCAVATION BACKFILL OUTSIDE TRAFFIC WAYS SHALL BE COMPACTED TO MIN 95% STANDARD PROCTOR DENSITY TO PREVENT SETTLEMENT. PAVING AND GRADING NOTES
- 1. ALL PAVING MATERIALS AND CONSTRUCTION SHALL MEET THE ALDOT STANDARD SPECIFICATIONS UNLESS OTHERWISE NOTED.
- 2. ANY PAVEMENT DAMAGED DURING CONSTRUCTION SHALL BE REPAIRED TO EQUAL OR BETTER CONDITION AT THE CONTRACTORS EXPENSE.
- 3. ANY DISTURBED AREAS NOT SPECIFICALLY DESIGNATED TO BE GRADED SHALL BE RESTORED TO EQUAL OR BETTER CONDITION AND SHALL BE GRADED TO DRAIN AS APPROVED BY THE ENGINEER.
- 4. FINAL PAVEMENT SURFACES SHALL NOT BE PLACED UNTIL ALL MAJOR CONSTRUCTION ACTIVITIES HAVE CONCLUDED.
- 5. ANY CHANGES TO FINAL GRADE ELEVATIONS AS SHOWN ON THE PLANS SHALL BE APPROVED BY THE ENGINEER.
- 6. ALL ASPHALT AND CONCRETE PAVING REMOVED AND REPLACED SHALL BE NEAT FULL DEPTH SAW CUT.
- 7. ALL OPEN CUT TRAFFIC WAYS (ROADS, PARKING LOTS, DRIVES, ETC.) AND ALL AREAS LYING WITHIN PRISM OF TRAFFIC WAYS, SHALL HAVE CRUSHED STONE BACKFILL COMPACTED WITH VIBRATORY COMPACTOR MAXIMUM 6" LIFTS AND COMPACTED TO MINIMUM 100%-98% MODIFIED PROCTOR DENSITY TO PREVENT SETTLEMENT FOR ITS ENTIRE TRENCH HEIGHT AND WIDTH. COMPACTED "PUG-MIX "SHALL BE USED AND MAINTAINED IN TOP 12" OF TRENCH HEIGHT AS REQUIRED TO PREVENT AGGREGATE LOSS DUE TO TRAFFIC.

YARD PIPING NOTES

- . MINIMUM COVER OVER PIPING SHALL BE 3'-0", MEASURED FROM FINISHED GRADE.
- 2. PROVIDE MINIMUM PIPE COVER, AS SPECIFIED. IN GENERAL LAY PIPE TO UNIFORM GRADES BETWEEN THE ELEVATIONS SHOWN, UNLESS OTHERWISE APPROVED. IN SOME CASES, EXISTING CONDITIONS PROHIBIT UNIFORM GRADES BETWEEN THE ELEVATIONS SHOWN, AND FIELD ADJUSTMENTS TO UNIFORM GRADES ARE REQUIRED AS APPROVED BY ENGINEER.
- 3. SIZE OF FITTINGS SHOWN ON PLANS SHALL CORRESPOND TO ADJACENT STRAIGHT RUN OF PIPE, UNLESS OTHERWISE INDICATED. TYPE OF JOINT AND FITTING MATERIAL SHALL BE AS SPECIFIED FOR ADJACENT STRAIGHT RUN OF PIPE.
- 4. ALL JOINTS SHALL BE WATERTIGHT.
- 5. THRUST AT FITTINGS SHALL BE RESISTED BY RESTRAINED JOINTS AS SPECIFIED AND AS REQUIRED TO RESIST THRUST, UNLESS OTHERWISE APPROVED BY ENGINEER. SEE THRUST RESTRAINT DETAILS .
- CONTRACTOR SHALL LOCATE AND UNCOVER ALL CONNECTIONS TO EXISTING LINES, AND ANY POSSIBLE CONFLICTS WITH PROPOSED FACILITIES AND VERIFY LOCATION, ELEVATION, PIPE MATERIAL, AND PIPE O.D. PRIOR TO ANY CONSTRUCTION.
- 7. CONTRACTOR SHALL MAINTAIN AND PROTECT ALL EXISTING BURIED PIPING AND UTILITIES. THE CONTRACTOR IS RESPONSIBLE FOR REPAIRING ANY DAMAGED UNDERGROUND FACILITIES AT THEIR OWN EXPENSE.
- ALL SMALL DIAMETER PIPING SHALL BE INSTALLED AS SHOWN ON DRAWINGS WITH ALL FITTINGS AND VALVES AS REQUIRED TO PROVIDE A FUNCTIONAL PIPELINE AS SPECIFIED.
- 9. ALL BURIED VALVES SHALL BE INSTALLED WITH VALVE BOX AND VALVE PAD AS SPECIFIED.
- 10. ALL PIPELINE SHUTDOWNS SHALL BE COORDINATED WITH THE OPERATORS. A WRITTEN WORK PLAN SHALL BE SUBMITTED AND APPROVED BY THE ENGINEER AND CITY 24 HOURS PRIOR TO ANY SHUTDOWNS.
- 11. ROCK SHALL BE UNDERCUT A MINIMUM OF 4" AND PIPE BEDDED PER SEPCIFICATIONS. NO SEPARATE PAY ITEM EXISTS FOR ROCK EXCAVATION. ALL EXCAVATION SHALL BE CONSIDERED TO BE UN-CLASSIFIED EXCAVATION AND SUBSIDIARY TO OTHER BID ITEMS.
- 12. CONTRACTOR SHALL BE RESPONSIBLE FOR THE PROPER DISPOSAL OF THE EXISTING PIPE, EXISTING MANHOLES, AND ANY EXCESS MATERIALS RESULTING FROM THE WORK.
- 13. WHERE BYPASS PUMPING IS REQUIRED DURING THE PROJECT, PUMPING SHALL BE HELD TO A MINIMUM. ROUND-THE-CLOCK BYPASS PUMPING IS NOT ALLOWED. AT END OF EACH DAYLIGHT CONSTRUCTION PERIOD, EXISTING WATER WILL BE TEMPORARILY ROUTED TO NEW OR EXISTING PIPES WITH FITTINGS, PIPE, HOSE, OR OTHER APPURTENANCES AS REQUIRED AND DITCH LINES SHALL BE BACKFILLED TO EXISTING GRADE. COST OF THIS WORK SHALL BE INCLUDED IN PIPE INSTALLATION UNLESS LISTED AS A SEPARATE BID ITEM.
- 14. CONTRACTOR SHALL PREVENT STORM WATER AND DEBRIS FROM ENTERING PIPES AND MANHOLES AT ALL TIMES. ALL PIPES AND MANHOLES SHALL BE SECURELY PLUGGED AT THE END OF EACH DAY.

			ABBREVIATIONS		
ABBREV	DESCRIPTION	ABBREV	DESCRIPTION	ABBREV	DESCRIPTION
ABDN	ABANDON	LT	LEFT	V	VOLT, VALVE
AC	ACRE	MANUF	MANUFACTURER	VC	VERTICAL CURVE
AFF	ABOVE FINISHED FLOOR	MAX	MAXIMUM	VERT	VERTICAL
ALUM	ALUMINUM SULFATE	MGD	MILLION GALLONS PER DAY	VPI	VERTICAL POINT OF INTERSECTION
APPROX	APPROXIMATE	MH	MANHOLE	VT	VENTILATOR
ASPH ASSY	ASPHALT ASSEMBLY	MIN MISC	MINIMUM MISCELLANEOUS	W W/	WIDTH, WATER WITH
BC	BACK OF CURB	MJ	MECHANICAL JOINT	W/O	WITHOUT
BLDG	BUILDING	N	NORTH	WL	WATER LINE
BLK	BLOCK	NE	NORTHEAST	WSL	WATER SERVICE LINE
BM	BENCHMARK	NG	NATURAL GAS	WS	WATERSTOP
B, BOT	BOTTOM	NW	NORTHWEST	WTM	WATER TRANSMISSION MAIN
BOP	BEGINNING OF VERTICAL CURVE	NIC	NOT IN CONTRACT	WWF	WELDED WIRE FABRIC
BVCS	BEGINNING OF VERTICAL CURVE STATION	NO,# NOI	NUMBER NOTICE OF INTENT	Χ	BY
С	CONDUIT	NTS	NOT TO SCALE		
CI	CAST IRON	NWSL	NORMAL WATER SURFACE LEVEL		
CIP	CAST IRON PIPE	OC	ON CENTER		
CJ	CONSTRUCTION JOINT	OD	OUTSIDE DIAMETER		
CMLL	CENTERLINE, CLASS	OVF	OVERFLOW		
CMU CONC	CONCRETE MASONRY UNIT CONCRETE	PC	POINT OF CURVE		
CONN	CONNECTION	PD	PROCESS DRAIN MANUALE		
CONT	CONTINUOUS	PDMH PE	PROCESS DRAIN MANHOLE PLAIN END		
CP	CONTROL POINT	PI	POINT OF INTERSECTION		
CPB	CHEMICAL PULL BOX	PL, PLS	PLATE, PLACES		
CSL	CHEMICAL SAMPLE LINE,	PO	PUSH ON		
DA	CHLORINE SOLUTION	PP	POWER POLE		
DA DI	DRAINAGE AREA DUCTILE IRON	PRC	POINT OF REVERSE CURVE		
DIA	DIAMETER	PROP	PROPOSED		
DIP	DUCTILE IRON PIPE	PSI	POUNDS PER SQUARE INCH		
EA	EACH	PT	POINT OF TANGENT, POINT		
EC	EDGE OF CONCRETE	PVC PVI	POLYVINYL CHLORIDE POINT OF VERTICAL INTERSECTION		
EFF	EFFLUENT	R, RAD	RADIUS		
EG	EDGE OF GRAVEL	RCP	REINFORCED CONCRETE PIPE		
EL, ELEV	ELEVATION	RED	REDUCER		
ELEC	ELECTRICAL PULL BOX	REINF	REINFORCEMENT		
EPB EOP	ELECTRICAL PULLBOX END/EDGE OF PAVEMENT	REQD	REQUIRED		
ESMT	EASEMENT	RJ	RESTRAINED JOINT		
EVCS	END OF VERTICAL CURVE STATION		RIGHT-OF-WAY		
EQ	EQUAL	RP RS	RADIUS POINT RESILIENT SEAT		
EW	EACH WAY	RT	RIGHT		
EX	EXISTING	S	SOUTH, SLUDGE		
EXP	EXPANSION	SCH	SCHEDULE		
FCJ	FLOOR CONSTRUCTION JOINT	SD	STORM DRAIN		
FES FFE	FLARED END SECTION FINISHED FLOOR ELEVATION	SDMH	STORM DRAIN MANHOLE		
FH	FIRE HYDRANT	SE	SOUTHEAST		
	FINISH GRADE	SECT	SECTION		
FL	FLOWLINE	SF SHT	SQUARE FEET, SILT FENCE		
FLG	FLANGED	SL	SHEET SAMPLE LINE		
FRP	FIBERGLASS REINFORCED PIPE	SPC	STANDARD PROCTOR DENSITY		
FT	FEET, FOOT	SPEC	SPECIFICATIONS		
FTG	FOOTING	SQ	SQUARE		
G GL	GUTTER GAS LINE	SS	SANITARY SEWER		
GR	GRADE	SSL	SANITARY SEWER SERVICE LINE		
GV	GATE VALVE	SSMH	SANITARY SEWER MANHOLE		
HDWL	HEADWALL	STA	STATION		
HMA	HOT MIX ASPHALT	SURVIOC	STANDARD SURVEY LOCATED		
HORIZ	HORIZONTAL	SW	SIDEWALK, SOUTHWEST		
HWY	HIGHWAY	T&B	TOP AND BOTTOM		
ID	INSIDE DIAMETER	TBM	TEMPORARY BENCHMARK		
IN	INCHES	TC	TIME CLOCK, TOP OF CURB		
INF INV	INFLUENT INVERT	TEMP	TEMPORARY, TEMPERED		
JT	JOINT	THK	THICKNESS		
LEN	LENGTH	TS	TOP OF SIDEWALK		
LF	LINEAR FEET	TS&V	TAPPING SLEEVE & VALVE		
LG	LONG	TW TYP	TOP OF WALL TYPICAL		
LIN	LINEAL, LINEAR	UNK	UNKNOWN		
LOC	LOCATION	UNO	UNLESS NOTED OTHERWISE		
					ISSUED FOR CONSTRUCTION

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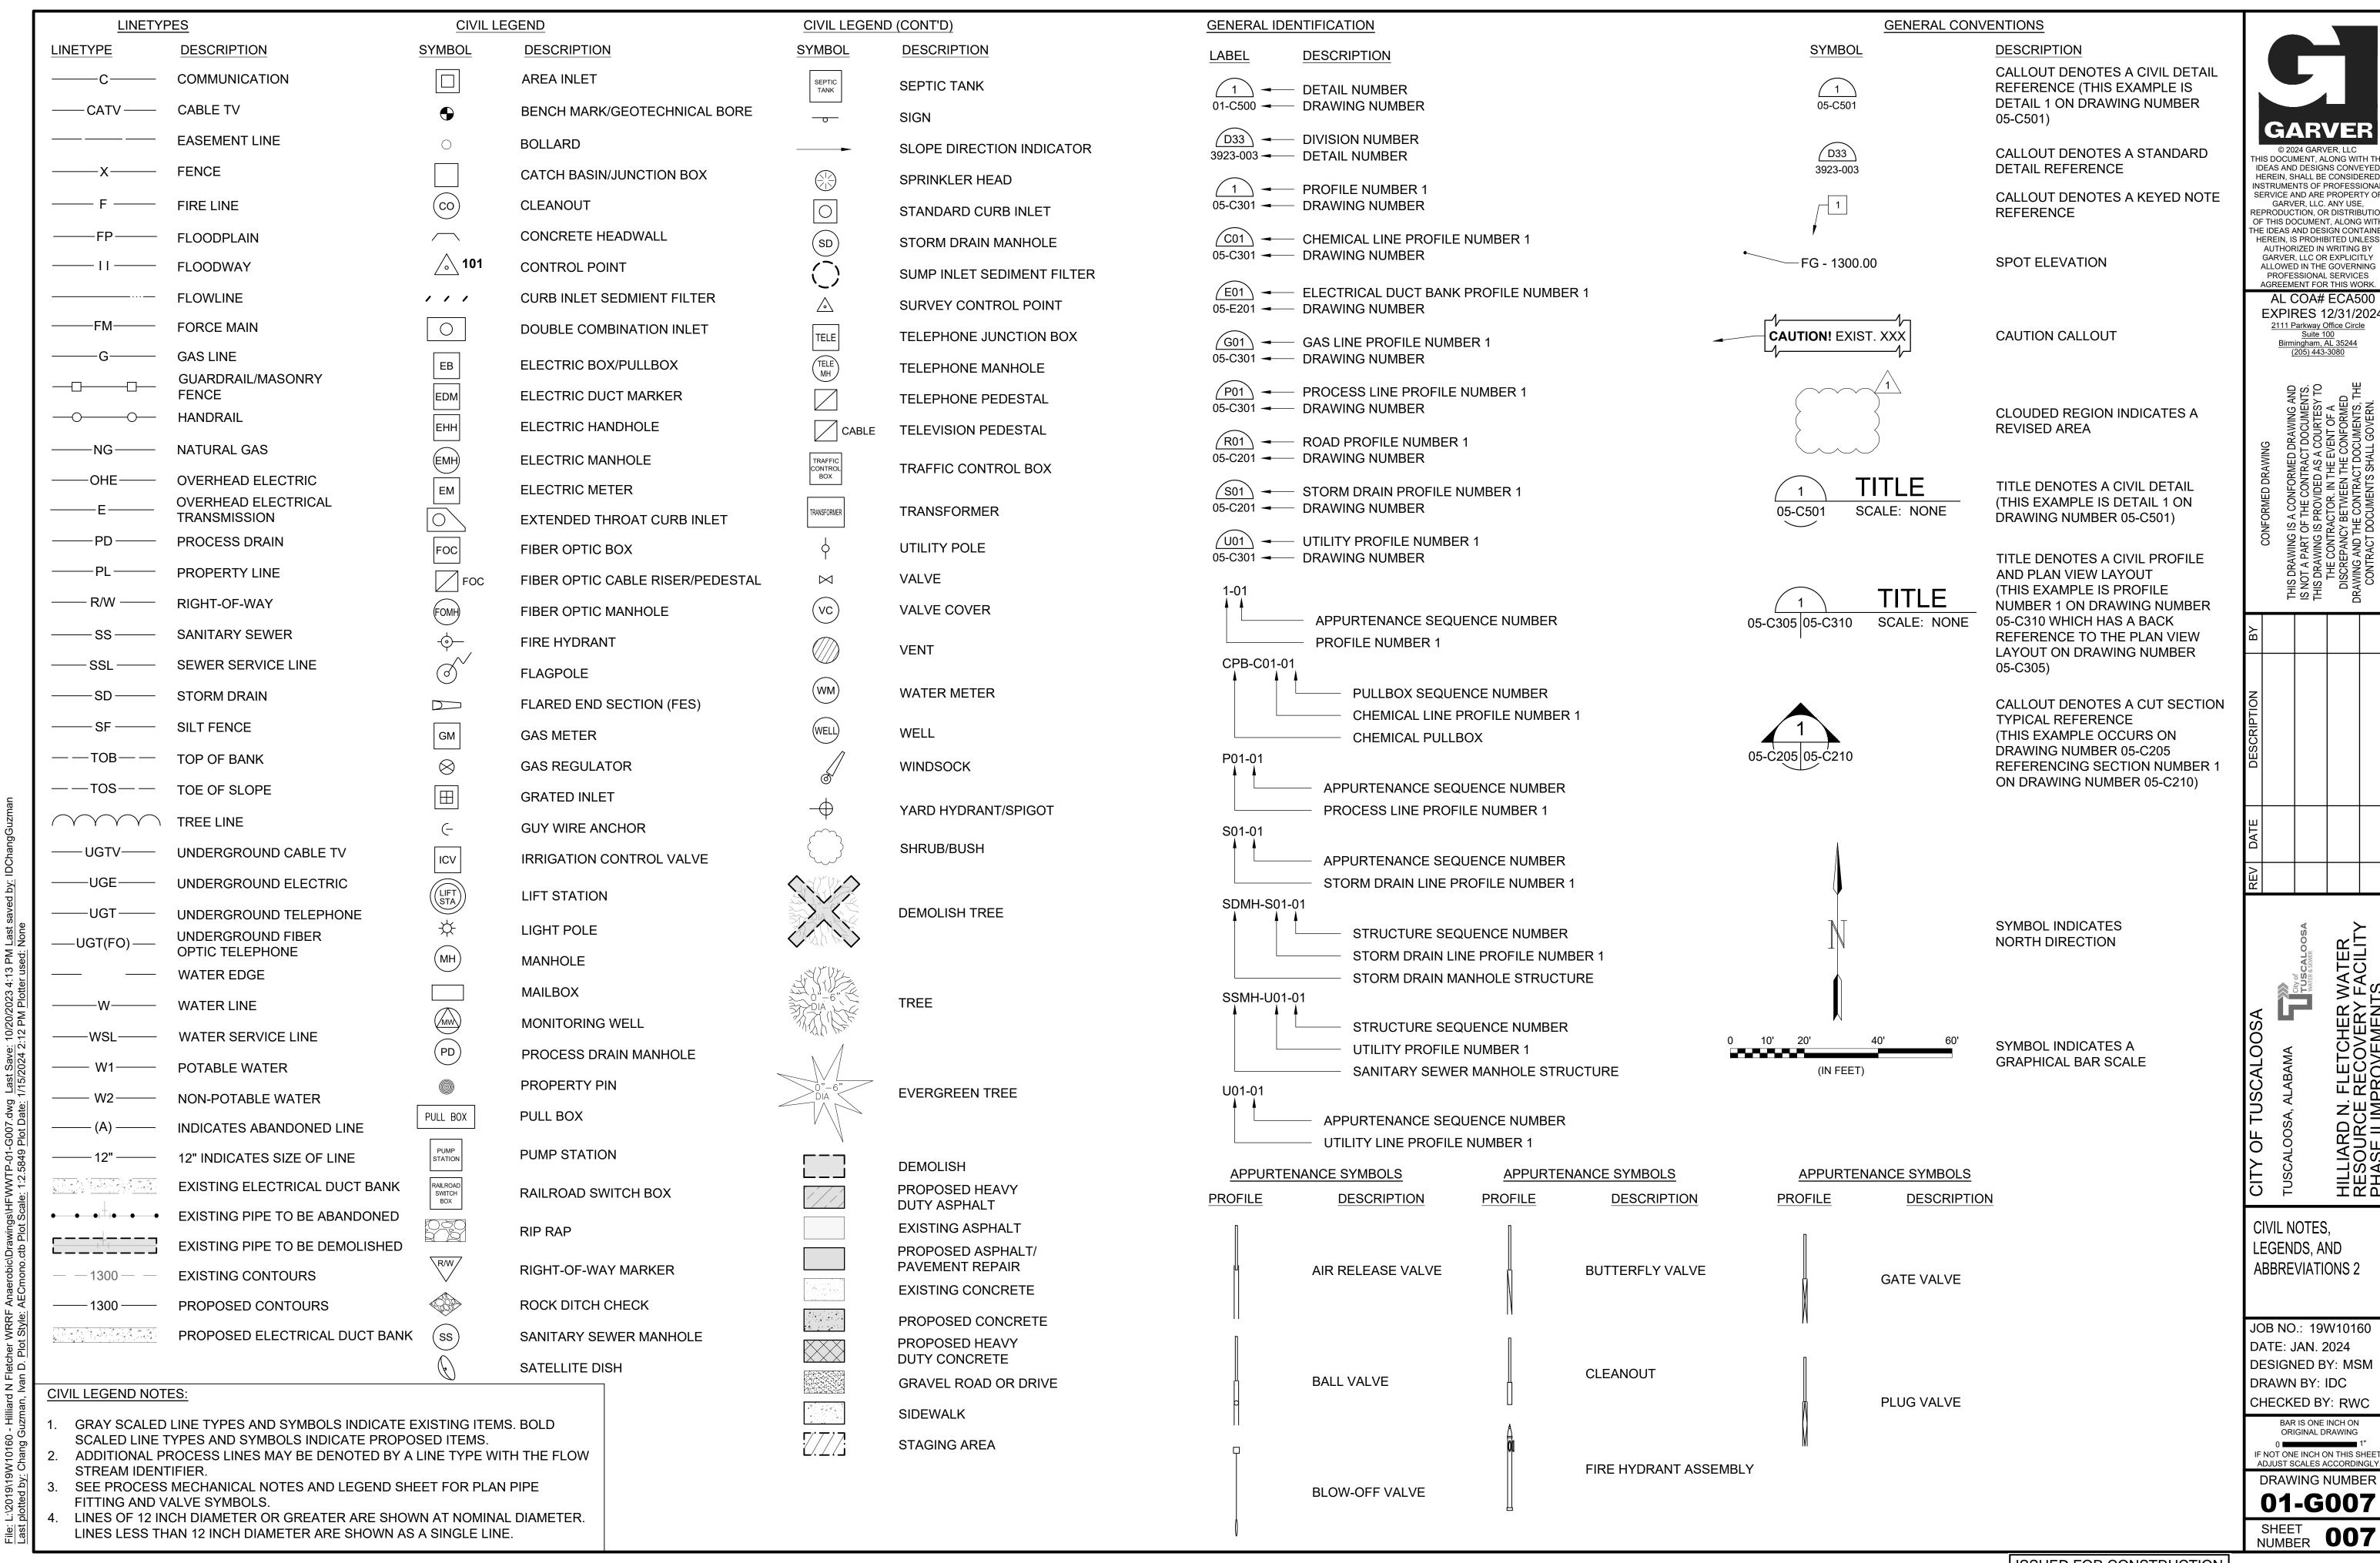
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DIAGRAM NOTES,
LEGENDS, AND
ABBREVIATIONS

ABBREVIATIONS

JOB NO.: 19W10160

DATE: JAN. 2024

DESIGNED BY: SAH

DRAWN BY: SAC

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1"
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- 1. GENERAL NOTES AND STANDARD DETAILS SHALL NOT REPLACE OR OVERRULE ANY STRUCTURE SPECIFIC NOTE, DETAIL, OR SPECIFICATION. STRUCTURE SPECIFIC NOTES AND DETAILS SHALL GOVERN OVER GENERAL NOTES AND STANDARD DETAILS.
- 2. BUILDING RISK CATEGORY----- III

3.	DESIGN LIVE LOADS - 2021 IBC	
	ROOF WITHOUT REDUCTION	25 PSF
	FLOORS:	
	CORRIDORS	100 PSF
	ASSEMBLY AREAS	100 PSF
	BALCONIES	100 PSF
	RESTROOMS	80 PSF
	OFFICES	50 PSF
	STAIRS	100 PSF
	MOVABLE FILE ROOMS	150 PSF
	INDUSTRIAL AREAS	250 PSF
	EQUIPMENT ROOMS	250 PSF
	AREAS WITH UNRESTRICTED VEHICULAR ACCESS	AASHTO H

EXPOSURE FACTOR, C_e ------ 0.90

5.	SEISMIC DESIGN PARAMETERS	-1.25 - D 0.293g 0.102g C 0.306g 0.163g -SEE INDIVIDUAL PLANS
	BASIC SEISMIC FORCE RESISTING SYSTEM	- SEE INDIVIDUAL PLANS - SEE INDIVIDUAL PLANS
6.	SNOW LOADS PARAMETERS	5 PSF

- 7. THE STRUCTURE SHOULD NOT BE CONSIDERED TO BE STABLE DURING CONSTRUCTION UNTIL ALL ELEMENTS ARE IN PLACE AND CONNECTED. THE CONTRACTOR IS RESPONSIBLE FOR DESIGNING ALL TEMPORARY CONSTRUCTION BRACING, AS REQUIRED.
- 3. CONSTRUCTION METHODS, PROCEDURES, AND SEQUENCES ARE THE CONTRACTOR'S RESPONSIBILITY. THE CONTRACTOR SHALL TAKE THE ALL NECESSARY MEANS TO MAINTAIN AND PROTECT THE STRUCTURAL INTEGRITY OF ALL CONSTRUCTION, NEW AND EXISTING, AT ALL STAGES.
- 9. CONTRACTOR SHALL FIELD VERIFY ALL EXISTING DIMENSIONS AND CONDITIONS PRIOR TO ANY PERTINENT WORK. ALL EXISTING CONDITIONS AND DIMENSIONS SHALL BE NOTED ON THE SHOP DRAWINGS.
- 10. COORDINATE WITH THE ARCHITECTURAL, CIVIL, MECHANICAL, STRUCTURAL, AND ELECTRICAL DRAWINGS, AND VERIFY THE LOCATIONS AND SIZES OF THE CHASES, OPENING, INSERTS, SLEEVES, FINISHES, CONDUITS, DEPRESSIONS AND OTHER PROJECT REQUIREMENTS.
- 11. THE CONTRACTOR IS RESPONSIBLE FOR REVIEWING THE DRAWINGS AND EXISTING CONDITIONS TO DETERMINE WHERE OPENINGS ARE REQUIRED IN WALLS AND SLABS.
- 12. STANDARD DETAILS APPLY UNLESS INDICATED OTHERWISE ON SPECIFIC STRUCTURE DRAWINGS.

GENERAL CONCRETE NOTES:

- 1. STRUCTURAL CONCRETE FOR BUILDING MEMBERS SHALL HAVE A SPECIFIED COMPRESSIVE STRENGTH OF 4,500 PSI UNO.
- 2. CONCRETE FOR SLABS SUBJECTED TO VEHICULAR WHEEL LOADS SHALL HAVE A SPECIFIED COMPRESSIVE STRENGTH OF 4.500 PSI.
- 3. HOLD SLUMP TO 3 TO 4 INCHES IN ALL FLOOR SLABS.
- 4. ALL EXPOSED CONCRETE EDGES SHALL BE CHAMFERED 3/4".
- 5. NON-PRESTRESSED CONCRETE REINFORCEMENT SHALL CONFORM TO ASTM A615 GRADE 60.
- 6. REINFORCEMENT LAP SPLICES SHALL CONFORM TO ACI 318 & ACI 350.
- 7. CONCRETE COVER OVER REINFORCEMENT SHALL CONFORM TO THE MINIMUM REQUIRED BY ACI 318 & ACI 350. UNO.
- 8. REINFORCEMENT DETAILING AND PLACEMENT SHALL CONFORM TO ACI 318 AND ACI 315.
- 9. NO REINFORCING BAR SHALL BE WELDED OR FIELD BENT IN ANY MANNER, UNLESS SPECIFICALLY SHOWN OR NOTED ON THE DRAWINGS.
- 10. PROVIDE FULL EMBEDMENT FOR ALL DOWELS. IF NOT OTHERWISE SPECIFIED, DOWEL SIZE AND SPACING SHALL BE THE SAME AS MAIN REINFORCING.
- 11. MECHANICAL EQUIPMENT PADS ON FLOOR SLABS SHALL BE 6" THICK AND REINFORCED WITH #4 @ 12" EW, UNO.
- 12. WATERSTOP PIPE SLEEVES REQUIRED ON ALL WATERTIGHT WALLS AND FLOORS.
- 13. TREMIES REQUIRED ON ALL POURS DEEPER THAN 5 FEET
- 14. ALL WATERSTOPS TO BE 6" PVC FLAT RIBBED OR 9" PVC CENTER BULB AND PLACED AT ALL WATERTIGHT POURS, UNO. REFER TO DETAILS D03/3000-102A & B FOR WATERSTOP DETAILS.
- 15. ALL WATERTIGHT "HYDRAULIC" CONCRETE STRUCTURES SHALL PASS A 72 HOUR LEAKAGE TEST PRIOR TO BACKFILLING AROUND STRUCTURE.
- 16. WHEN WATERSTOP IS PLACED HORIZONTALLY IN SLABS, THE CONTRACTOR SHALL TEMPORARILY TIE UP OR CLAMP UP THE WATERSTOP UNTIL THE CONCRETE IS PLACED TO SLIGHTLY ABOVE THE DEPTH OF THE WATERSTOP.
- 17. VERTICAL WATERSTOP SHALL BE FULLY EMBEDDED IN SLAB POUR AND WELDED TO ALL ADJACENT WATERSTOP.
- 18. PROVIDE A MINIMUM OF SEVEN (7) DAYS BETWEEN ADJACENT POURS. CONCRETE SHALL MEET OR EXCEED DESIGN COMPRESSIVE STRENGTH PRIOR TO PLACING ADJACENT POURS.
- 19. CONTRACTOR SHALL SUBMIT TO ENGINEER FOR APPROVAL A SCHEDULE AND SEQUENCE OF CONCRETE PLACEMENT. SEQUENCE SHALL INCLUDE PERMITTING CURE TIME BETWEEN PLACEMENTS AT ADJACENT PROPOSED PLACEMENTS.
- 20. WALKWAYS AND SIDEWALKS SHALL BE POURED WITH SLIGHT SLOPE AND NO LOW SPOTS SO THEY WILL DRAIN FREE. ALL SLOPES SHALL COMPLY WITH ADA REQUIREMENTS.
- 21. ALL CONSTRUCTION JOINTS SHOWN ON THE STRUCTURAL DRAWINGS SHALL BE INCORPORATED INTO THE STRUCTURE. ADDITIONAL CONSTRUCTION JOINTS TO FACILITATE CONSTRUCTION SHALL BE LOCATED AND DETAILED ON THE SHOP DRAWINGS FOR REVIEW. UNLESS INDICATED OTHERWISE, ALL CONSTRUCTION JOINTS TO BE KEYED. HORIZONTAL CONSTRUCTION JOINTS SHALL NOT BE PERMITTED IN WALLS AND BEAMS, UNLESS SHOWN ON THE STRUCTURAL DRAWINGS.
- 22. SUBSTITUTION OF EXPANSION OR DRILLED AND GROUTED-IN ANCHORS FOR EMBEDDED ANCHORS SHOWN ON THE DRAWINGS WILL NOT BE PERMITTED UNLESS APPROVED BY ENGINEER.
- 23. USE MANUFACTURER'S CERTIFIED DRAWINGS AND SPECIFICATIONS FOR EQUIPMENT ANCHORAGE AND DETAILS. VERIFY EQUIPMENT SIZE AND WEIGHTS WITH ENGINEER PRIOR TO CONSTRUCTION OF ANY AND ALL EQUIPMENT PADS.

FOUNDATION

- 1. UNLESS OTHERWISE SPECIFIED, HOT-ROLLED STEEL BUILDING MEMBERS USING W-SHAPES SHALL BE ASTM A992; M-, S-, AND C- SHAPES ASTM A36; SQUARE, RECTANGULAR & ROUND HSS SHAPES ASTM A500 GRADE B; ANGLES AND MISCELLANEOUS STIFFENER PLATES ASTM A36.
- 2. ALL SHEAR CONNECTIONS NOT DETAILED OR OTHERWISE NOTED SHALL BE STANDARD AISC WELDED OR AISC BOLTED CONNECTIONS AND SHALL HAVE SUFFICIENT CAPACITY TO SUPPORT THE END REACTION EQUAL TO ONE HALF THE TOTAL UNIFORM CAPACITY SHOWN IN THE ALLOWABLE UNIFORM LOAD TABLES OF THE AISC STEEL CONSTRUCTION MANUAL CURRENT EDITION.
- 3. WELDING SHALL CONFORM WITH AWS D1.1 STRUCTURAL WELDING CODE.
- 4. ALL BOLTS FOR BEAM CONNECTIONS SHALL BE ASTM A325 WITH A MINIMUM DIAMETER OF 1/2" UNO. ALL BOLTED CONNECTIONS SHALL BE BEARING TYPE CONNECTIONS UNLESS NOTED AS SLIP CRITICAL. WASHERS SHALL BE INSTALLED UNDER NUTS OF FASTENERS WHEN REQUIRED BY THE SPECIFICATION FOR STRUCTURAL JOINTS.
- 5. ALL ANCHOR RODS SHALL BE ASTM F1554, GRADE 36 UNO.

STRUCTURAL STEEL NOTES

FOUNDATION NOTES:

- 1. FLOOR SLAB CONSTRUCTION JOINTS (C.J.) SHALL BE PLACED AS SHOWN ON FOUNDATION PLANS AND SUBMITTED TO ENGINEER FOR APPROVAL PRIOR TO CONCRETE PLACEMENT.
- 2. FLOOR SLAB ISOLATION JOINTS SHALL BE 30# FELT UNO.
- 3. CONCRETE FLOOR AND SLAB ON GRADE MAY BE PLACED IN LANES. SPACING OF JOINTS SHALL BE AS SHOWN ON THE FOUNDATION PLAN. WHEN LANE PLACEMENT IS USED, CONSTRUCTION JOINTS SHALL BE USED FOR THE JOINTS BETWEEN LANES. SAW CUT CRACK CONTROL JOINTS SHALL BE PROVIDED ACROSS EACH LANE AT SPACING SHOWN ON PLANS.
- 4. ALL CONCRETE CORNERS SHALL BE CHAMFERED 3/4" ON THE EXTERIOR EXPOSED CORNER.
- 5. COMPACTED GRANULAR FILL OR BASE COURSE ROCK AS INDICATED AND SPECIFIED
- 6. ALL PRESSURE PIPING BENEATH SLABS SHALL BE CONCRETE ENCASED.
- 7. VAPOR BARRIER REQUIRED BENEATH ALL INTERIOR BUILDING SLABS.

GENERAL CONCRETE MASONRY NOTES:

- 1. HOLLOW CMU UNITS SHALL CONFORM TO ASTM C90 TYPE 1 OF THE NOMINAL THICKNESS SHOWN ON THE DRAWINGS. ALL CMU SHALL BE 2 CELL BLOCK AND HAVE A SPECIFIED MINIMUM COMPRESSIVE STRENGTH OF 1900 PSI ON NET AREA AT 28 DAYS.
- 2. MORTAR FOR CMU SHALL CONFORM TO ASTM C270, TYPE S UNO.
- 3. GROUT FOR CMU GROUTED CELLS, LINTELS, COLUMNS, PILASTERS, BOND BEAMS AND BLOCKS WITH EMBEDDED ANCHORS SHALL BE 3,000 PSI PEA GRAVEL CONCRETE UNO.
- 4. CMU REINFORCING BARS SHALL CONFORM TO ASTM A 615 GRADE 60. HORIZONTAL JOINT REINFORCEMENT SHALL BE COLD DRAWN WIRE WITH A MINIMUM OF 9 GAUGE LONGITUDINAL WIRE SIZE, UNO, WITH THE TYPE AND SPACING AS SHOWN ON THE DRAWINGS OR SPECIFIED.
- 5. VERTICAL CELLS TO BE FILLED SHALL HAVE VERTICAL ALIGNMENT SUFFICIENT TO MAINTAIN A CLEAR UNOBSTRUCTED CONTINUOUS VERTICAL CELL NOT LESS THAN 2" X 3" IN PLAN DIMENSIONS.
- 6. FOUNDATION DOWELS SHALL EXTEND INTO THE FOUNDATION CONCRETE A MINIMUM OF THE DEVELOPMENT LENGTH FOR BAR SIZE USED. LAPS OR SPLICES OF REINFORCING STEEL IN MASONRY SHALL BE AS INDICATED BELOW. THERE SHALL BE A FOUNDATION DOWEL FOR EACH VERTICAL WALL REINFORCEMENT.
- NORMAL VERTICAL WALL REINFORCING SHALL EXTEND CONTINUOUSLY FROM THE FOUNDATION TO EMBED AT LEAST 6" INTO THE TOP OF WALL BOND BEAM. AN ADDITIONAL ONE #4 HOOKED DOWEL SHALL BE INSTALLED IN THE TOP OF ALL MASONRY WALLS AT EACH VERTICAL WALL CELL CONTAINING VERTICAL REINFORCING. THE DOWELS SHALL PROJECT 24" INTO THE WALL AND HOOK 6" INTO THE WALL TOP BOND BEAM.
- 8. CONTROL JOINTS SHALL BE OF THE TYPE AND AT THE LOCATIONS SHOWN ON THE DRAWINGS.
- 9. CONTROL JOINTS SHALL BE AS DETAILED ON D04/2200-306. PROVIDE CONTROL JOINTS IN ALL MASONRY WALLS UNO. CONTROL JOINT SPACING SHALL BE AS RECOMMENDED BY THE NATIONAL CONCRETE MASONRY ASSOCIATION WITH A MAXIMUM SPACING OF 25'. SUBMIT JOINT LAYOUT PLAN FOR REVIEW PRIOR TO MASONRY WALL CONSTRUCTION.
- 10. CORNER BLOCKS SHALL BE INTERWOVEN BETWEEN TWO WALLS.
- 11. EVERY PIER OR WALL SECTION WHOSE WIDTH IS 3'-0" OR LESS WILL HAVE HORIZONTAL SHEAR STEEL IN THE FORM OF TIES. REF D04/2200-007.
- 12. PROVIDE (2) ADDITIONAL #5 BARS ALONG SIDES, TOP AND BOTTOM OF ALL CMU WALL OPENINGS. EXTEND REINFORCING 24" BEYOND OPENING, UNO.
- VERTICAL WALL REINFORCING SHALL BE AS FOLLOWS: GROUT CELLS CONTAINING REINFORCEMENT, SOLID FULL HEIGHT UNO.
- 14. UNO, LAP SPLICE #5'S 3'-0"; #4'S 2'-0".

ABBREVIATIONS ABBREVIATIONS DESCRIPTION **DESCRIPTION** ALUMINUM POUNDS PER CUBIC FOOT ARCHITECT, ARCHITECTURAL PRE-FORMED JOINT BG **BACK GOUGE** PARTIAL JOINT PENETRATION PJPPOUNDS PER LINEAR FOOT BEAM PLF CCJ CRACK CONTROL JOINT SIMILAR CJP COMPLETE JOINT PENETRATION SSL SHORT SLOT COL STL COLUMN STEEL EF **EACH FACE** T&B TOP AND BOTTOM EJ EXPANSION JOINT TOB TOP OF BEAM ES TOP OF CONCRETE EVENLY SPACED, EACH SIDE TOC EW **EACH WAY** TOF TOP OF FOOTING EXST **EXISTING** TOS TOP OF STEEL EXT **EXTERIOR** VCJ **VERTICAL CONSTRUCTION JOINT** FD FLOOR DRAIN FND FOUNDATION FS FOOTING STEP, FAR SIDE IJ **ISOLATION JOINT** INT INTERIOR KIP **1,000 POUNDS** KLF KIPS PER LINEAR FOOT KSF KIPS PER SQUARE FOOT LLH LONG LEG HORIZONTAL LLV LONG LEG VERTICAL LSL LONG SLOT MECH **MECHANICAL** NS **NEAR SIDE** OH OPPOSITE HAND **OVERSIZED** OVS

LEGEND:

CENTERLINE % PERCENT WATERSTOP

DEGREES PL PLATE

FLANGE ± PLUS / MINUS

GRIDLINE

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ILLIARD N. FLETCHER WATER

ESOURCE RECOVERY FACILITY

STRUCTURAL NOTES, LEGENDS, AND ABBREVIATIONS


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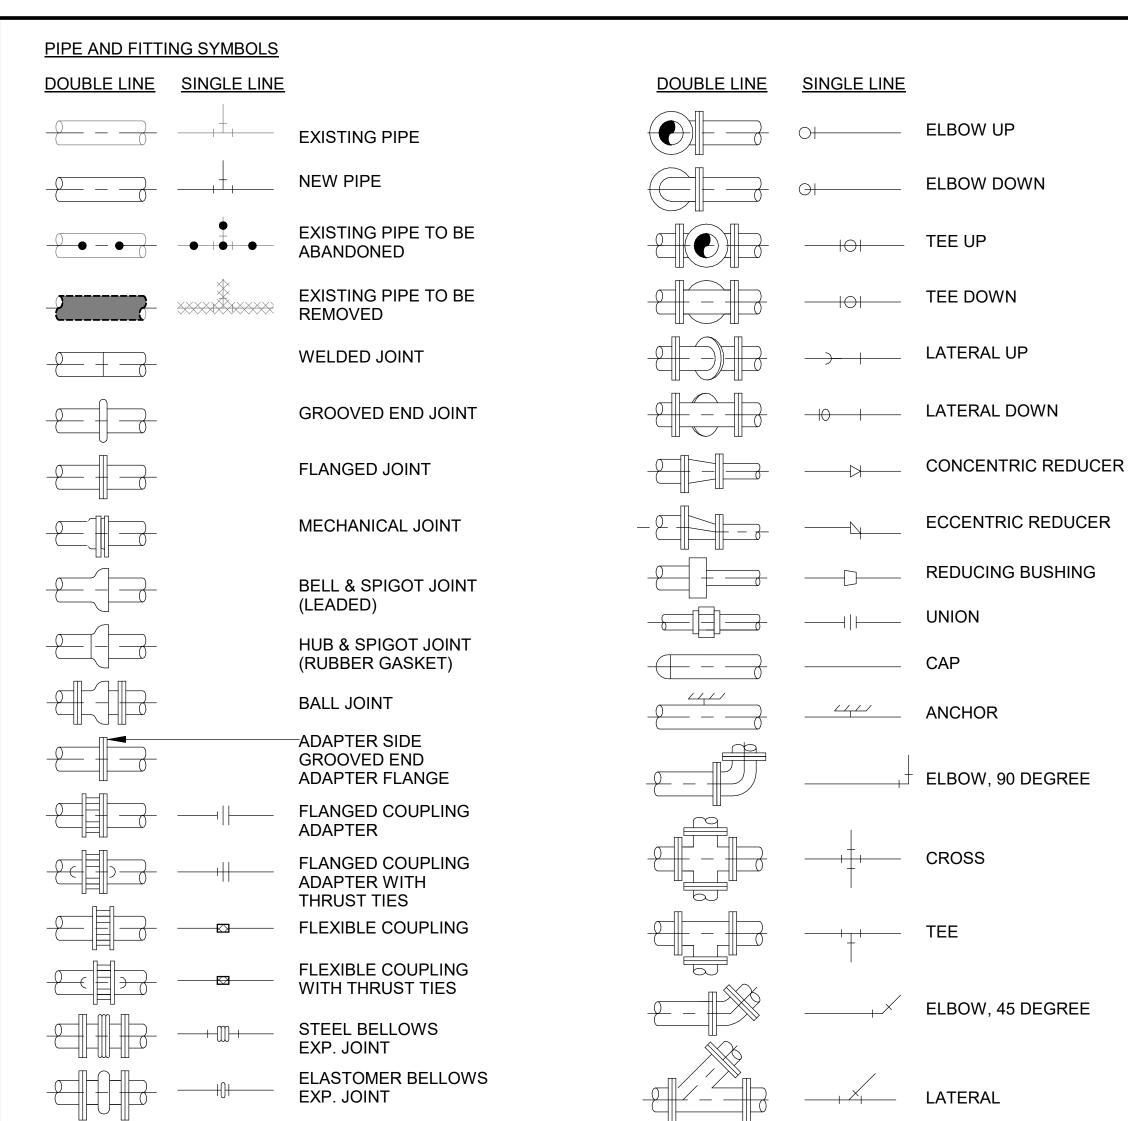
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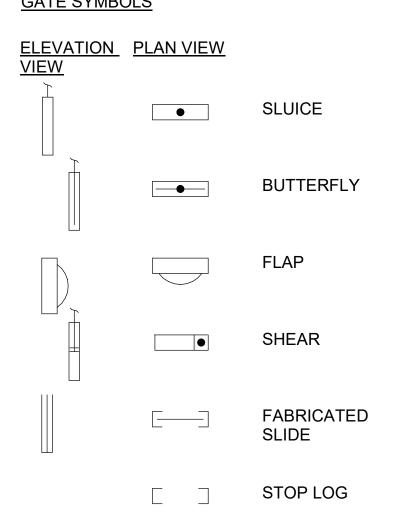
- ONLY FLANGED END CONNECTIONS ARE SHOWN HERE FOR DOUBLE LINE FITTINGS; FITTINGS WITH OTHER END PATTERNS ARE SHOWN SIMILARLY ON THE CONSTRUCTION DRAWINGS. ALSO SEE PIPING SPECIFICATIONS.
- 2. SYMBOLS SHOWN HERE FOR SINGLE LINE FITTINGS ARE GENERIC ONLY. REFER TO PIPING SPECIFICATIONS FOR SPECIFIC END CONNECTIONS FOR SINGLE LINE PIPE AND FITTINGS.
- 3. EXISTING PIPE AND EQUIPMENT IS SHOWN WITH A DASHED LINE AND/OR SCREENED AND IS NOTED AS EXISTING. NEW PIPING AND EQUIPMENT IS SHOWN WITH A HEAVY LINE.

GENERAL PIPING NOTES:

NOTES:

- 1. LAY PIPE TO UNIFORM GRADE BETWEEN INDICATED ELEVATION POINTS.
- 2. SIZE OF FITTINGS SHOWN ON PLANS SHALL CORRESPOND TO ADJACENT STRAIGHT RUN OF PIPE, UNLESS OTHERWISE INDICATED. TYPE OF JOINT AND FITTING MATERIAL SHALL BE THE SAME AS SHOWN FOR ADJACENT STRAIGHT RUN OF PIPE.
- 3. LOCATION AND NUMBER OF PIPE HANGERS AND PIPE SUPPORTS SHOWN IS ONLY APPROXIMATE. FINAL SUPPORT REQUIREMENTS SHALL BE DETERMINED IN THE FIELD AND REVIEWED BY THE ENGINEER PRIOR TO INSTALLATION. MAXIMUM SPACING SHALL BE AS SPECIFIED.
- 4. ALL JOINTS SHALL BE WATERTIGHT. WALL PIPES OR PENETRATION SEALS SHALL BE USED WHEREVER PIPING PASSES FROM A STRUCTURE TO BACKFILL
- 5. ALL FLEXIBLE CONNECTORS OR FLANGED COUPLING ADAPTERS SHALL BE PROVIDED WITH THRUST TIES, BLOCKS, OR ANCHORS, UNLESS OTHERWISE NOTED. THRUST PROTECTION SHALL BE ADEQUATE FOR TEST PRESSURES SPECIFIED.
- SYMBOLS, LEGENDS, AND PIPE USE IDENTIFICATIONS SHOWN SHALL BE FOLLOWED THROUGHOUT THE PLANS, WHEREVER APPLICABLE. NOT ALL OF THE VARIOUS PIPING COMPONENTS ARE NECESSARILY USED IN THE PROJECT
- NUMBER AND LOCATION OF UNIONS SHOWN ON PLANS IS ONLY APPROXIMATE. PROVIDE ALL UNIONS NECESSARY TO FACILITATE CONVENIENT REMOVAL OF VALVES AND MECHANICAL EQUIPMENT.
- 8. WHERE A GROOVED END COUPLING IS SHOWN, IT SHALL BE THE RIGID JOINT TYPE, UNLESS OTHERWISE SPECIFIED. WHERE A FLANGED COUPLING ADAPTER IS SHOWN, A STANDARD FLANGE SHALL BE JOINED TO THE COUPLING ADAPTER.

GATE SYMBOLS

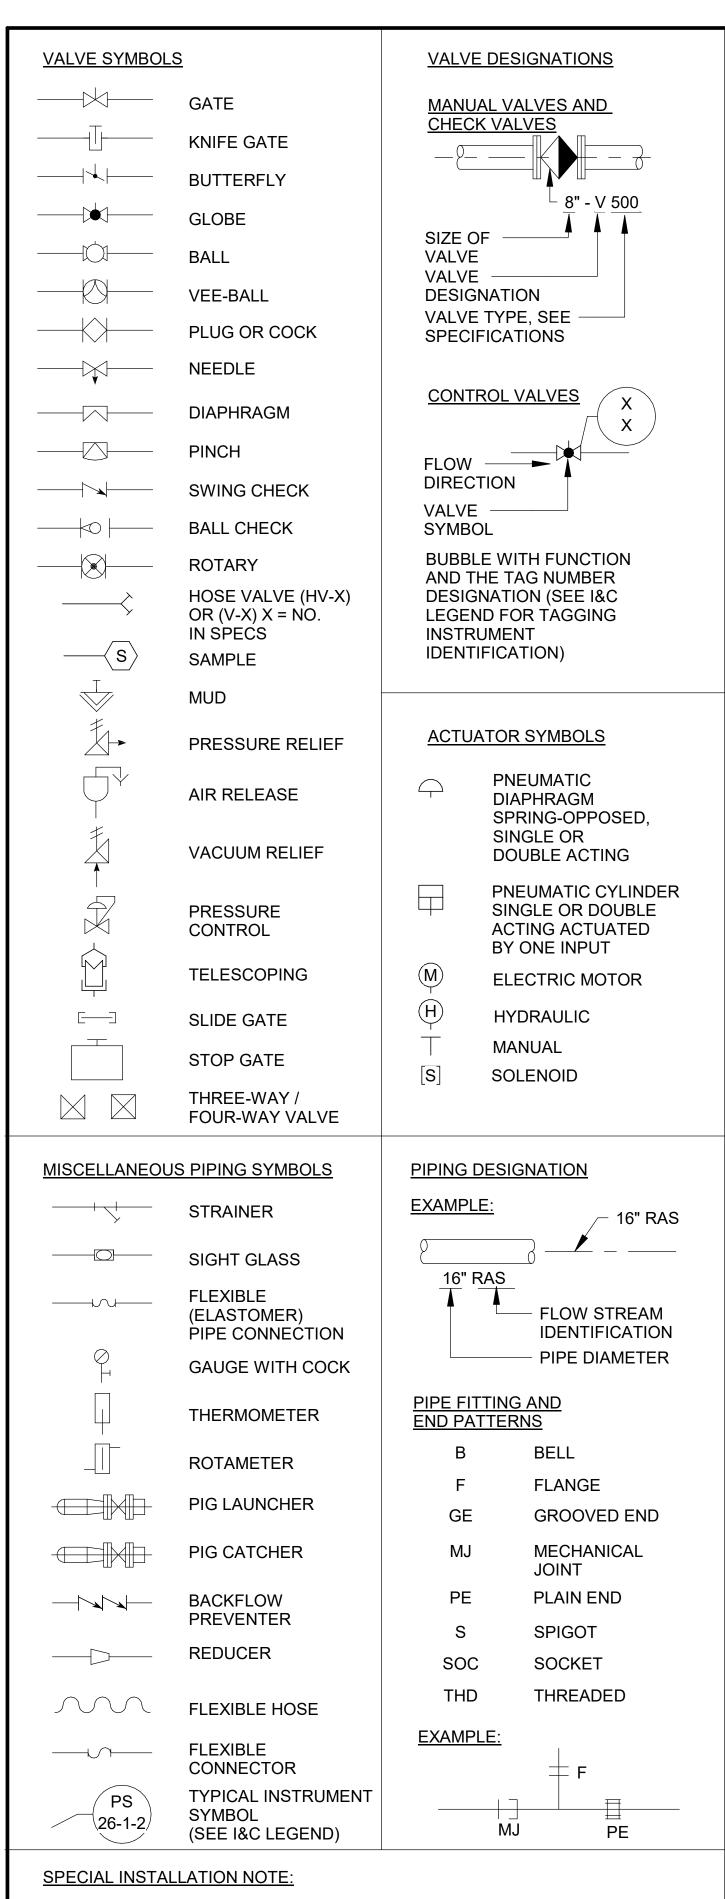

ABBREVIATIONS

AWWA	AMERICAN WATER WORKS ASSOCIATION
CPVC	CHLORINATED POLYVINYL CHLORIDE
DX	DIRECT EXPANSION
ECC	ECCENTRIC
EQUIP	EQUIPMENT
FLEX	FLEXIBLE
FOB	FLAT ON BOTTOM
FPM	FEET PER MINUTE
GAL	GALLON
GPD	GALLONS PER DAY
GPH	GALLONS PER HOUR
GPM	GALLONS PER MINUTE
N.O.	NORMALLY OPEN
NC	NORMALLY CLOSED
OS&Y	OUTSIDE STEM AND YOKE
RPM	REVOLUTIONS PER MINUTE
SP	STATIC PRESSURE
VAC	VACUUM
VTR	VENT THROUGH ROOF
WC	WATER COLUMN

WATER PRESSURE DROP

DESCRIPTION

FLOW STREAM IDENTIFICATION ABBREV DESCRIPTION

ALP AIR, LOW PRESSURE
BS BLENDED SLUDGE
DG DIGESTER GAS
DS DIGESTED SLUDGE
HWR HOT WATER RETURN
HWS HOT WATER SUPPLY

MLSS MIXED LIQUOR SUSPENDED SOLIDS

THE CONSTRUCTION SEQUENCING AND SCOPE

1. IN THE EVENT THAT A DEDUCTIVE ALTERNATIVE IS SELECTED, THE CONTRACTOR

WILL BE RESPONSIBLE FOR COORDINATING WITH THE ENGINEER TO DETERMINE

NG NATURAL GAS
PE PRIMARY EFFLUENT

RAS RETURN ACTIVATED SLUDGE

VENT VENT

GENERAL NOTE:

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PROCESS MECHANICAL NOTES, LEGENDS, AND ABBREVIATIONS

JOB NO.: 19W10160

DATE: JAN. 2024

DESIGNED BY: RWC

DRAWN BY: SAC

CHECKED BY: RDT

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GENERAL NOTES:

- 1. THESE NOTATIONS ARE INTENDED TO BE GENERAL IN NATURE. THEY MAY OR MAY NOT 17. IN AREAS WHERE THERE ARE OVERHEAD BRIDGE CRANES, HOISTS, DOORS OR OTHER APPLY TO SOME OR ALL OF THE PLAN SHEETS AND SPECIFICATIONS
- 2. CONDUIT RUNS INDICATED ON THE PLAN SHEETS ARE INTENDED TO BE SCHEMATIC ONLY. THE CONTRACTOR SHALL BE RESPONSIBLE FOR FIELD ROUTING ALL CONDUIT RUNS AND SHALL COORDINATE ANY DEVIATION FROM ROUTING AS INDICATED HEREIN WITH THE ENGINEER. ALL CONDUIT SHALL BE INSTALLED IN SUCH A MANNER AS TO PREVENT CONFLICTS WITH EQUIPMENT. EXPOSED CONDUIT SHALL BE INSTALLED PARALLEL OR PERPENDICULAR TO BEAMS OR STRUCTURAL CONDITIONS.
- 3. THE CONTRACTOR SHALL BE RESPONSIBLE FOR FIELD ROUTING ALL CONDUITS NOT INDICATED ON THE PLAN SHEETS. THIS INCLUDES CIRCUITS FOR LIGHTING, RECEPTACLES AND OTHER MISCELLANEOUS EQUIPMENT CIRCUITS.
- 4. ALL CONDUITS SHALL BE ROUTED AND SUPPORTED IN SUCH A MANNER AS TO NOT COMPROMISE THE STRUCTURAL INTEGRITY OF WALLS, FLOORS, CEILINGS, AND ROOFS. WHERE REQUIRED, THE CONTRACTOR SHALL PROVIDE ADDITIONAL STRUCTURAL SUPPORTING MEMBERS FOR THE INSTALLATION AND SHALL COORDINATE SUCH MEMBERS WITH ENGINEER.
- 5. ALL SURFACE MOUNTED PANELS AND PANELBOARDS ON THE INTERIOR OF EXTERIOR WALLS OR IN OTHER LOCATIONS CONSIDERED DAMP OR WET SHALL BE MOUNTED SO AS TO MAINTAIN A 1/4" MINIMUM AIR SPACE BETWEEN THE ENCLOSURE AND THE WALL
- 6. PULLBOXES, IF SHOWN ON THE PLANS, ARE SCHEMATIC IN NATURE. THE CONTRACTOR SHALL PROVIDE ADDITIONAL PULLBOXES WHERE REQUIRED TO MAKE A WORKABLE INSTALLATION.
- 7. ALL WORK SHALL BE PERFORMED IN ACCORDANCE WITH THE SPECIFICATIONS WHETHER OR NOT THEY ARE REFERENCED ON THE DRAWINGS.
- 8. ALL CONDUIT RUNS PASSING THROUGH EXPANSION JOINTS SHALL HAVE EXPANSION OR EXPANSION AND DEFLECTION TYPE FITTINGS. FOR LOCATIONS OF EXPANSION JOINTS, REFER TO THE STRUCTURAL DRAWINGS.
- THE WIRING DIAGRAMS, QUANTITY AND SIZE OF WIRES AND CONDUITS REPRESENT SUGGESTED ARRANGEMENT BASED UPON SELECTED STANDARD COMPONENTS OF ELECTRICAL EQUIPMENT. IF EQUIPMENT SUPPLIED BY THE MANUFACTURER HAS A LARGER LOAD THAN THE VALUE SHOWN OR INDICATED, THE CABLE, CONDUIT AND ELECTRICAL EQUIPMENT MAY BE ENLARGED AS REQUIRED TO ACCOMMODATE THE HIGHER LOADING. HOWEVER, THE BASIC SEQUENCE AND METHOD OF CONTROL MUST BE MAINTAINED AS INDICATED ON THE DRAWINGS AND/OR SPECIFICATIONS
- 10. ALL MOTOR STARTER CONTROL POWER TRANSFORMERS SHALL BE SIZED TO PROVIDE SUFFICIENT VOLT-AMPERE CAPACITY FOR OPERATING ALL LOCAL AND REMOTE ELECTRICAL DEVICES ASSOCIATED WITH CONTROL OF THE MOTOR IN ADDITION TO THE STARTER COIL. THE CONTRACTOR SHALL BE RESPONSIBLE FOR VERIFYING ALL LOADING REQUIREMENTS FOR CONTROL POWER TRANSFORMERS.
- 11. THE CONTRACTOR SHALL BE RESPONSIBLE FOR FURNISHING PROPERLY SIZED STARTER OVERLOADS FOR ALL EQUIPMENT INSTALLED.
- 12. MOTOR CONTROL CENTERS AND ALL FREE STANDING PANELS SHALL BE SET ON CONCRETE HOUSEKEEPING PADS.
- 13. IN GENERAL, SEPARATE POWER, CONTROL AND SIGNAL WIRING. PROVIDE SEPARATE CONDUIT, PULL AND JUNCTION BOXES. PROVIDE SUITABLE CABLE BARRIER WITHIN PULL OR JUNCTION BOXES WHERE SEPARATION OF WIRING IS NOT SHOWN ON THE DRAWINGS. CONTROL AND SIGNAL CONDUCTORS OF LIKE VOLTAGES MAY BE COMBINED INTO A SINGLE CONDUIT, AS LONG AS NEC CONDUIT FILL REQUIREMENTS ARE MET.
- 14. UNLESS OTHERWISE NOTED ALL CONDUIT TO BE ROUTED EXPOSED. ALL EXPOSED CONDUIT AND PORTIONS OF THE CONDUIT SYSTEM SHALL BE SURFACE MOUNTED. SEE SPECIFICATIONS FOR CONDUIT, BOXES, SUPPORTS, HANGAR, UNISTRUT AND OTHER PORTIONS OR THE CONDUIT SYSTEM MATERIAL REQUIREMENTS.
- 15. VERIFY LOCATION OF ALL EQUIPMENT PRIOR TO INSTALLATION.
- 16. PROVIDE SEPARATE CONDUITS FOR 480VAC POWER CIRCUITS. SIGNAL AND CONTROL CONDUCTORS OF LIKE VOLTAGES MAY BE COMBINED IN A SINGLE CONDUIT

- SIMILAR ITEMS. NO CONDUITS SHALL BE INSTALLED IN SUCH A MANNER AS TO CONFLICT WITH PROPER OPERATION OF SUCH EQUIPMENT.
- 18. CONTRACTOR SHALL FURNISH AND INSTALL ITEMS AS NECESSARY FOR COMPLETE AND FUNCTIONAL SYSTEMS. THE CONTRACTOR SHALL REFER TO THE SPECIFICATIONS AND OTHER SECTIONS OF THE PLANS FOR ITEMS AS MAY BE REQUIRED AND SHALL PROVIDE CONDUIT, WIRING AND TERMINATIONS FOR ALL ITEMS AS REQUIRED.
- 19. CONTRACTOR SHALL REFER TO OTHER PLAN SHEETS FOR LOCATIONS OF FIREWALLS. ALL CONDUIT PENETRATIONS IN THESE WALLS SHALL BE ACCOMPLISHED IN SUCH A MANNER AS TO NOT REDUCE THE RATING OF THE FIREWALL THROUGH THE USE OF BOXES, SEALANTS AND OTHER ACCESSORIES AS MAY BE REQUIRED
- 20. CONTRACTOR SHALL REFER TO MECHANICAL PLAN SHEETS AND SPECIFICATIONS FOR ITEMS RELATED TO THE MECHANICAL SYSTEMS. THE CONTRACTOR SHALL BE RESPONSIBLE FOR INSTALLING ALL ITEMS AS NECESSARY FOR COMPLETE AND OPERABLE MECHANICAL HEREIN INCLUDING, BUT NOT LIMITED TO; CONTROL POWER TRANSFORMERS, STARTERS, THERMOSTATS, CONTROL STATIONS, AND OTHER ELECTRICAL ITEMS AS RELATED TO THE INSTALLATION OF THE MECHANICAL SYSTEMS.
- THE CONTRACTOR SHALL BE RESPONSIBLE FOR PROVIDING DISCONNECTS FOR ALL MECHANICAL MOTORS UNLESS THE EQUIPMENT IS FURNISHED WITH AN INTEGRAL DISCONNECT FROM THE MANUFACTURER. IN ADDITION, THE CONTRACTOR SHALL BE RESPONSIBLE FOR PROVIDING ALL CONDUIT, WIRING AND TERMINATIONS FOR ALL COMPONENTS AS MAY BE NECESSARY FOR THE MECHANICAL SYSTEMS.
- 22. ALL RECEPTACLES IN OUTDOOR AND ANTICIPATED WET AREAS SHALL BE GROUND FAULT CIRCUIT INTERRUPTER RECEPTACLES WITH HEAVY-DUTY WEATHERPROOF COVERS.
- 23. EQUIPMENT LOCKOUTS SHALL BE IN STRICT ACCORDANCE WITH OWNER'S REQUIREMENTS.
- 24. ALL CONDUITS SHALL HAVE A GROUNDING CONDUCTOR, SIZED PER NEC
- 25. ALL LIGHTING FIXTURES INSTALLED IN INSULATED LOCATIONS SHALL BE RATED FOR SUCH INSTALLATION REGARDLESS OF THE FIXTURE SCHEDULE DESIGNATION.
- 26. THE CONTRACTOR SHALL BE RESPONSIBLE FOR COORDINATION OF NEW SERVICE INSTALLATIONS WITH OWNER, ENGINEER AND SERVICE UTILITY. THE CONTRACTOR SHALL FURNISH AND INSTALL ALL ITEMS AS REQUIRED BY SERVICE UTILITY FOR NEW SERVICE CONNECTIONS.
- 27. UNLESS NOTED OTHERWISE, ALL CONTROL PANELS SHALL BE FABRICATED SUCH THAT ALL OPERATORS AND INDICATING DEVICES INDICATED ON THE SCHEMATICS BE LOCATED ON THE FRONT DOOR OR COVER OF THE PANEL. OPERATING AND INDICATING DEVICES SHALL BE VISIBLE AND OPERABLE WITHOUT HAVING TO OPEN THE CONTROL PANEL UNLESS OTHERWISE IDENTIFIED ON THE DRAWING
- 28. DUCT BANKS INDICATED AND THE BELOW GRADE CONDUIT ROUTING AS SHOWN IS DIAGRAMMATIC IN NATURE AND SHOWN FOR REFERENCE ONLY; THE CONTRACTOR SHALL REVIEW PLAN SHEETS RELATED TO INDIVIDUAL STRUCTURES AND VERIFY CONDUITS THAT MAY BE REQUIRED. THE CONTRACTOR SHALL VERIFY NUMBER OF CONDUITS AS INDICATED IN THE DUCT BANK PRIOR TO INSTALLATION WITH THE ENGINEER. PROVIDE, AT A MINIMUM, ONE SPARE CONDUIT EQUAL IN SIZE TO THE LARGEST CONDUIT IN USE, IN EACH DUCT BANK. FOR EACH SET OF FOUR USED CONDUITS IN EACH DUCT BANK PROVIDE A SPARE CONDUIT EQUAL TO THE LARGEST CONDUIT IN USE: (1-4 CONDUITS, 1 SPARE; 5-8 CONDUITS, 2 SPARE; AND SO ON).
- 29. THE CONTRACTOR SHALL BE RESPONSIBLE FOR PROVIDING HEAT TRACING FOR ALL EXPOSED WATER LINES TO BE INSTALLED UNDER THIS PROJECT. THE CONTRACTOR SHALL REVIEW OTHER SECTIONS OF THE PLANS AND SPECS AND PROVIDE SUITABLE HEAT TRACING COMPONENTS AS MAY BE REQUIRED, WHETHER INDICATED ON THE ELECTRICAL PLAN SHEETS OR NOT.
- 30. VERIFY LOCATION OF ALL LIGHTING FIXTURES WITH OWNER AND ENGINEER PRIOR TO INSTALLATION. COORDINATE LIGHT FIXTURE LOCATIONS AND MOUNTING HEIGHTS WITH HVAC DUCTS AND OVERHEAD CONDUIT RUNS. USE RIGID CONDUIT WHEN SUSPENDING LIGHT FIXTURES TO PREVENT SWAYING.
- 31. USE CRIMPED OR BOLTED CONNECTIONS FOR ALL BONDING CONNECTIONS BETWEEN CONDUCTORS AND BUILDING SYSTEM COMPONENTS. USE EXOTHERMIC WELDED CONNECTIONS FOR ALL UNDERGROUND PORTIONS OF THE GROUNDING SYSTEM WITH THE EXCEPTION OF GROUND ROD TEST WELLS.
- 32. MINIMUM LIGHTNING PROTECTION ITEMS WHERE SHOWN. FINAL LIGHTENING PROTECTION SYSTEM SHALL BE DEVELOPED AND SUBMITTED BY MASTER INSTALLER/DESIGNER CERTIFIED BY UL OR LPI AS REQUIRED IN SPECIFICATION **SECTION 26 41 13.**

ABBREV	DESCRIPTION
A, AMP	AMPERES
ABC	ABOVE COUNTER
ACS	ACCESS CONTROL SYSTEM
ACU ACU	AIR CONDITIONING UNIT
AFG	ABOVE FINISHED GRADE
AIC	AIMPS INTERRUPTING CAPACITY
AM	AMP-METER
ANN	ANNUNCIATOR
AP	AERIAL PRIMARY
AS	AERIAL SECONDARY
ATS	AUTOMATIC TRANSFER SWITCH
BFI	BLOWN FUSE INDICATOR
BI	BYPASS ISOLATION
С	CONDUIT
СВ	CIRCUIT BREAKER
CCTV	CLOSED CIRCUIT TELEVISION
CGRS	PVC COATED GALVANIZED RIGID STEEL
COM	COMMON
СР	CONTROL PANEL
CPT	CONTROL POWER TRANSFORMER
CR	CONTROL RELAY
CRI	COLOR RENDERING INDEX
CS	CORD SET
CU	COEFFICIENT OF UTILIZATION
dB	DECIBEL
DDC	
	DIRECT DIGITAL CONTROL(S)
DEB	DIRECT EARTH BURIED
DISC	DISCONNECT
EC	EMPTY, EMEDDED CONDUIT
EF	EXHAUST FAN
EG	EQUIPMENT GROUND
EMT	ELECTRICAL METALLIC TUBING
ENCL	ENCLOSURE
ETM	ELAPSED TIME METER
FACP	FIRE ALARM CONTROL PANEL
FC	FAN COIL
FDS	FUSED DISCONNECT SWITCH
FLA	FULL LOAD AMPERES
FOC	FIBER OPTIC CABLE
FS	FLOAT SWITCH
FVNR	FULL VOLTAGE NON-REVERSING STARTER
FVR	FULL VOLTAGE REVERSING STARTER
GDT	GRAPHIC DISPLAY TERMINAL
GND	GROUND
GRS	GALVANIZED RIGID STEEL
HID	HIGH INTENSITY DISCHARGE
HR	HOUR
Hz	HERTZ
IDS	INTRUSION DETECTION SYSTEM
IG	ISOLATED GROUND
ISP	INDIVIDUALLY SHIELDED PAIR
JB	JUNCTION BOX
kVAR	KILOVOLT-AMPERE, REACTIVE
kWh	KILOWATT-HOUR
LA	LIGHTNING ARRESTER
LLF	LIGHT LOSS FACTOR
LO	LUGS ONLY
LOR	LOCAL-OFF-REMOTE
LRA	LOCKED ROTOR AMPERES
LV	LOW VOLTAGE

<u> </u>	1000 BTU PER HOUR
MCA	MINIMUM CIRCUIT AMPACITY
MCB	MAIN CIRCUIT BREAKER
MCC	MOTOR CONTROL CENTER
MCP	MOTOR CIRCUIT PROTECTOR
MLO	MAIN LUGS ONLY
MOCP	MAXIMUM OVER CURRENT PROTECTION
MS	MOTOR STARTER
MTD	MOUNTED
N.O.	NORMALLY OPEN
NCTO	NORMALLY CLOSED TIMED OPEN
NEC	NATIONAL ELECTRICAL CODE
NEMA	NATIONAL ELECTRICAL MANUFACTURER'S ASSOCIATION
NEUT	NEUTRAL
NFDS	NON-FUSED DISCONNECT SWITHC
NL	NIGHT LIGHT
NOTC	NORMALLY OPEN TIMED CLOSED
OHP	OVERHEAD PRIMARY
OHS	OVERHEAD SECONDARY
OL	OVERLOAD
PB	PUSH BUTTON
PEC	PHOTO ELECTRIC CELL
PF	POWER FACTOR
PFCC	POWER FACTOR CORRECTION CAPACITOR
PH, Ø	PHASE
PL	PILOT LIGHT
PMR	PHASE MONITOR RELAY
PTT	PUSH-TO-TEST
RECPT	RECEPTACLE
RLA	RUNNING LOAD AMPERES
RVAT	REDUCED VOLTAGE AUTO-TRANSFERMER STARTE
RVSS	REDUCED VOLTAGE SOFT STARTER
S	SECOND
SA	SURGE ARRESTER
SDBC	SOFT DRAWN BARE COPPER
SE	SERVICE ENTERANCE
SN	SOLID NEUTRAL
SSOL	SOLID STATE OVERLOAD RELAY
STP	SHIELDED TWISTED PAIR
SW	SWITCH
TC	TIME CLOCK
TD	TIME DELAY
TDD	TIME DELAY ON DE-ENERGIZATION
TDE	TIME DELAY ON ENERGIZATION
TEL	TELEPHONE
THD	TOTAL HARMONIC DISTORTION
UG	UNDERGROUND
UGE	UNDERGROUND ELECTRIC
UGP	UNDERGROUND PRIMARY
UGS	UNDERGROUND SECONDARY
UH	UNIT HEATER
UL	UNDERWRITERS LABORATORIES, INC.
UTP	UNSHIELDED TWISTED PAIR
VFD	VARIABLE FREQUENCY DRIVE
VM	VOLT-METER
WH	WEATHER HEAD
WM	WATT METER
WP	WEATHERPROOF

ABBREVIATIONS



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ELECTRICAL NOTES AND ABBREVIATIONS

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WATER FACILIT TS

ELECTRICAL LEGENDS


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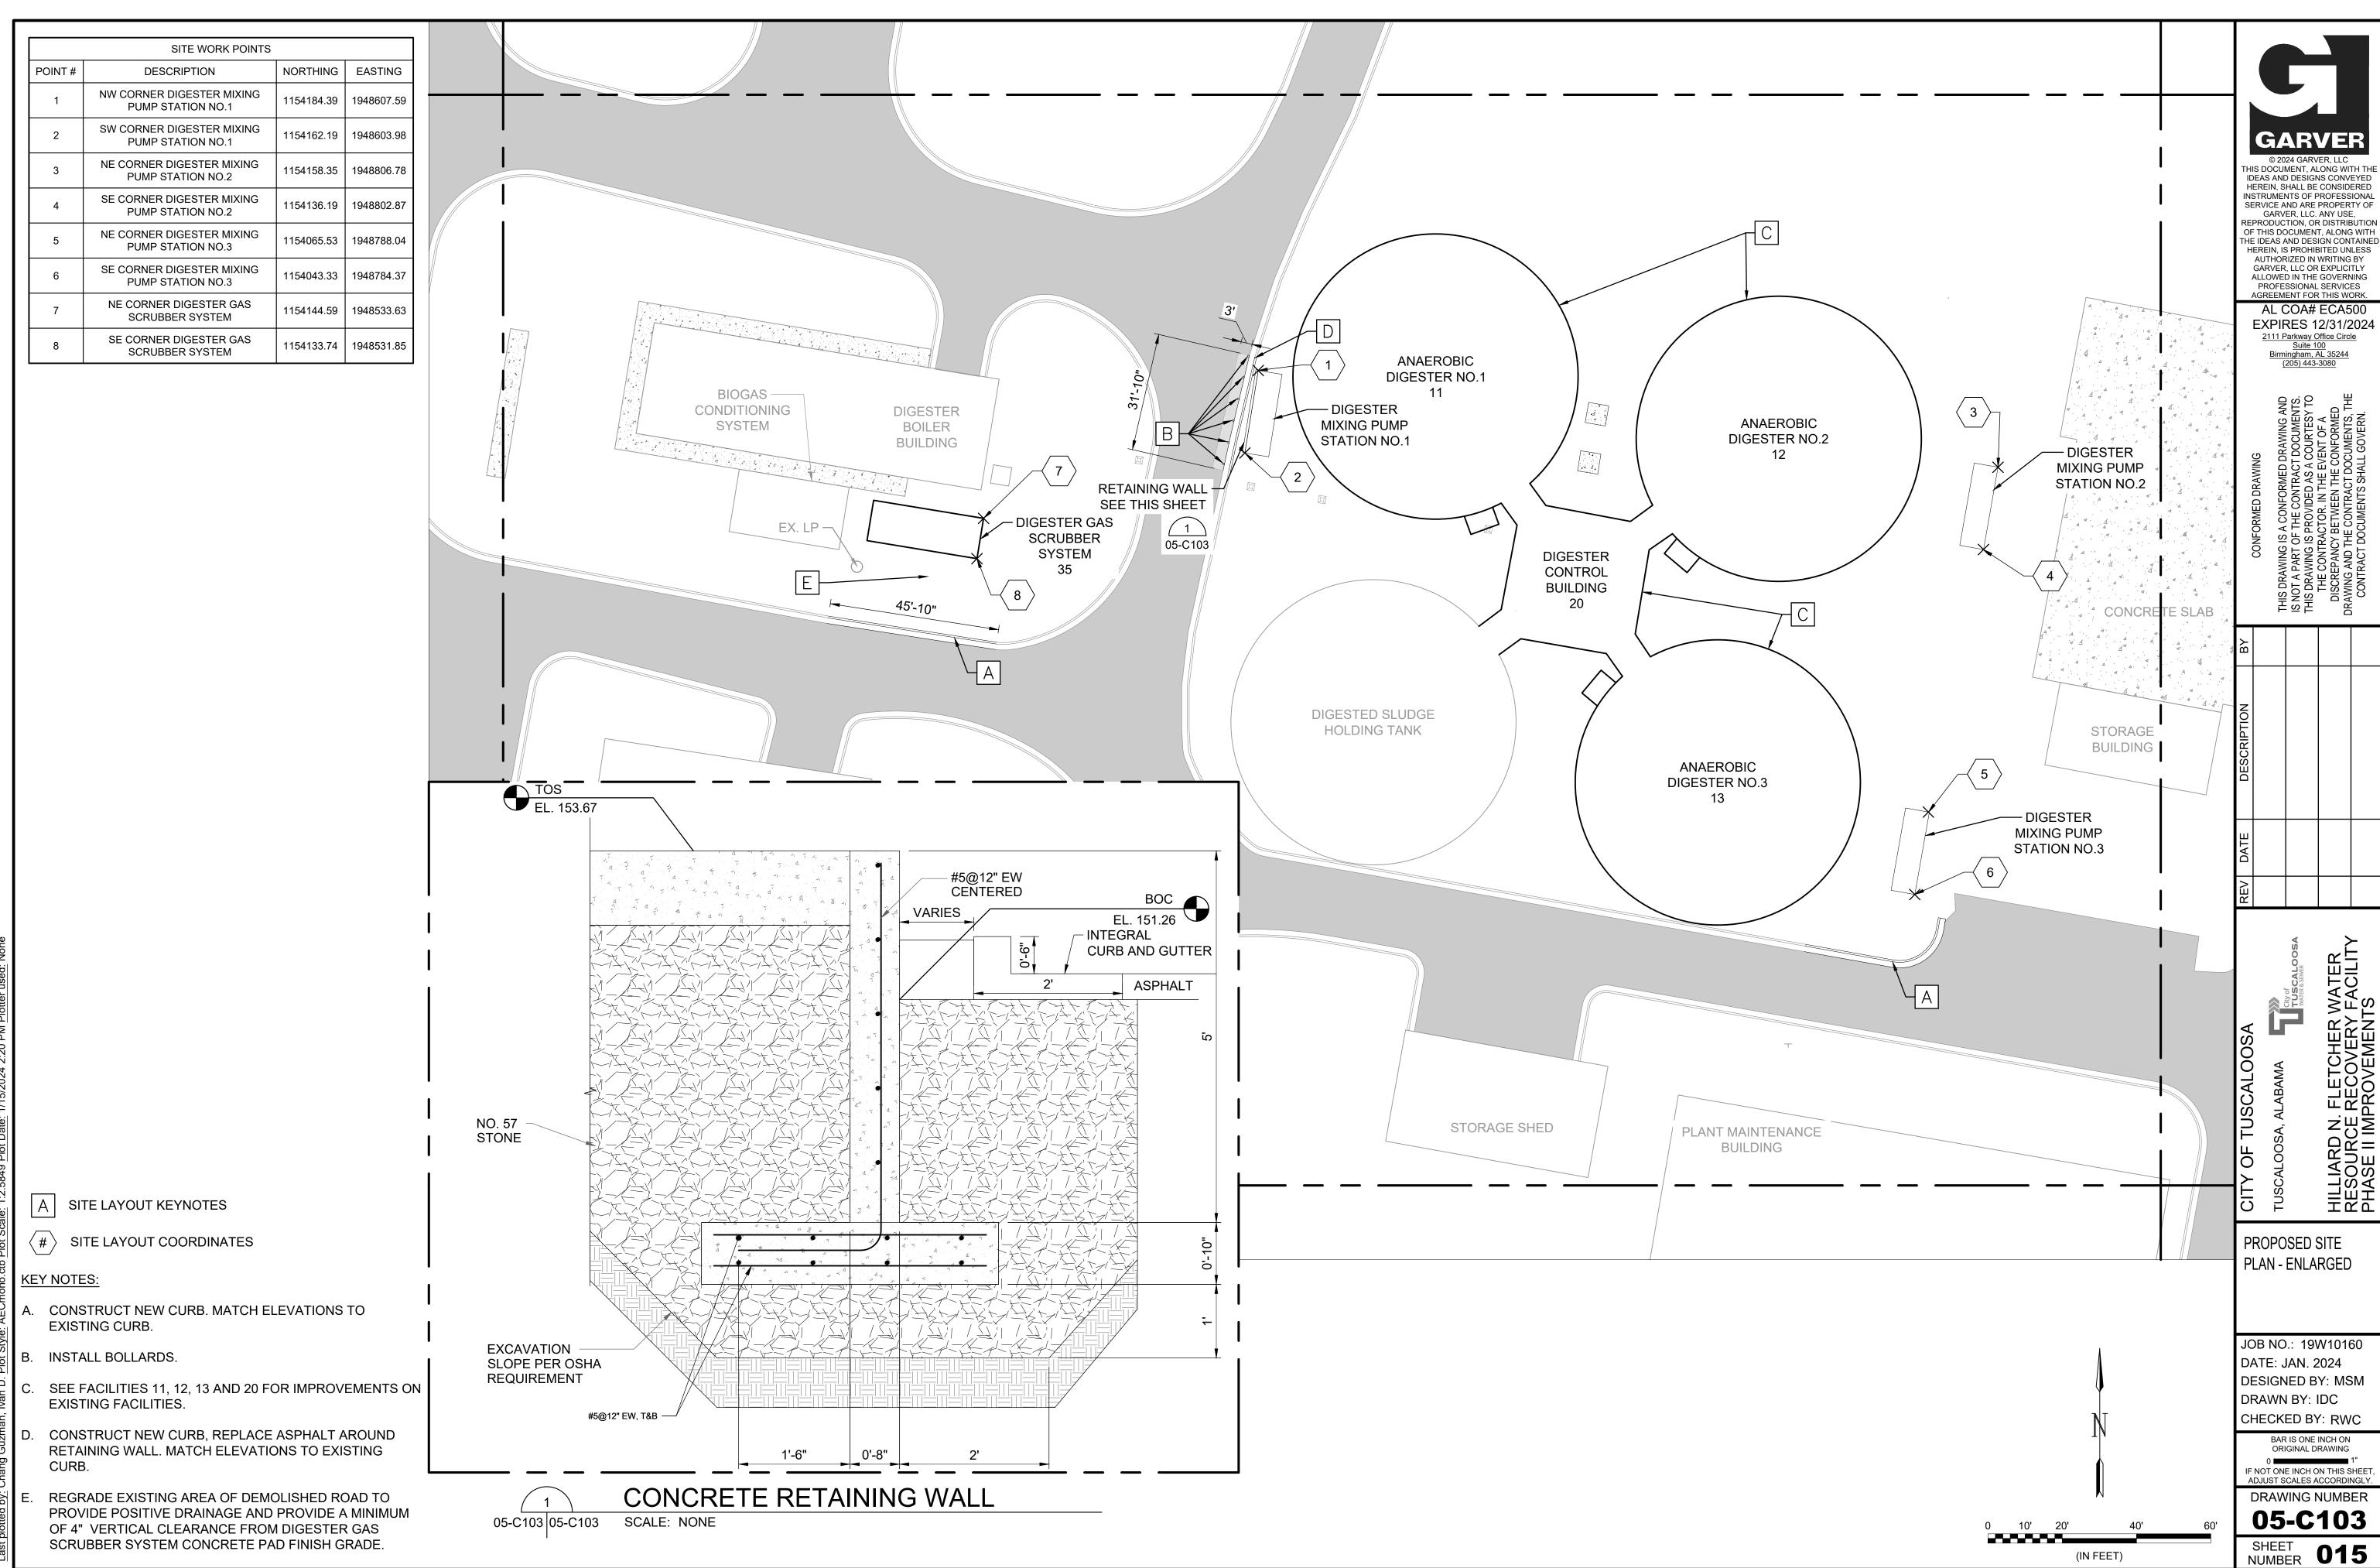
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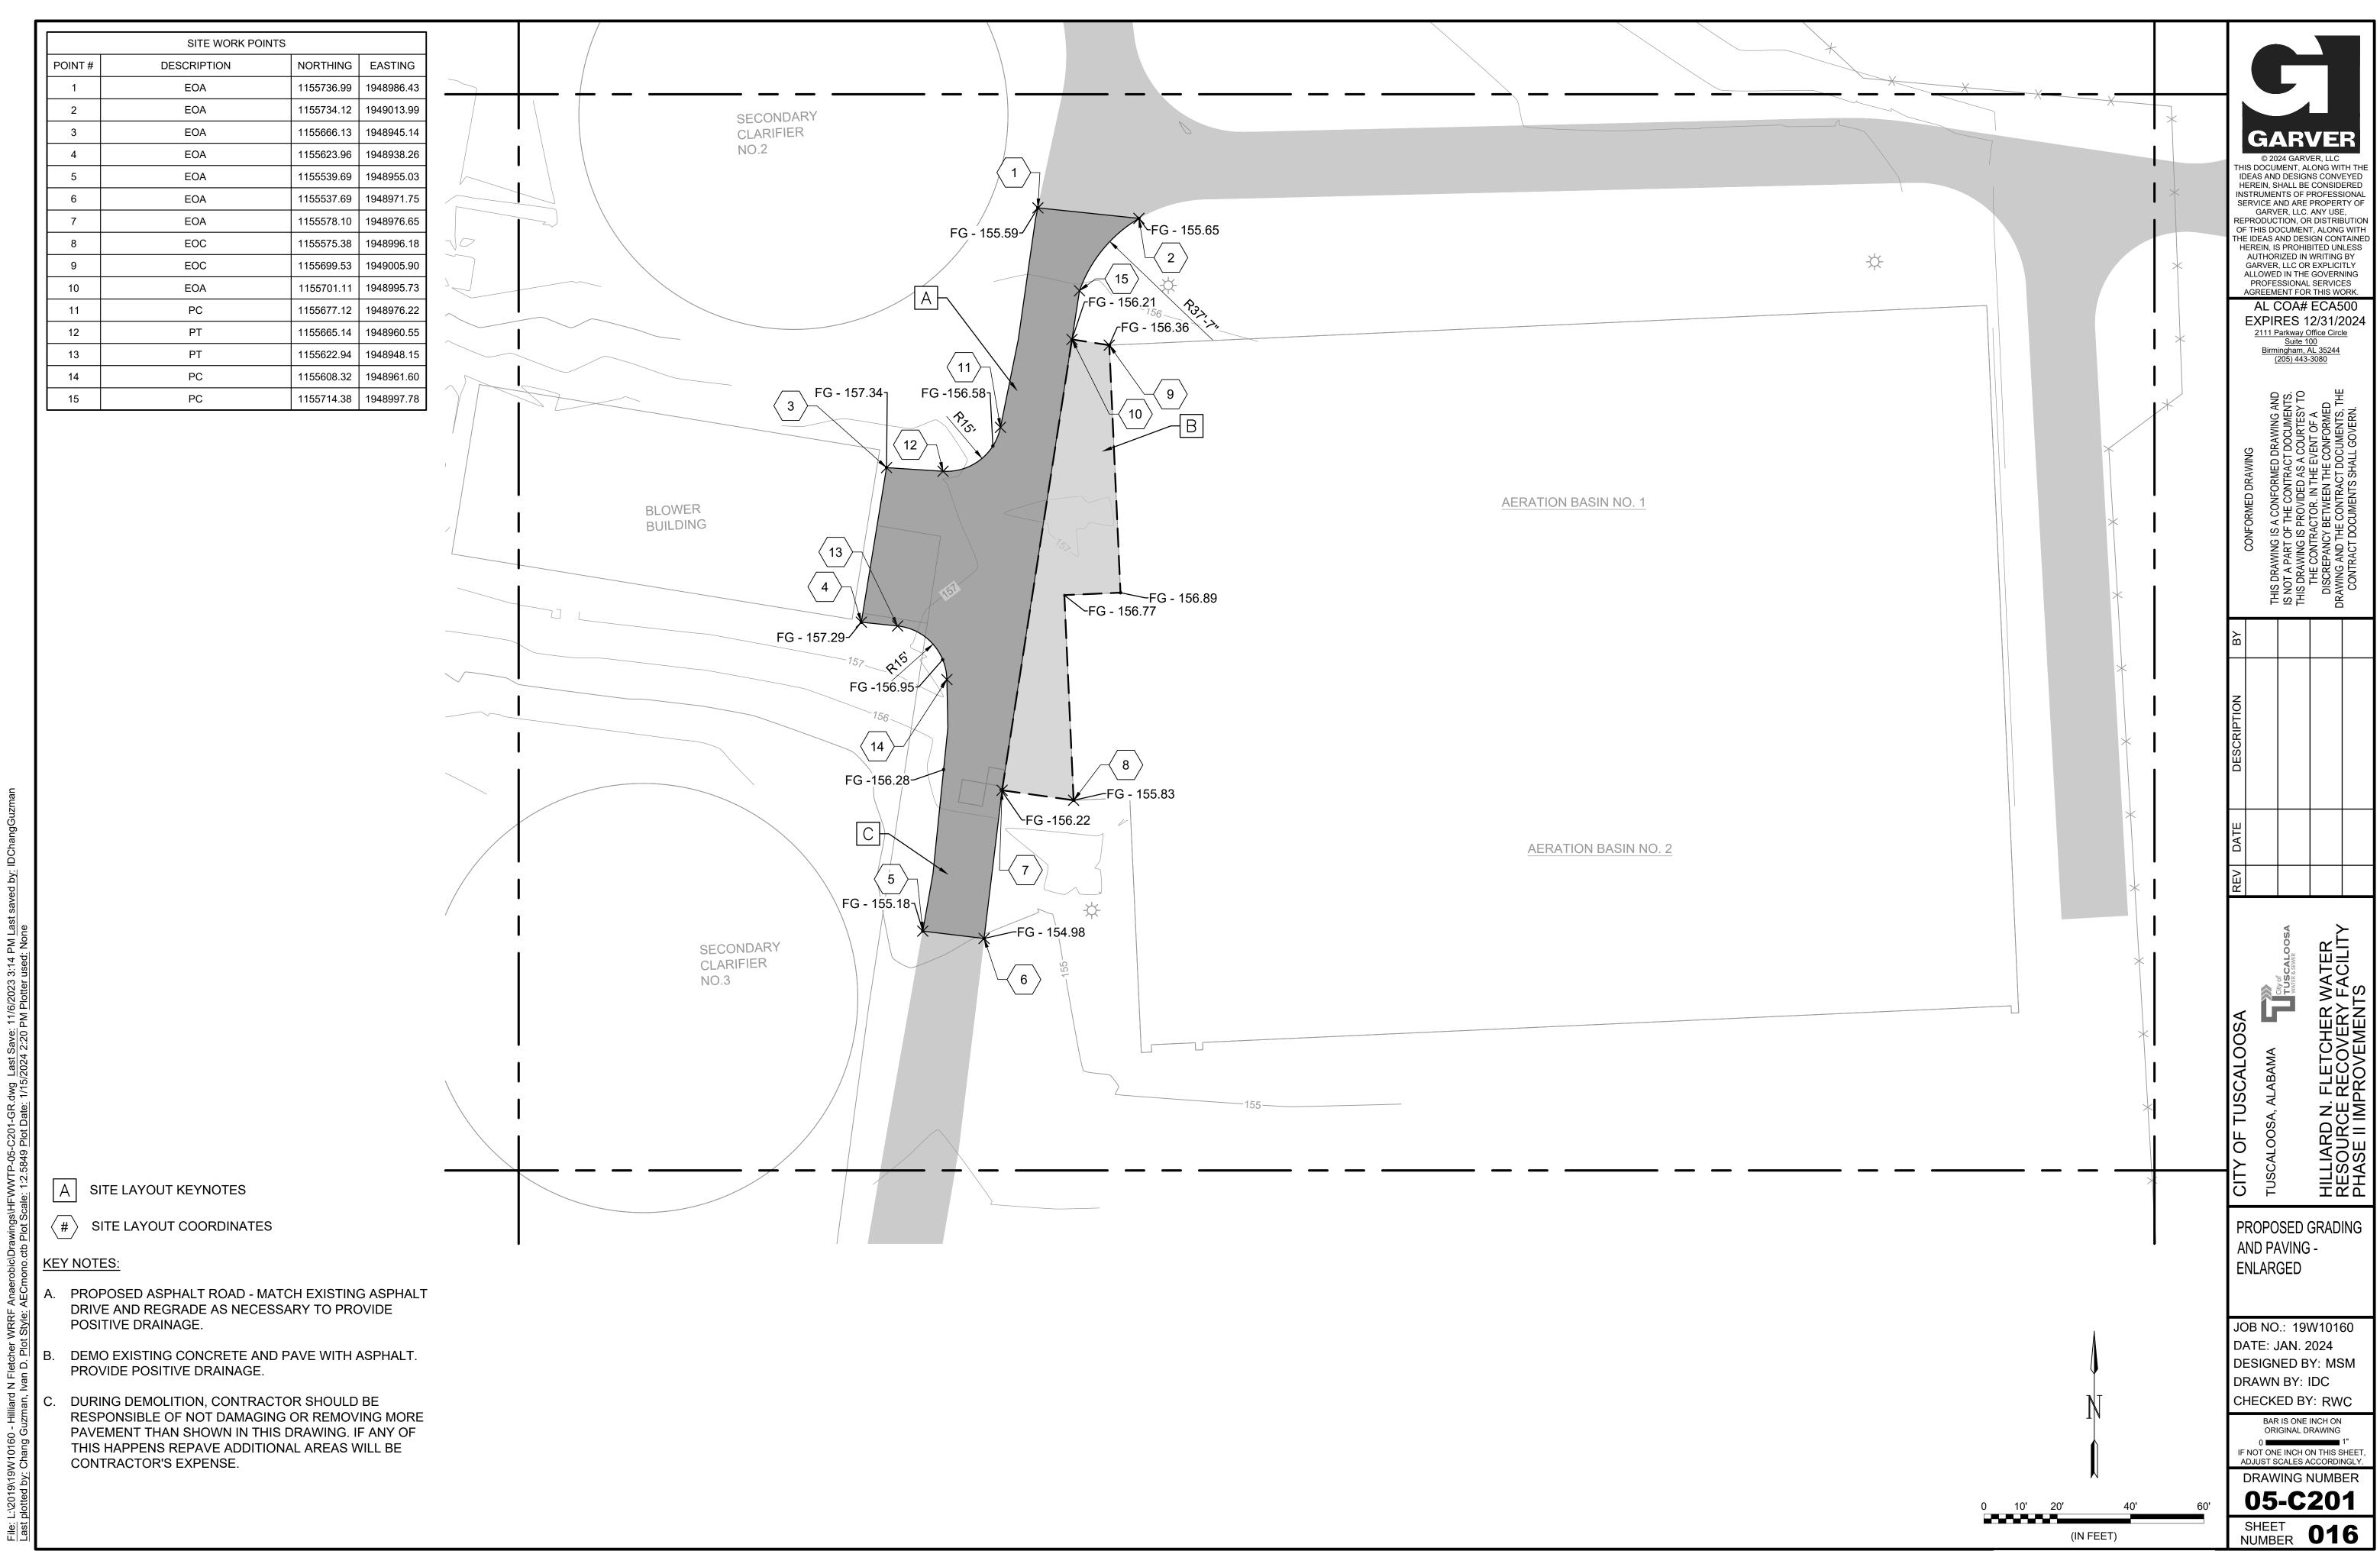
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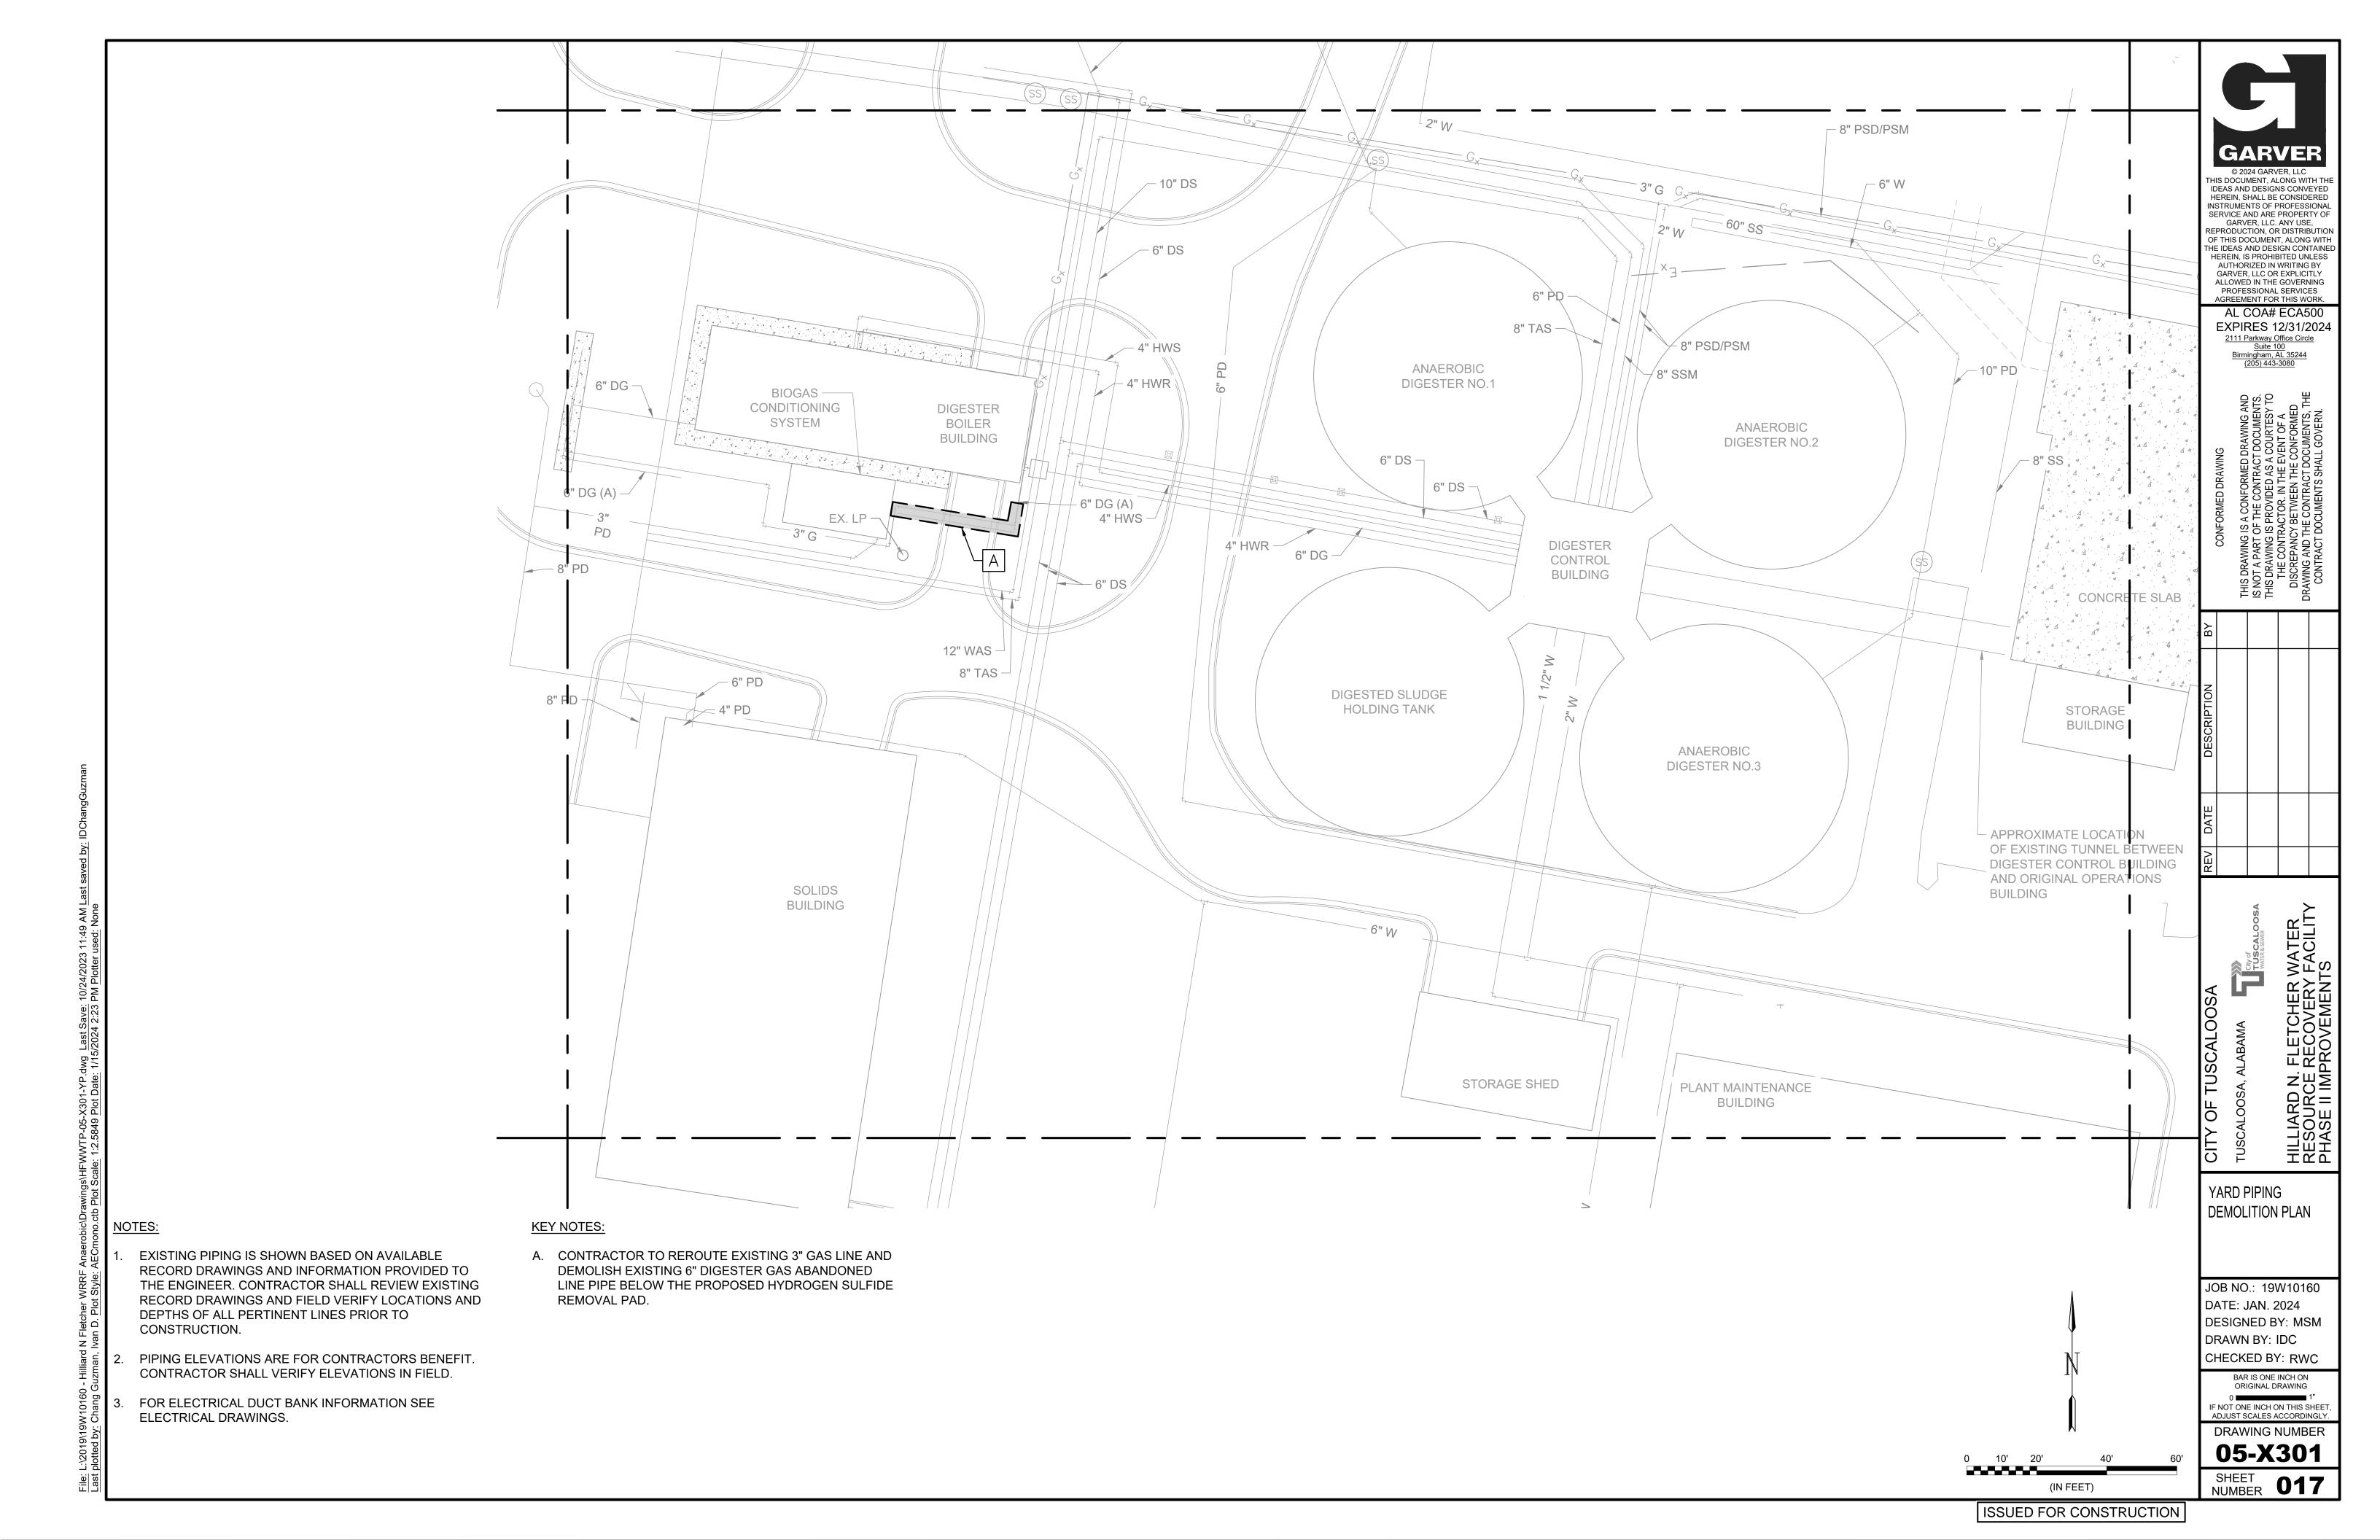







(IN FEET)



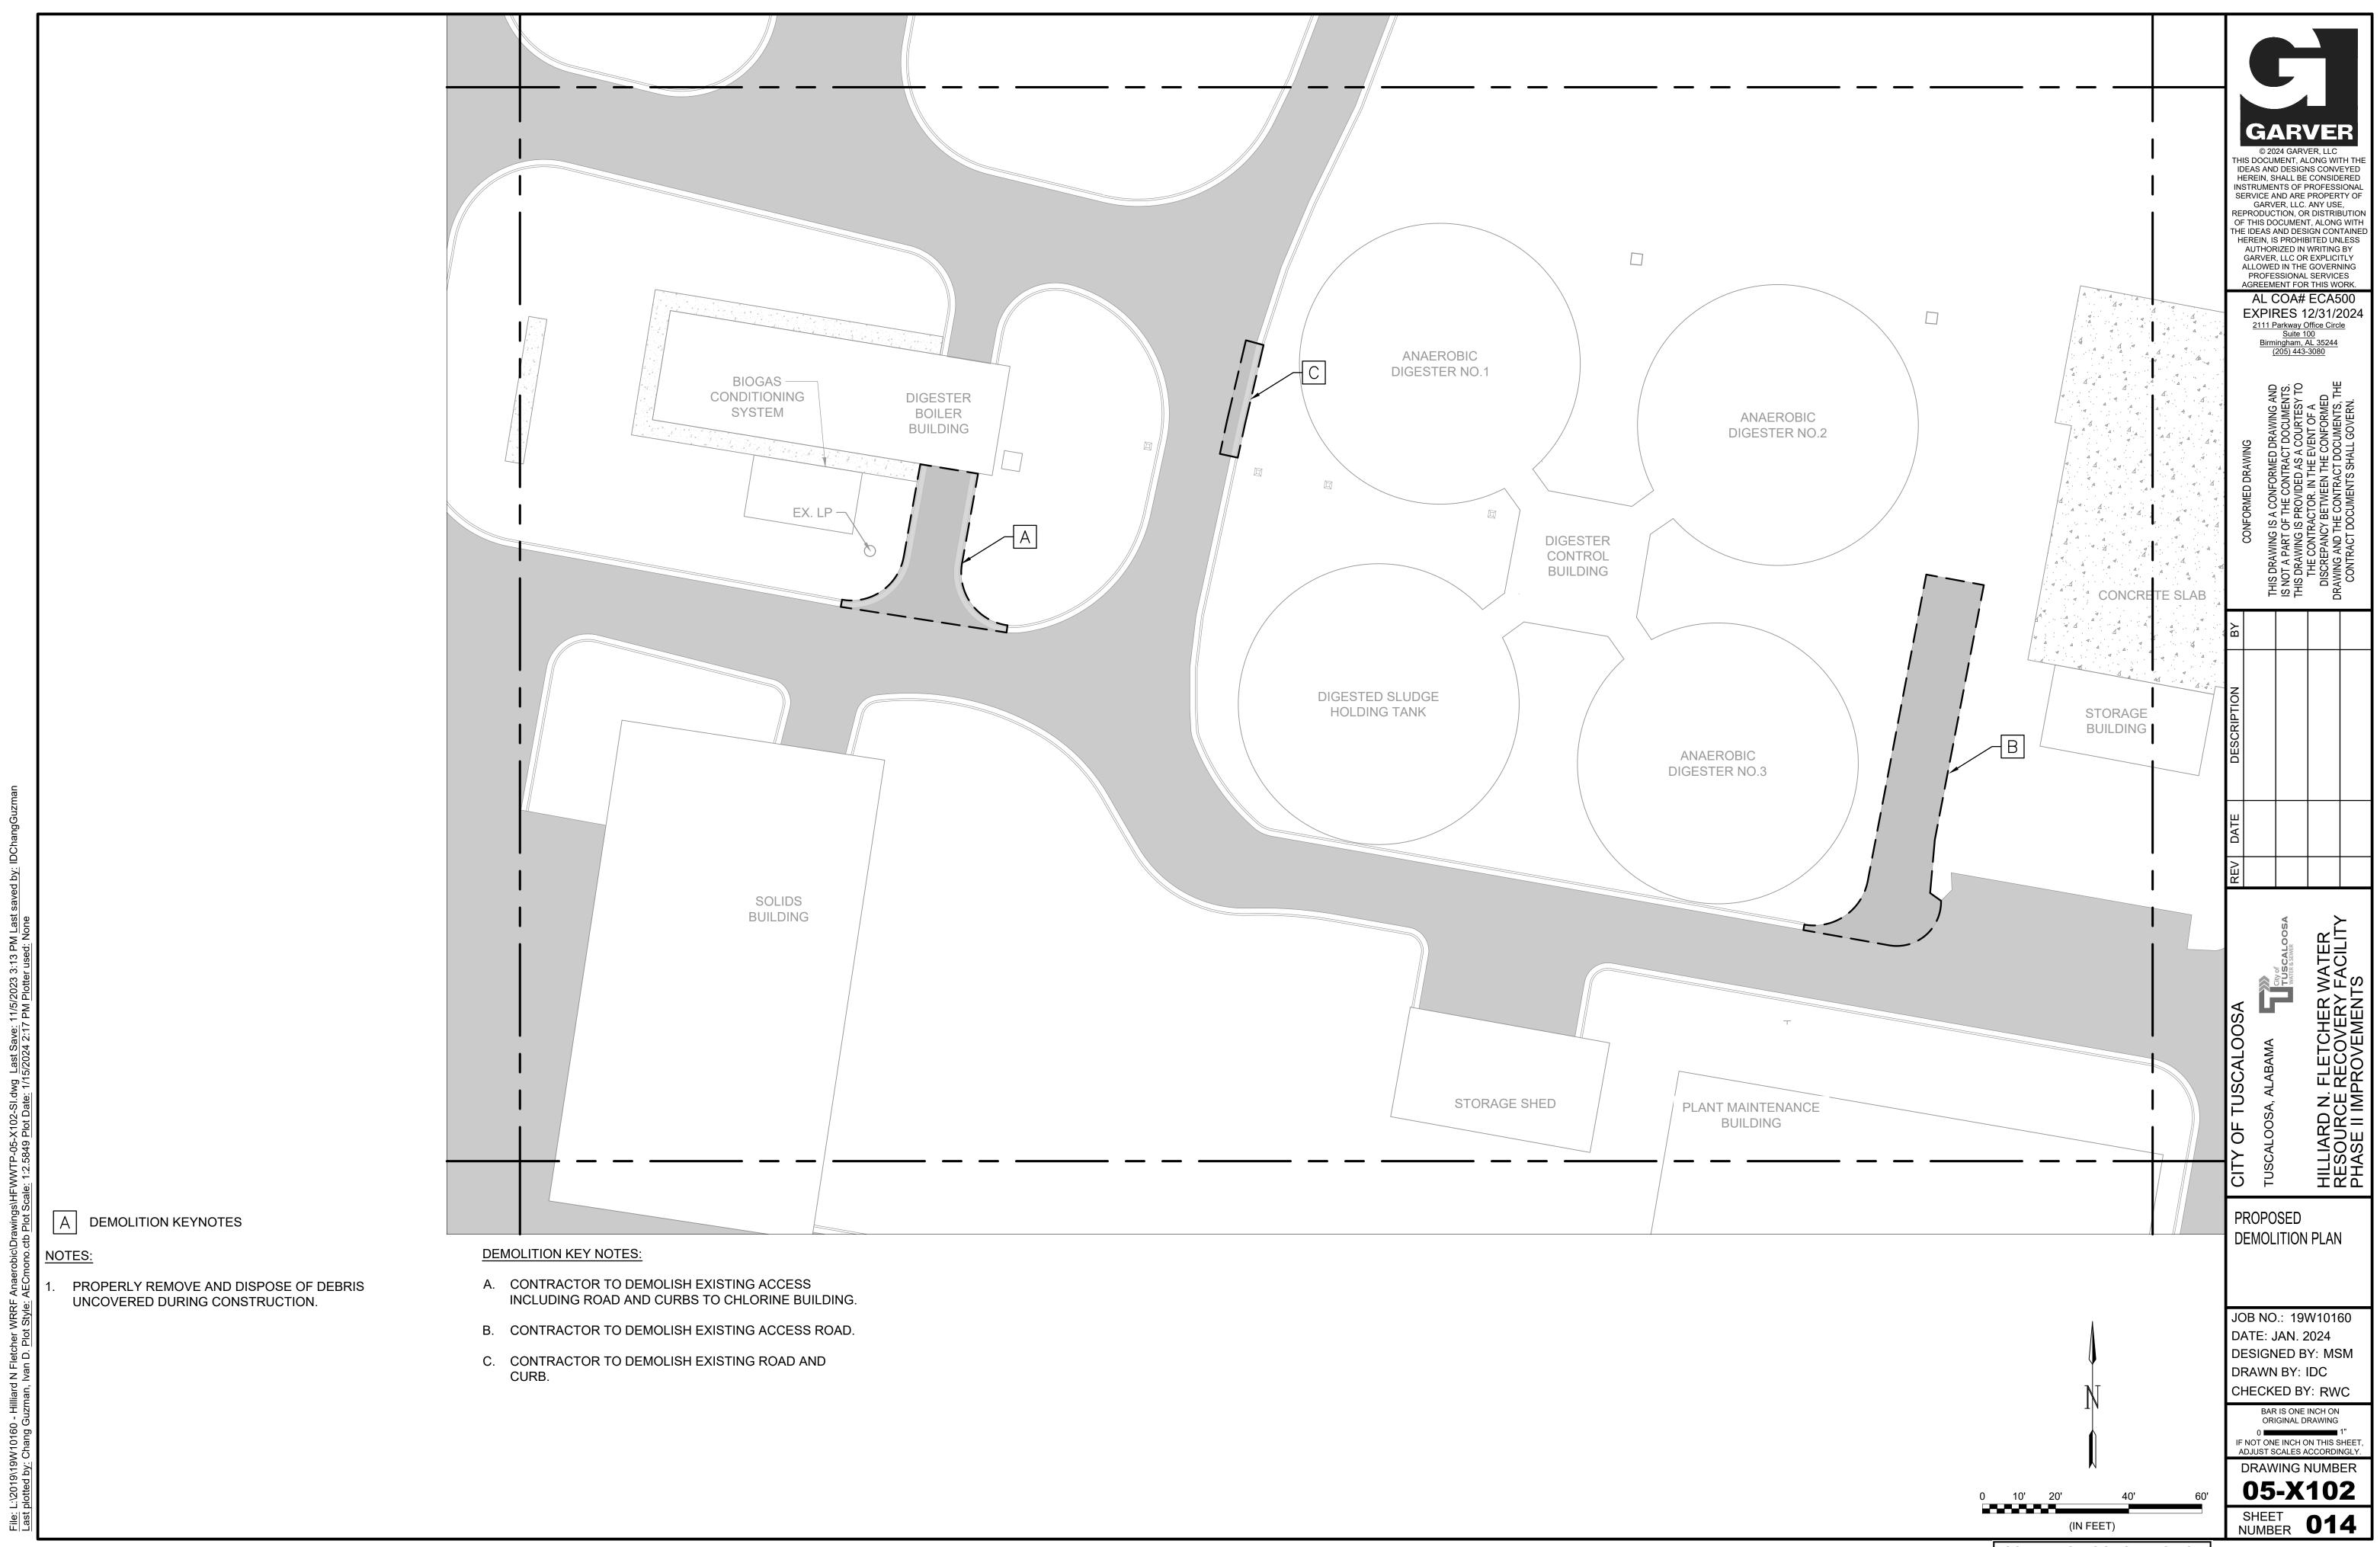

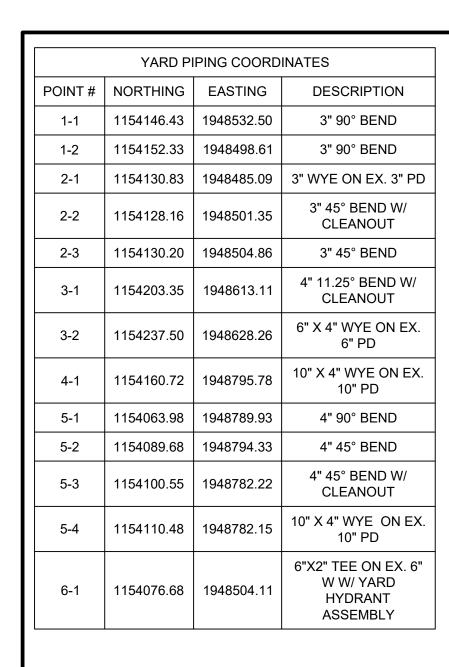



NOTES:

- 1. EXISTING PIPING IS SHOWN BASED ON AVAILABLE RECORD DRAWINGS AND INFORMATION PROVIDED TO THE ENGINEER. CONTRACTOR SHALL REVIEW EXISTING RECORD DRAWINGS AND FIELD VERIFY LOCATIONS AND DEPTHS OF ALL PERTINENT LINES PRIOR TO CONSTRUCTION.
- 2. PIPING ELEVATIONS ARE FOR CONTRACTORS BENEFIT. CONTRACTOR SHALL VERIFY ELEVATIONS IN FIELD.
- 3. FOR ELECTRICAL DUCT BANK INFORMATION SEE ELECTRICAL DRAWINGS.

A. INSTALL YARD HYDRANT.

ISSUED FOR CONSTRUCTION

(IN FEET)

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JOB NO.: 19W10160

DESIGNED BY: MSM

CHECKED BY: RWC

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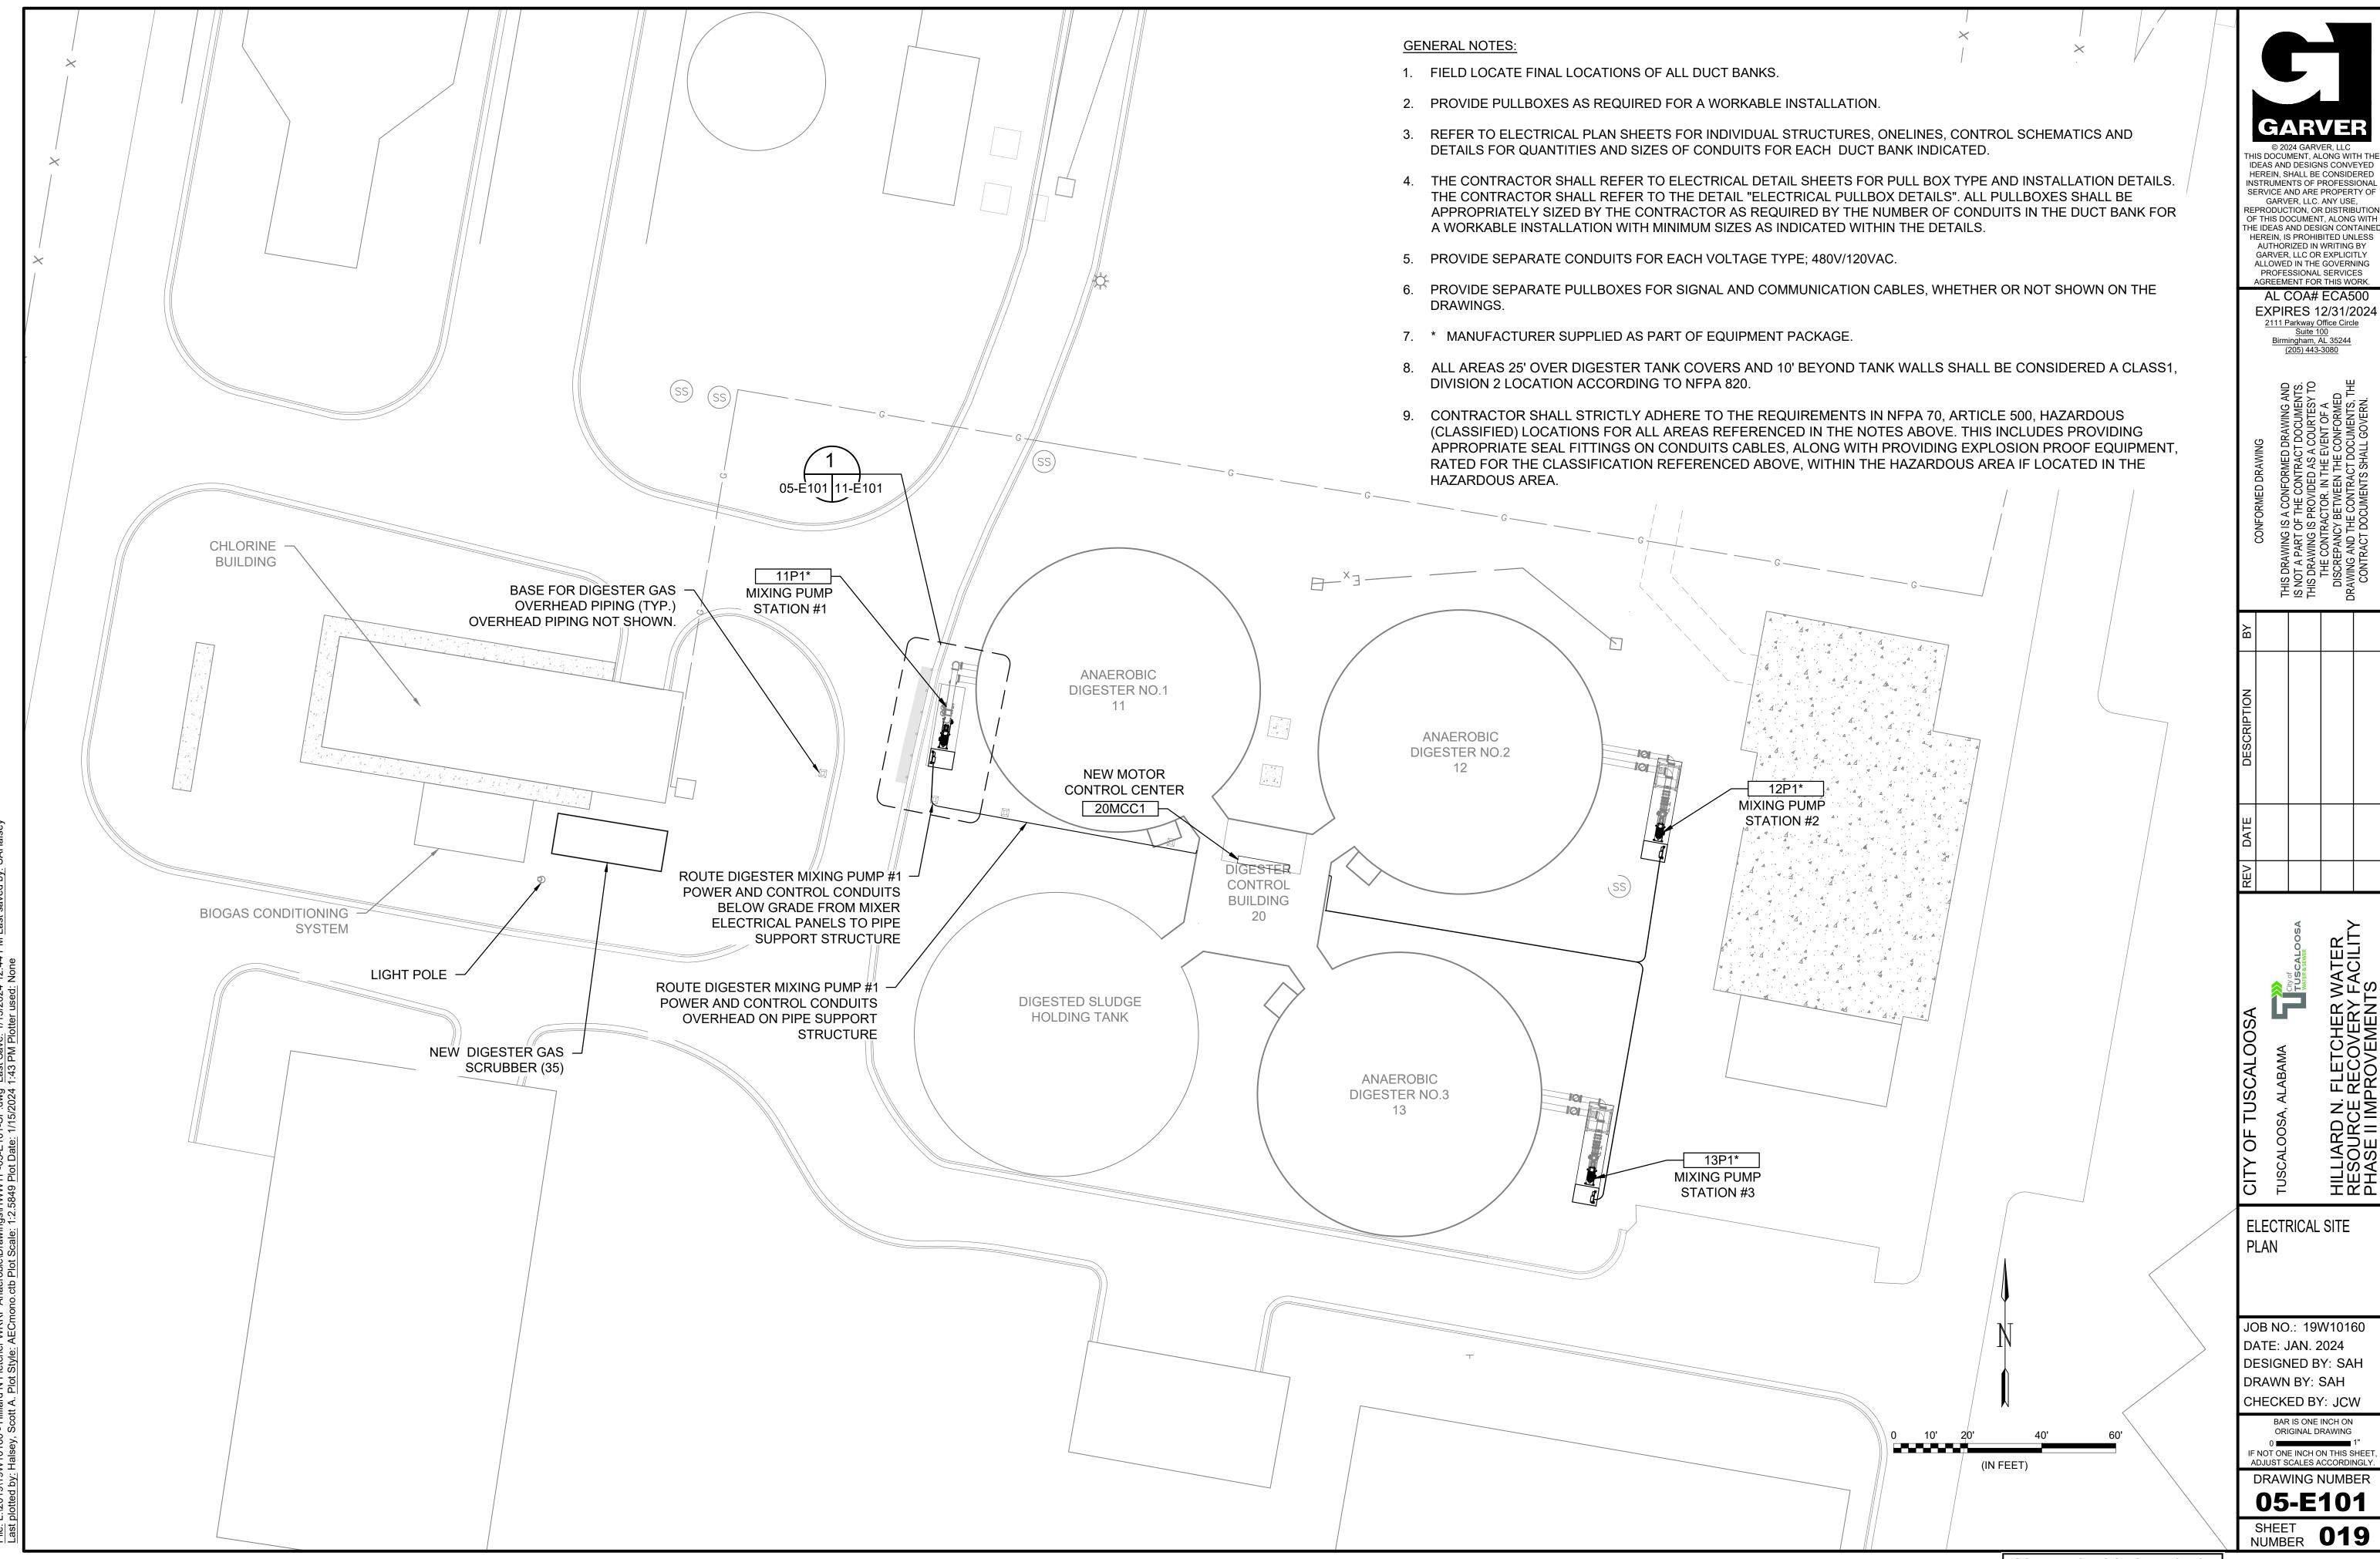
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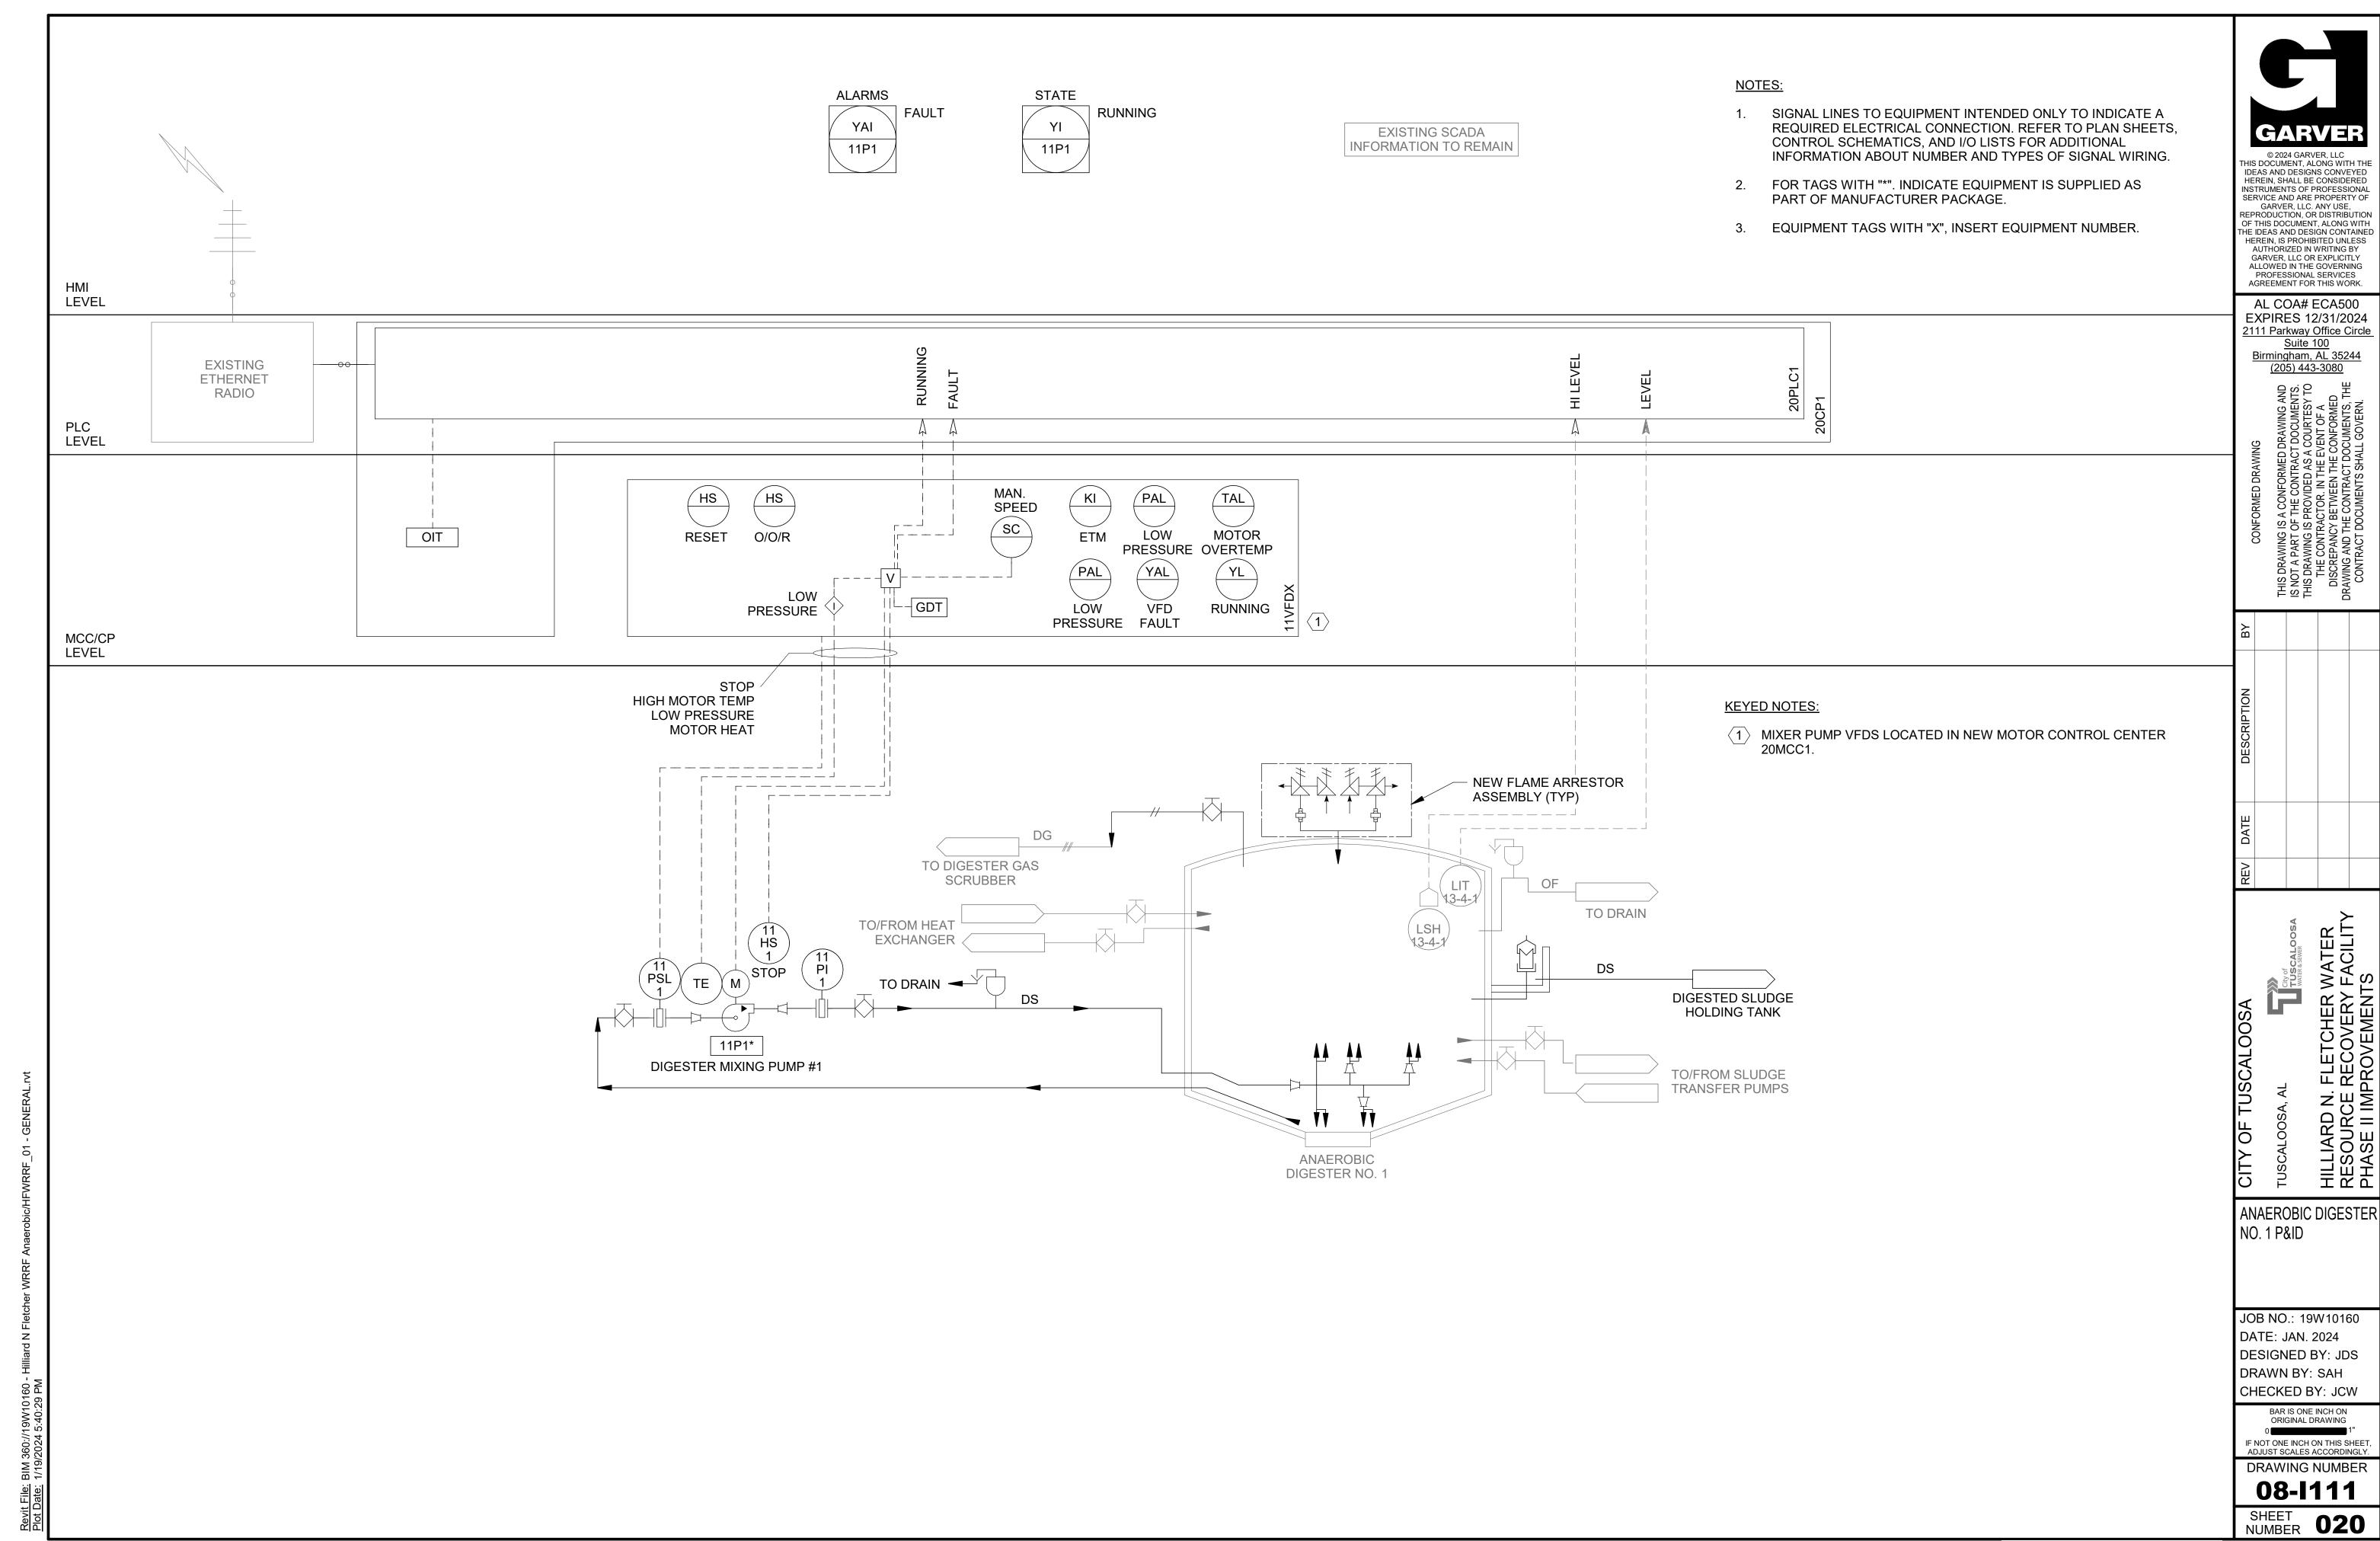
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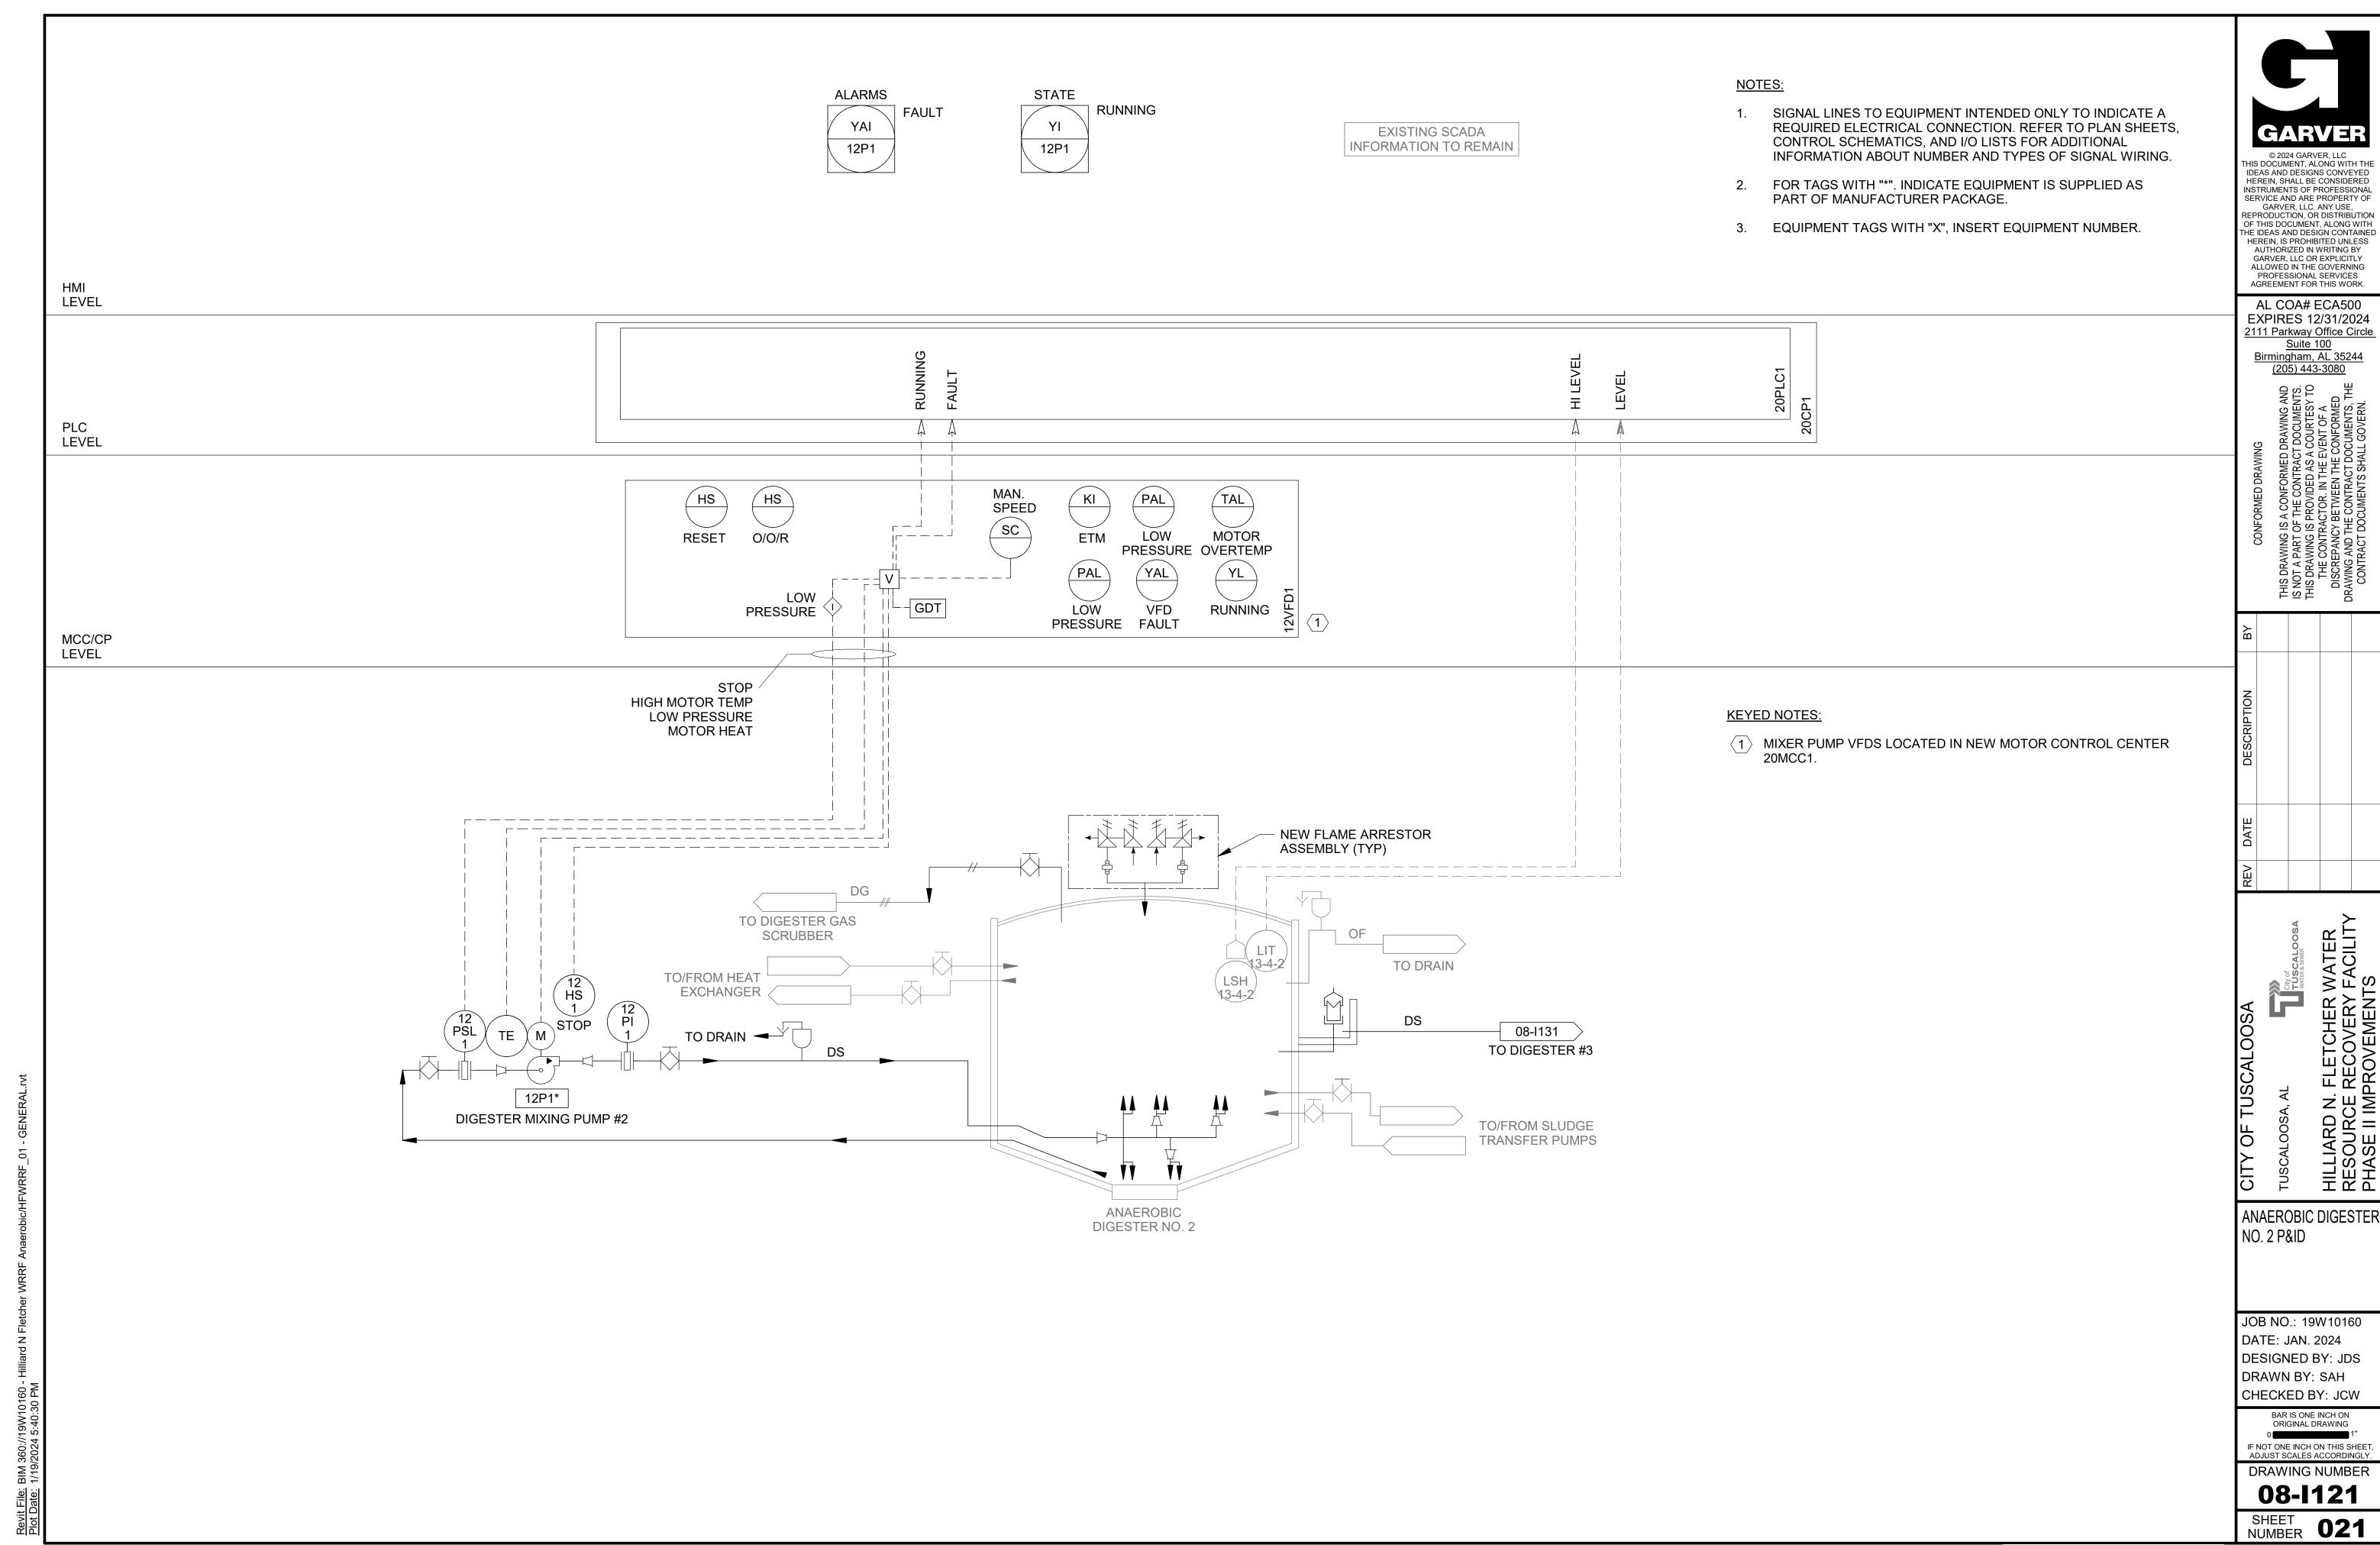
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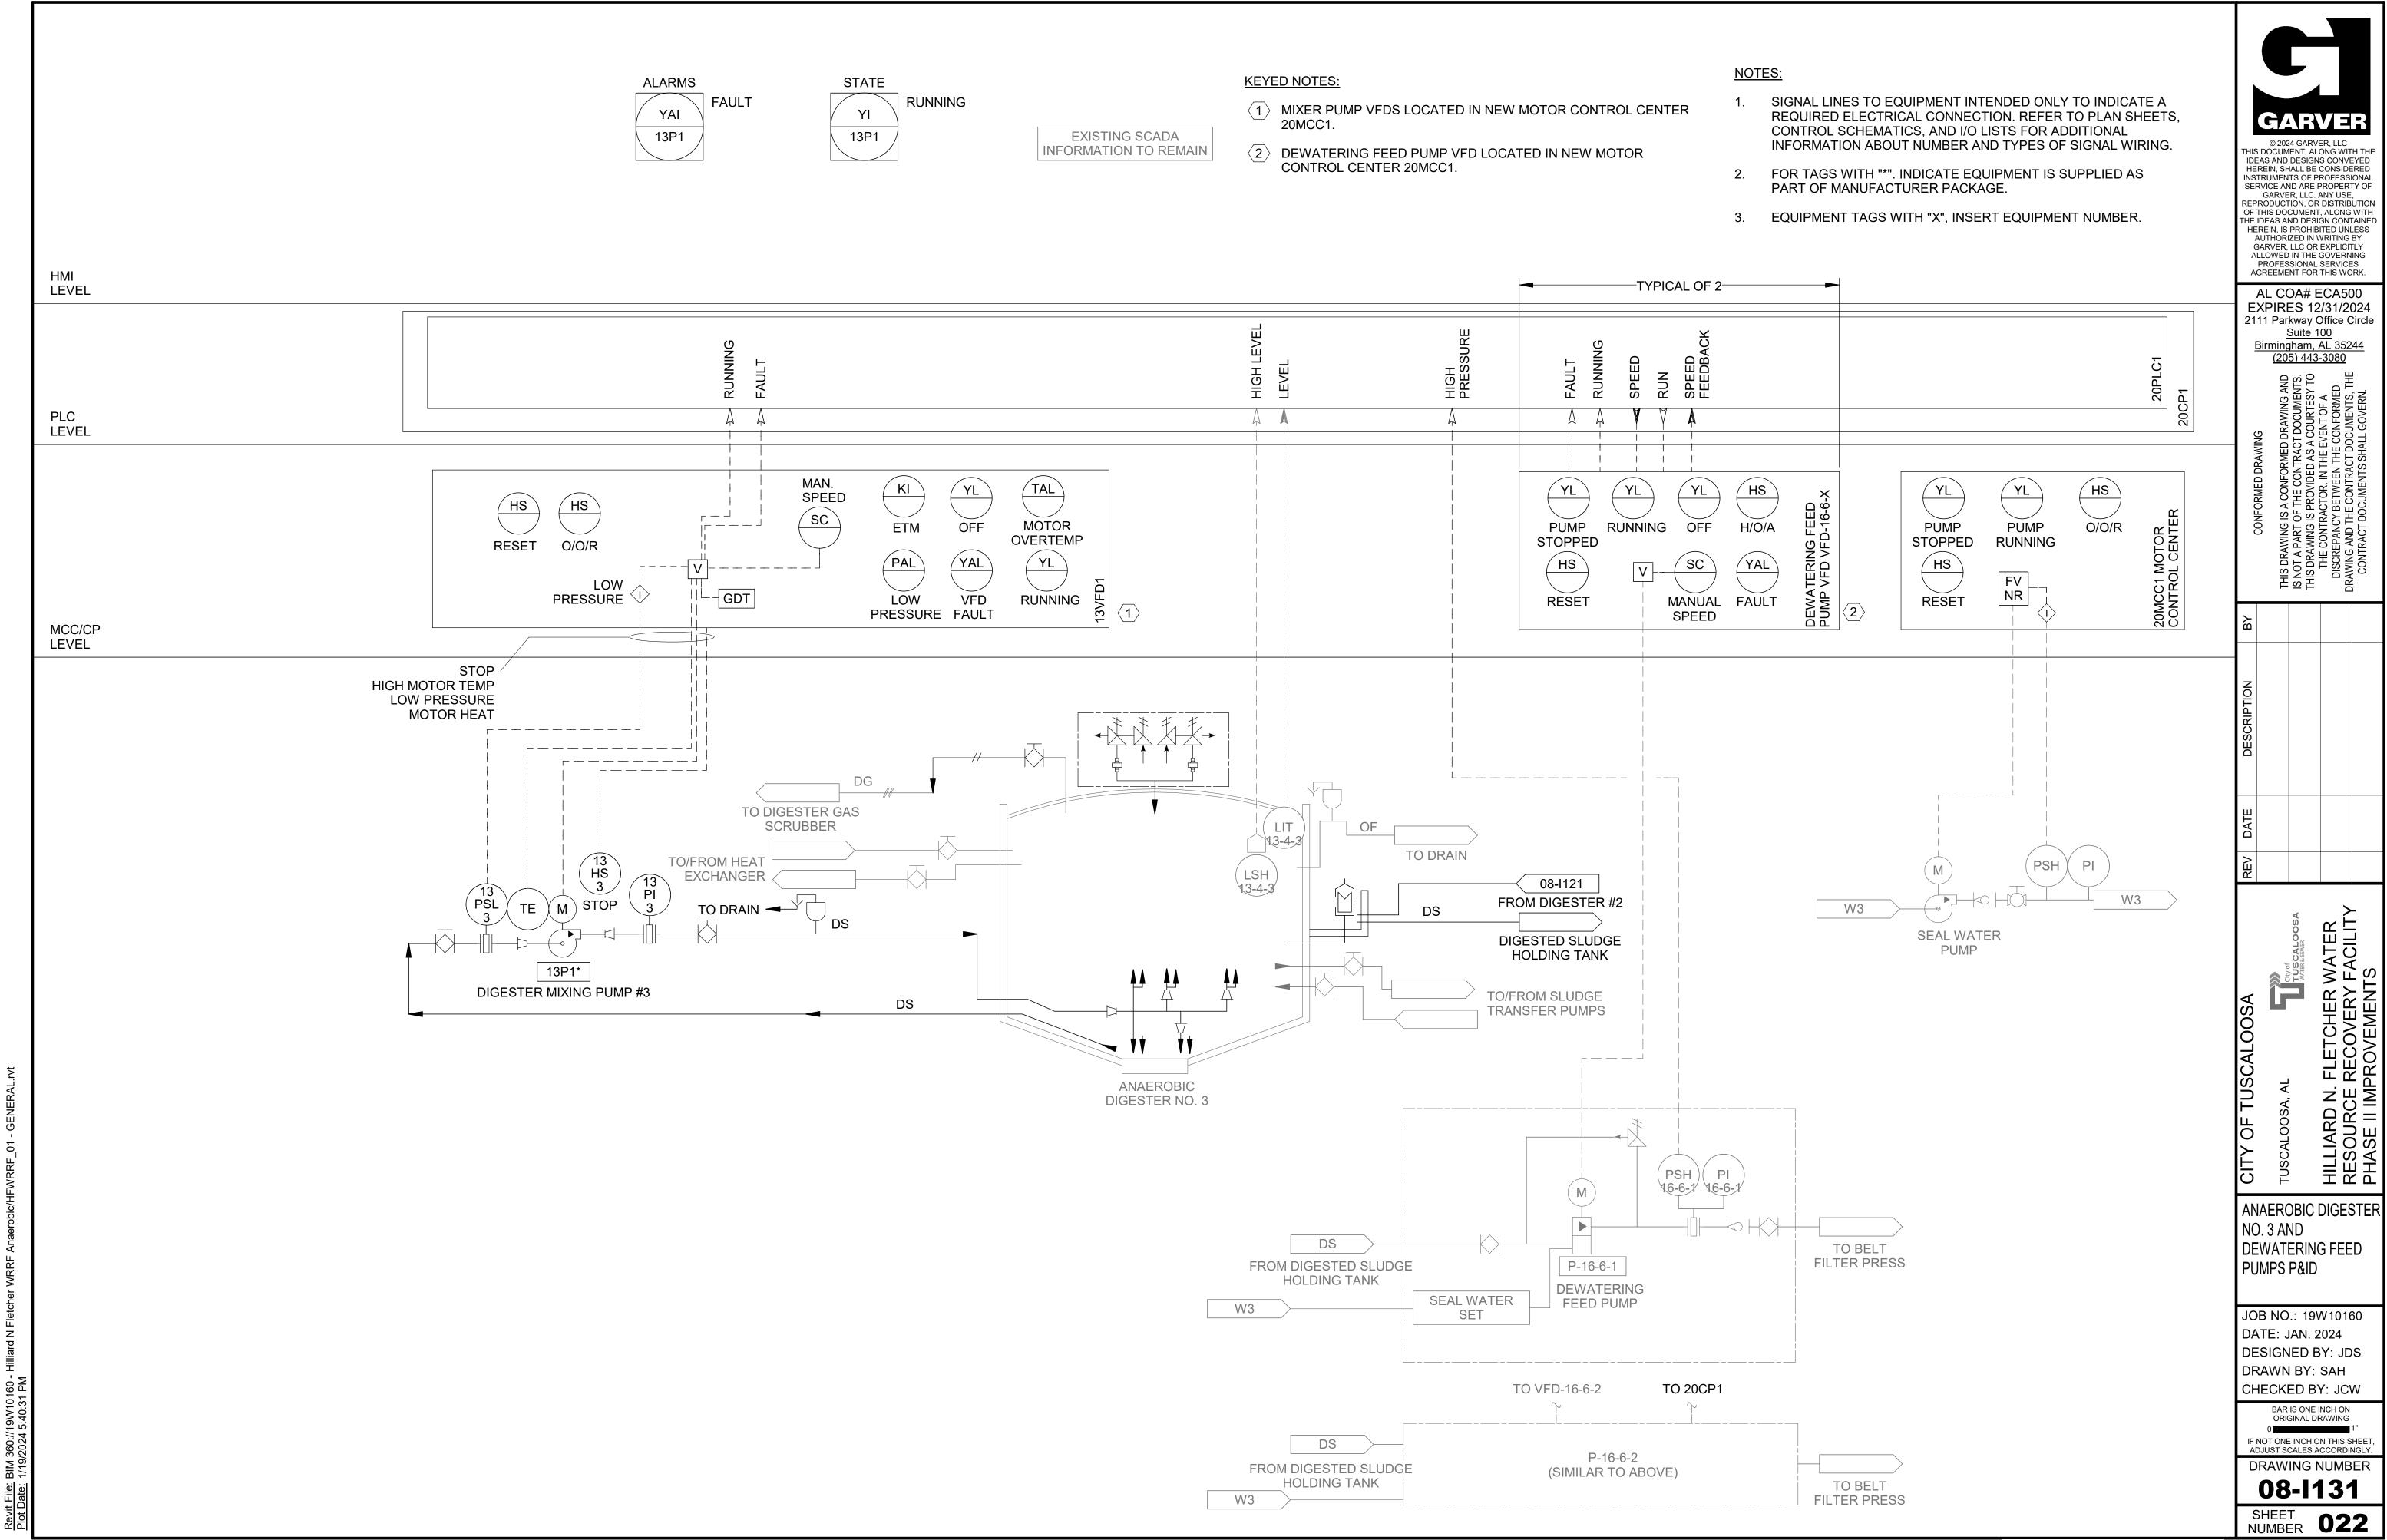
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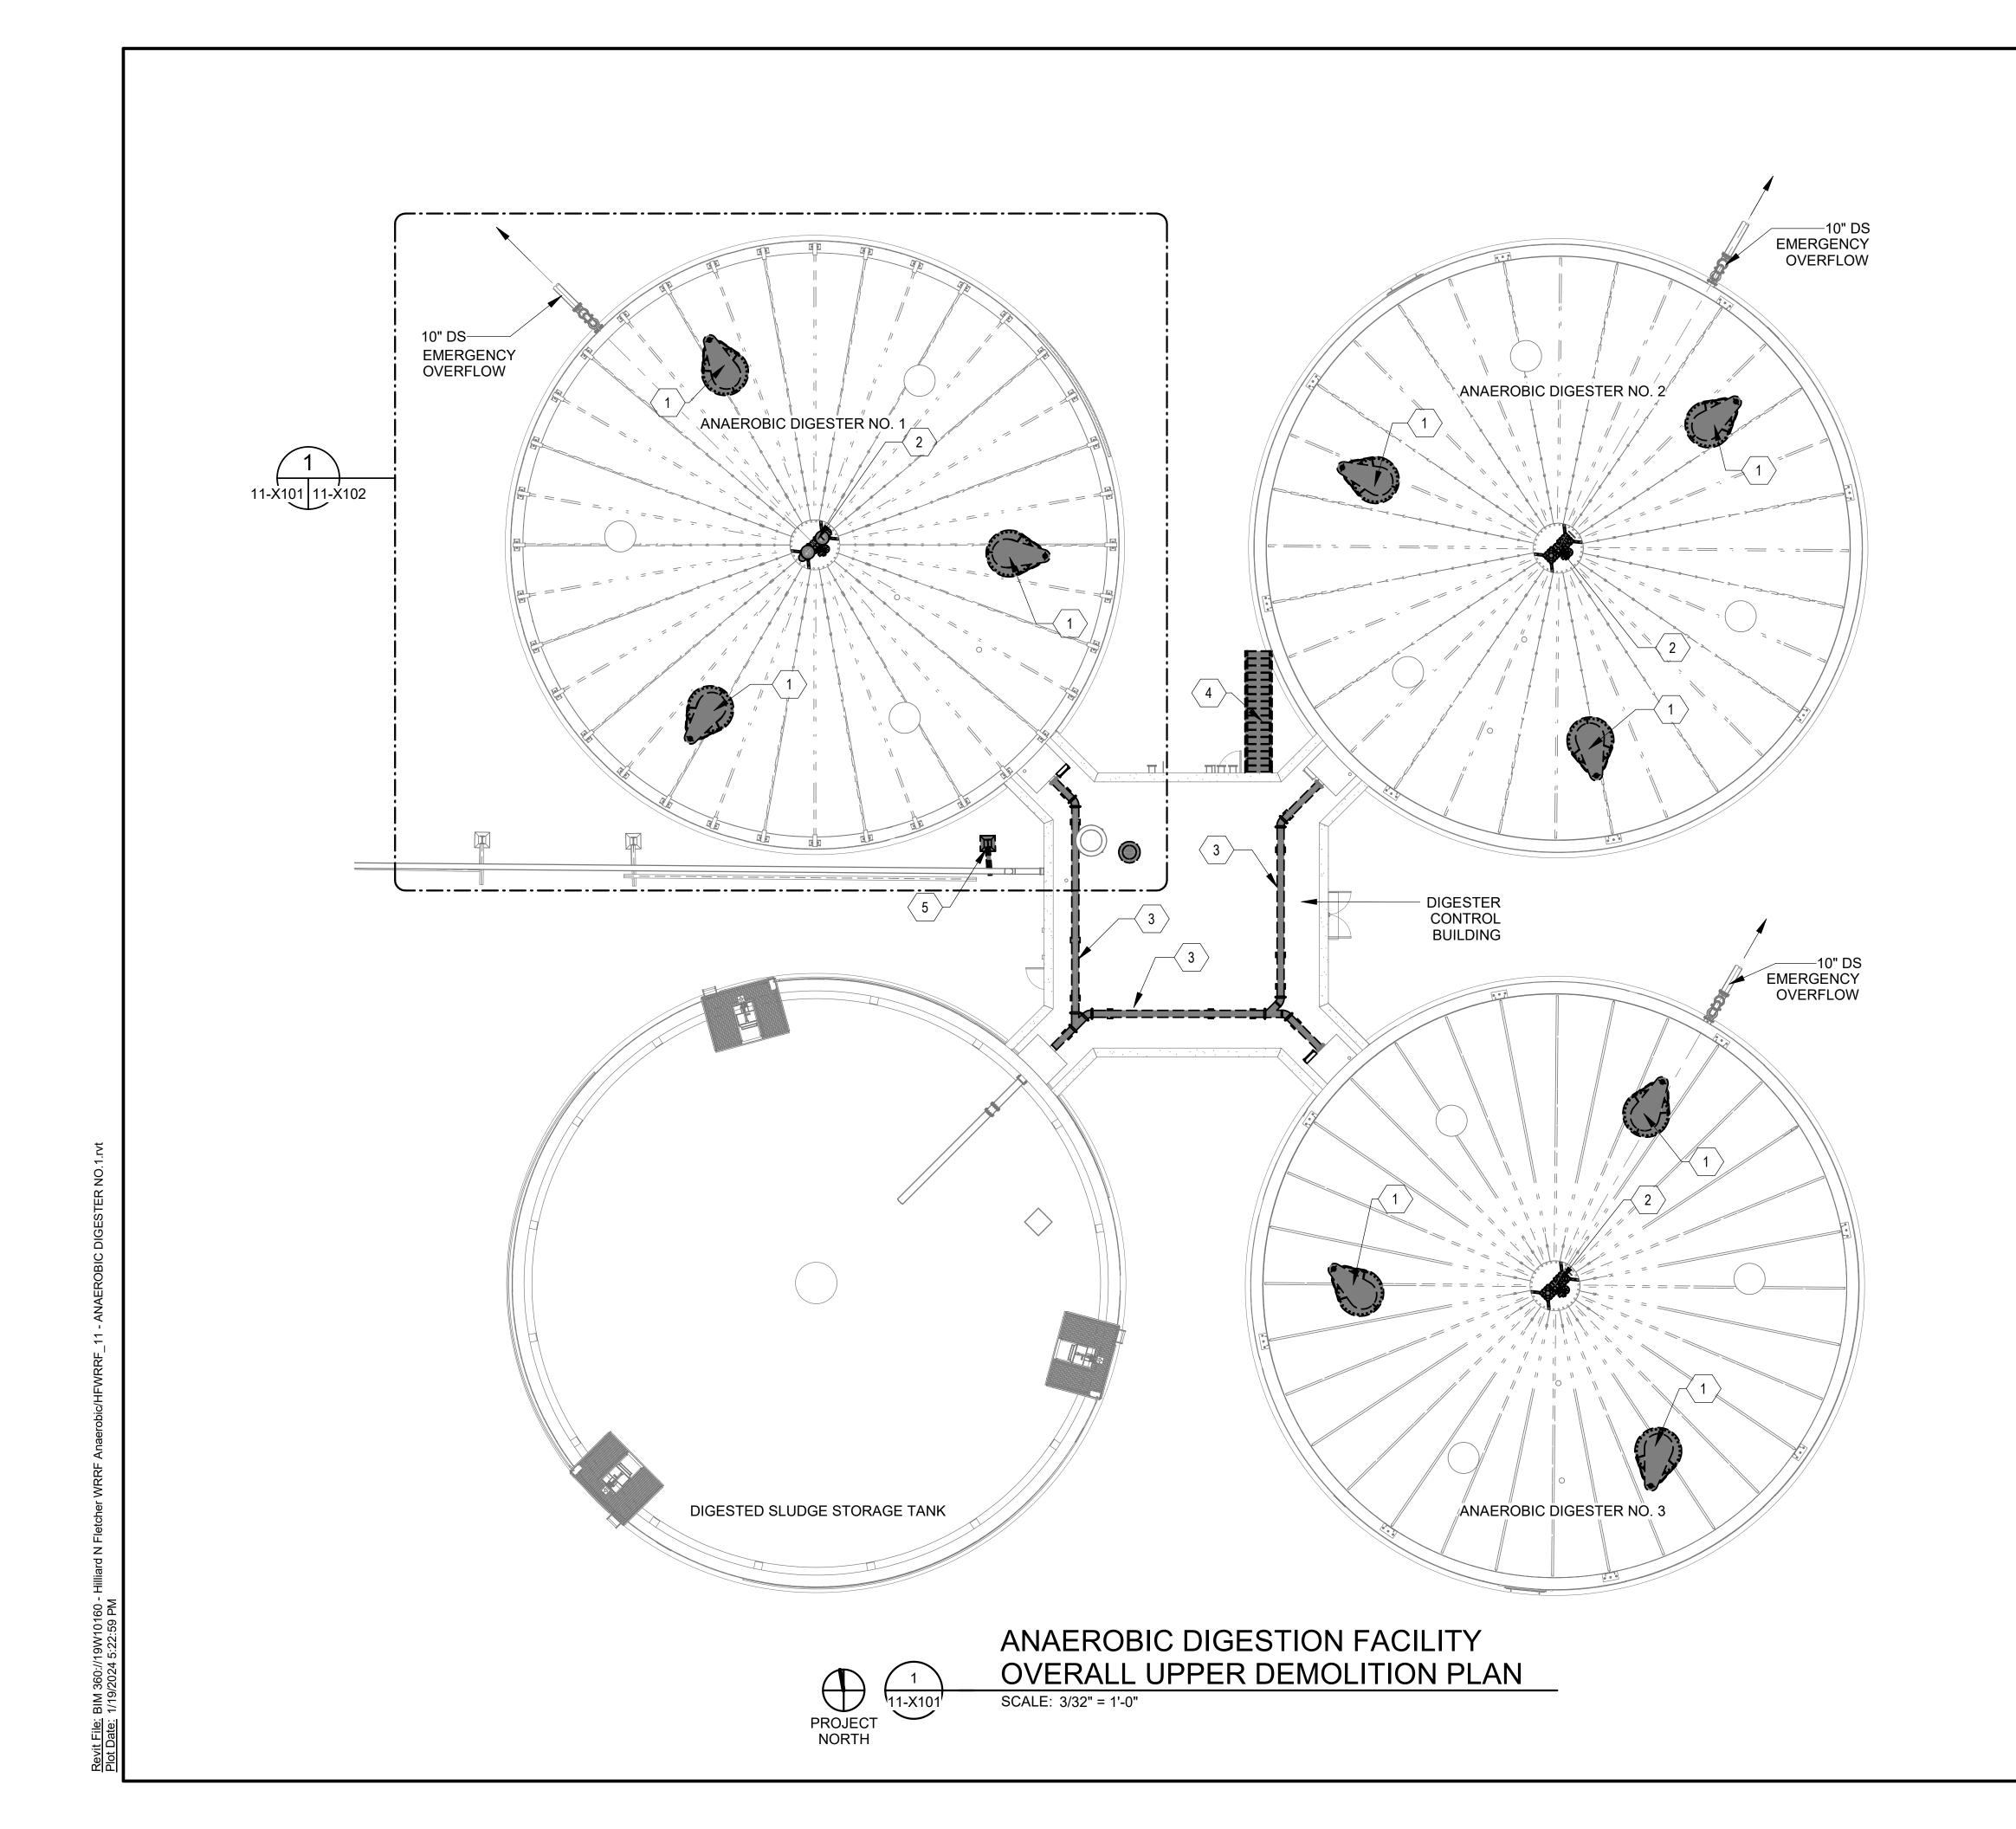
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KEYNOTES:

DENOTED BY SYMBOL (X

- 1 DEMOLISH ALL EXISTING DIGESTER MIXING EQUIPMENT, TUBE SECTIONS, AND CONCRETE MIXER SUPPORTS. DRILL OUT EXPOSED REINFORCEMENT AS NEEDED AND PATCH SURFACE OF DIGESTER SLAB, PROVIDE BOLT-ON COVER OVER COVER OPENING WITH APPROPRIATE GASKET SYSTEM FOR SEALING.
- 2 REMOVE FLAME ARRESTORS, PRESSURE/VACUUM RELIEF VALVES AND THREE WAY VALVE.
- 3 DEMOLISH AND DISPOSE EXISTING 10" DIGESTED SLUDGE TRANSFER PIPE AND ASSOCIATED SUPPORTS ON ROOF.
- 4 DEMOLISH AND DISPOSE EXISTING STAIRS.
- 5 RELOCATE EXISTING PIPE SUPPORT. PROVIDE TEMPORARY PIPE SUPPORT DURING CONSTRUCTION PHASE.

DEMOLITION LEGEND

TO BE DEMOLISHED

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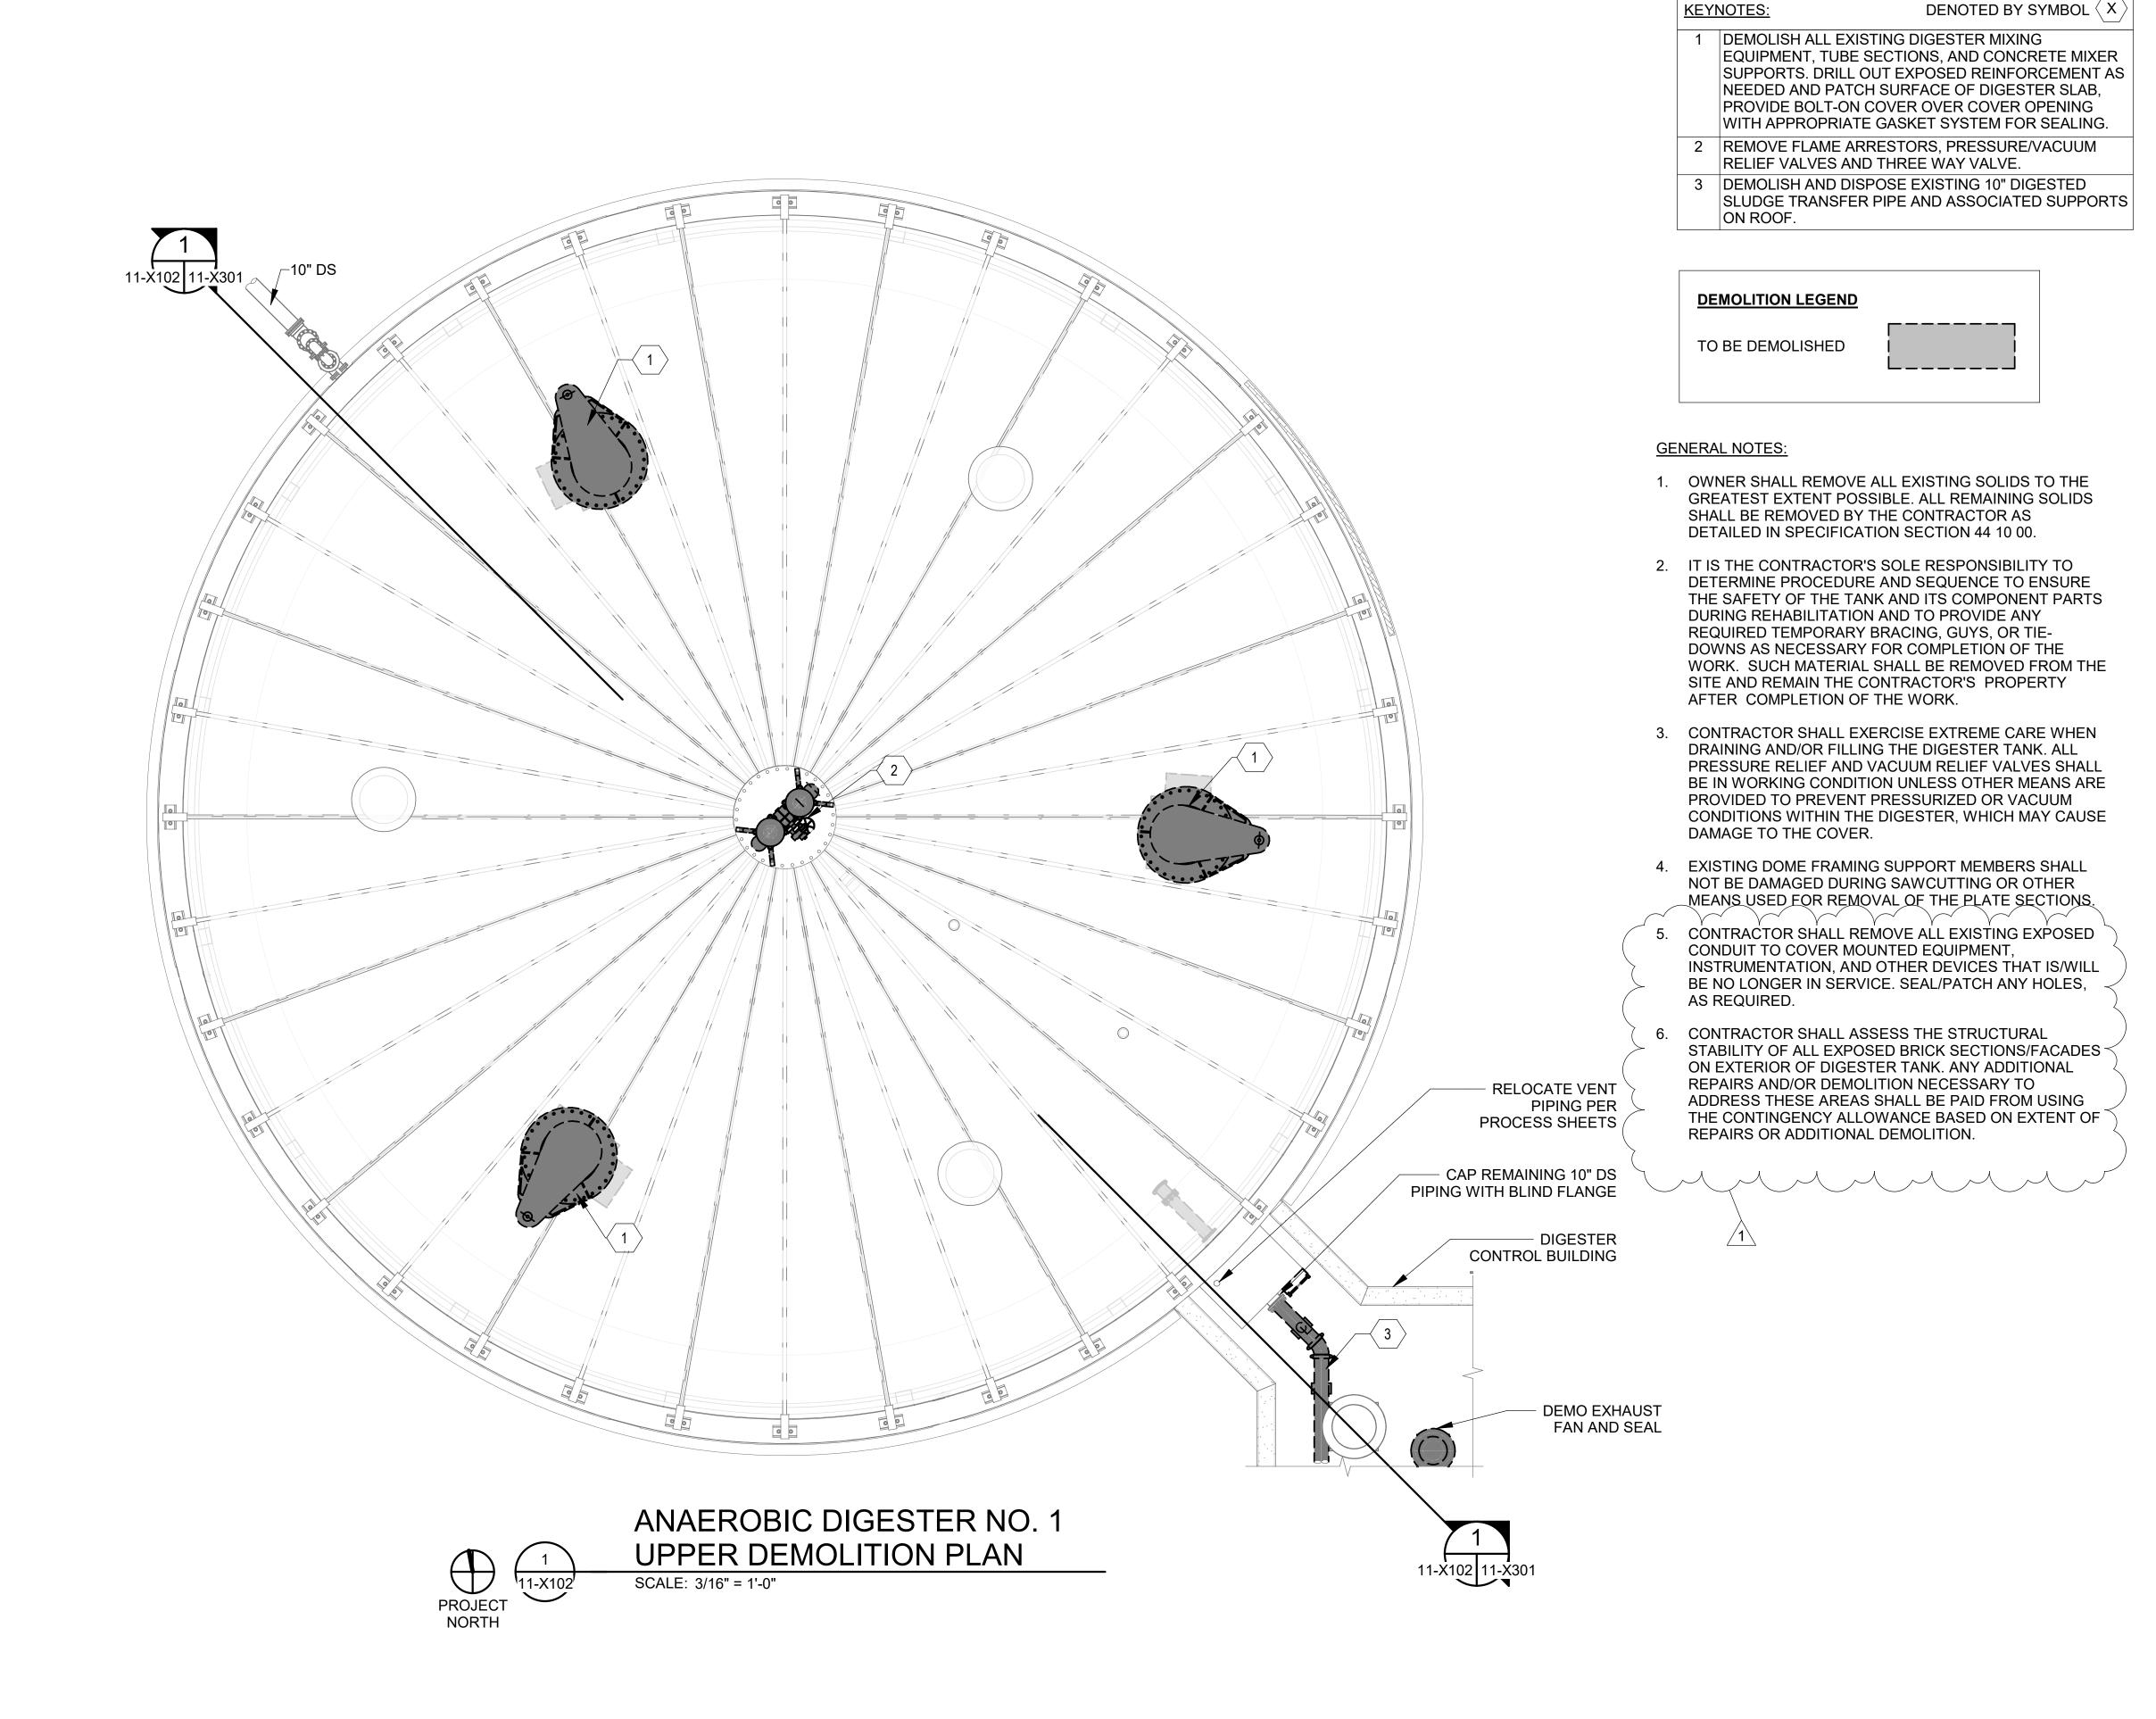
ANAEROBIC DIGESTION FACILITY UPPER DEMOLITION

JOB NO.: 19W10160 DATE: JAN. 2024 DESIGNED BY: RWC DRAWN BY: WTL CHECKED BY: RDT

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11-X101 SHEET NUMBER 023



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N. FLETCHER WATER

ANAEROBIC DIGESTER
NO. 1 UPPER
DEMOLITION PLAN

JOB NO.: 19W10160 DATE: JAN. 2024 DESIGNED BY: RWC DRAWN BY: WTL CHECKED BY: RDT

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DRAWING NUMBER

KEYNOTES:

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DEMOLISH ALL EXISTING DIGESTER MIXING EQUIPMENT, TUBE SECTIONS, AND CONCRETE MIXER SUPPORTS. DRILL OUT EXPOSED REINFORCEMENT AS NEEDED AND PATCH SURFACE OF DIGESTER SLAB, PROVIDE BOLT-ON COVER OVER COVER OPENING WITH APPROPRIATE GASKET SYSTEM FOR SEALING.

2 DEMOLISH AND REMOVE EXISTING DIGESTER RECIRCULATION PIPING AND SUPPORT STRUCTURE. EXISTING PIPING TO BE DEMO'D UP TO THE FIRST FLANGE FROM THE WALL. DRILL OUT EXPOSED REINFORCEMENT AS NEEDED AND PATCH SURFACE OF DIGESTER SLAB.

3 DEMOLISH EXISTING DAMAGED BRICK SECTION AND REPLACE IN KIND WITH MATCHING BRICK FACADE.

4 DEMOLISH EXISTING BRICK FACADE TO EXTENT NECESSARY TO INSTALL NEW DIGESTER TRANSFER BOX. REPLACE BRICK FACADE UP TO THE EDGE OF THE TRANSFER BOXES WITH MATCHING BRICK

DEMOLITION LEGEND

TO BE DEMOLISHED




GENERAL NOTES:

1. OWNER SHALL REMOVE ALL EXISTING SOLIDS TO THE GREATEST EXTENT POSSIBLE. ALL REMAINING SOLIDS SHALL BE REMOVED BY THE CONTRACTOR AS DETAILED IN SPECIFICATION SECTION 44 10 00.

2. IT IS THE CONTRACTOR'S SOLE RESPONSIBILITY TO DETERMINE PROCEDURE AND SEQUENCE TO ENSURE THE SAFETY OF THE TANK AND ITS COMPONENT PARTS DURING REHABILITATION AND TO PROVIDE ANY REQUIRED TEMPORARY BRACING, GUYS, OR TIE-DOWNS AS NECESSARY FOR COMPLETION OF THE WORK. SUCH MATERIAL SHALL BE REMOVED FROM THE SITE AND REMAIN THE CONTRACTOR'S PROPERTY AFTER COMPLETION OF THE WORK.

CONTRACTOR SHALL EXERCISE EXTREME CARE WHEN DRAINING AND/OR FILLING THE DIGESTER TANK. ALL PRESSURE RELIEF AND VACUUM RELIEF VALVES SHALL BE IN WORKING CONDITION UNLESS OTHER MEANS ARE PROVIDED TO PREVENT PRESSURIZED OR VACUUM CONDITIONS WITHIN THE DIGESTER, WHICH MAY CAUSE DAMAGE TO THE COVER.

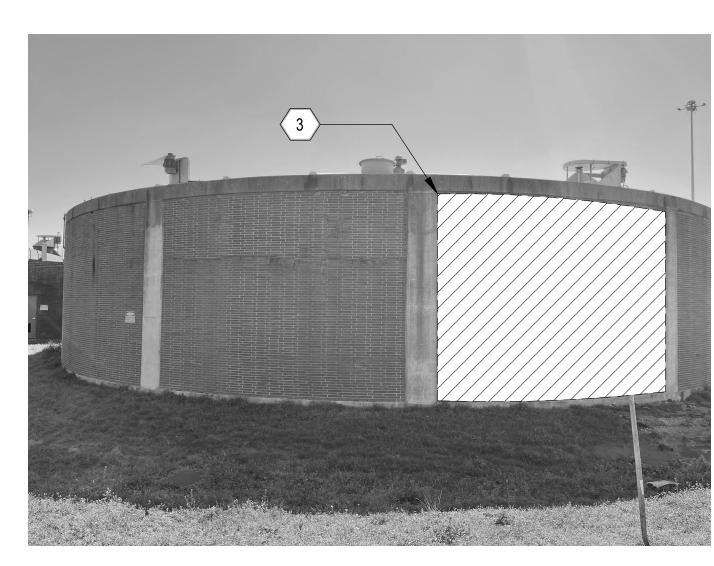

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ANAEROBIC DIGESTER NO. 1 LOWER DEMOLITION PLAN

JOB NO.: 19W10160 DATE: JAN. 2024 **DESIGNED BY: RWC** DRAWN BY: WTL CHECKED BY: RDT

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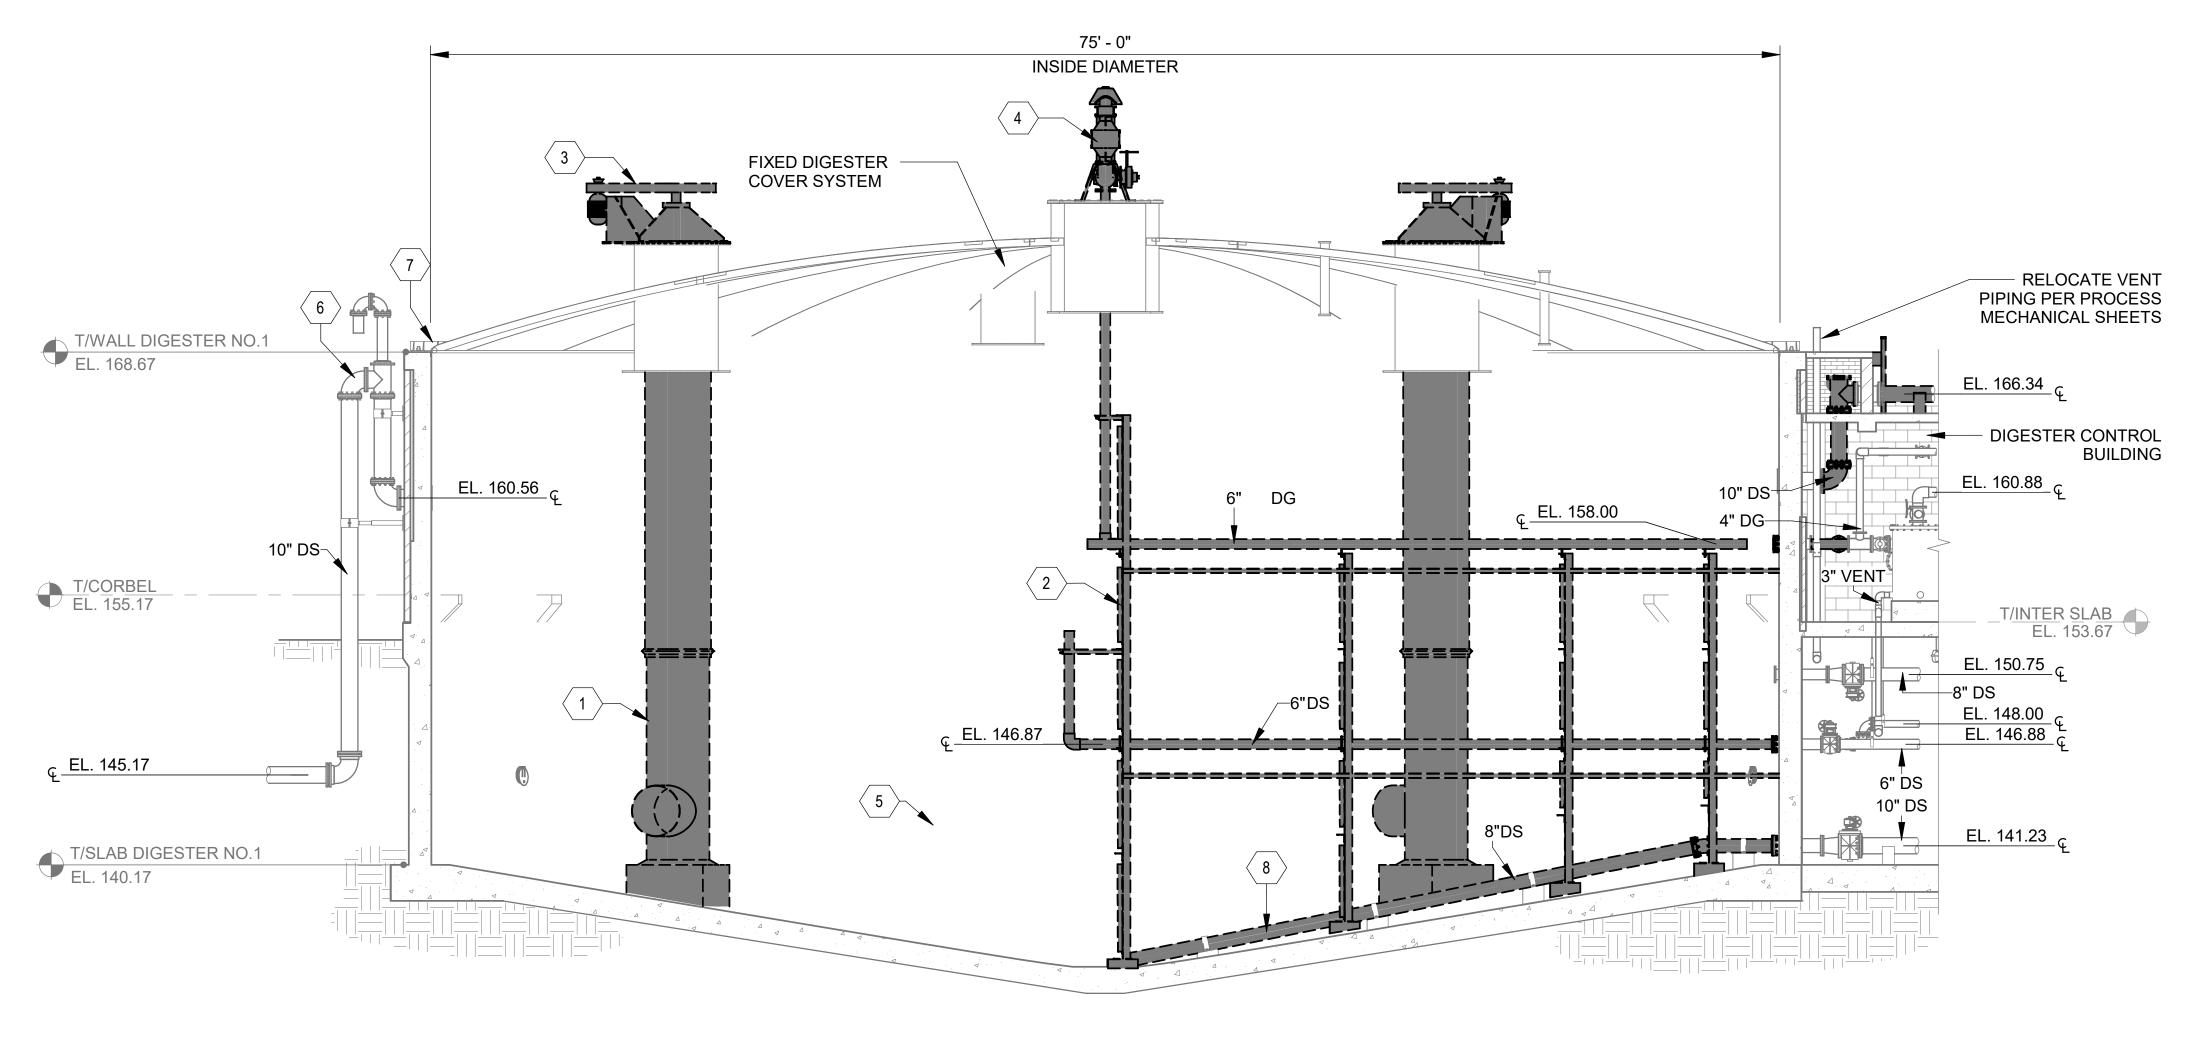
11-X103 SHEET **025**

ANAEROBIC DIGESTER NO. 1 LOWER DEMOLITION PLAN

SCALE: 3/16" = 1'-0"

PROJECT NORTH

NOTES:



KEYNOTES:

DENOTED BY SYMBOL (X)

1 DEMOLISH ALL EXISTING INTERIOR DIGESTER MIXING EQUIPMENT, TUBE SECTIONS, AND CONCRETE MIXER SUPPORTS. DRILL OUT EXPOSED REINFORCEMENT AS NEEDED AND PATCH SURFACE OF DIGESTER SLAB.

DEMOLISH AND REMOVE EXISTING DIGESTER RECIRCULATION PIPING AND SUPPORT STRUCTURE EXISTING PIPING TO BE DEMO'D UP TO THE FIRST FLANGE FROM THE WALL. DRILL OUT EXPOSED REINFORCEMENT AS NEEDED AND PATCH SURFACE OF DIGESTER SLAB.

REMOVE ALL EXISTING EXTERIOR DIGESTER MIXING EQUIPMENT. PROVIDE BOLT-ON COVER OVER COVER OPENING WITH APPROPRIATE GASKET SYSTEM FOR SEALING.

REMOVE FLAME ARRESTORS, PRESSURE/VACUUM RELIEF VALVES AND THREE WAY VALVE. REFER TO SPECIFICATION SECTION 44 10 00 FOR

CONTRACTOR TO JET AND CLEANOUT EXISTING OVERFLOW PIPING TO REMOVE ANY OBSTRUCTIONS OR BLOCKAGE. SANDBLAST AND RECOAT PIPING ACCORDING TO COATING SCHEDULE SPECIFIED IN SECTION 09 90 00.

DIGESTER CLEANOUT REQUIREMENTS.

CONTRACTOR TO INSPECT EXISTING SIDE SHEET CONNECTION INCLUDING ANNULAR SEAL AND RETAINER PLATE. SEE STRUCTURAL DRAWINGS FOR ADDITIONAL DETAILS FOR REPLACEMENT.

CONTRACTOR TO REMOVE AND REPLACE EXISTING DIGESTED SLUDGE TRANSFER PIPING AND PIPE SUPPORT HARDWARE. EXISTING PIPE SUPPORTS TO REMAIN. PIPING TO BE DEMO'D UP TO THE FIRST FLANGE FROM THE WALL.

DEMOLITION LEGEND

TO BE DEMOLISHED



1. INTERIOR TANK DETAILS HAVE BEEN PROVIDED BASED ON AVAILABLE RECORD DRAWINGS. DIMENSIONS HAVE NOT BEEN VERIFIED FOR ACCURACY.

CONTRACTOR IS RESPONSIBLE FOR FIELD VERIFYING ALL EXISTING CONDITIONS INCLUDING LOCATION AND DIMENSIONS OF ALL EXISTING STRUCTURES, EQUIPMENT, AND UTILITIES. CONTRACTOR SHALL NOTIFY ENGINEER IF THERE IS A CONFLICT BETWEEN THE CONTRACT DOCUMENTS AND EXISTING CONDITIONS BEFORE PROCEEDING WITH WORK.

11-X102 11-X301

SCALE: 3/16" = 1'-0"

ANAEROBIC DIGESTER NO. 1 DEMOLITION SECTION

ANAEROBIC DIGESTER

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NO. 1 DEMOLITION SECTION


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11-X301

SHEET 026



2. AS PART OF FILLING THE DIGESTER WITH WATER TO COMPLETE

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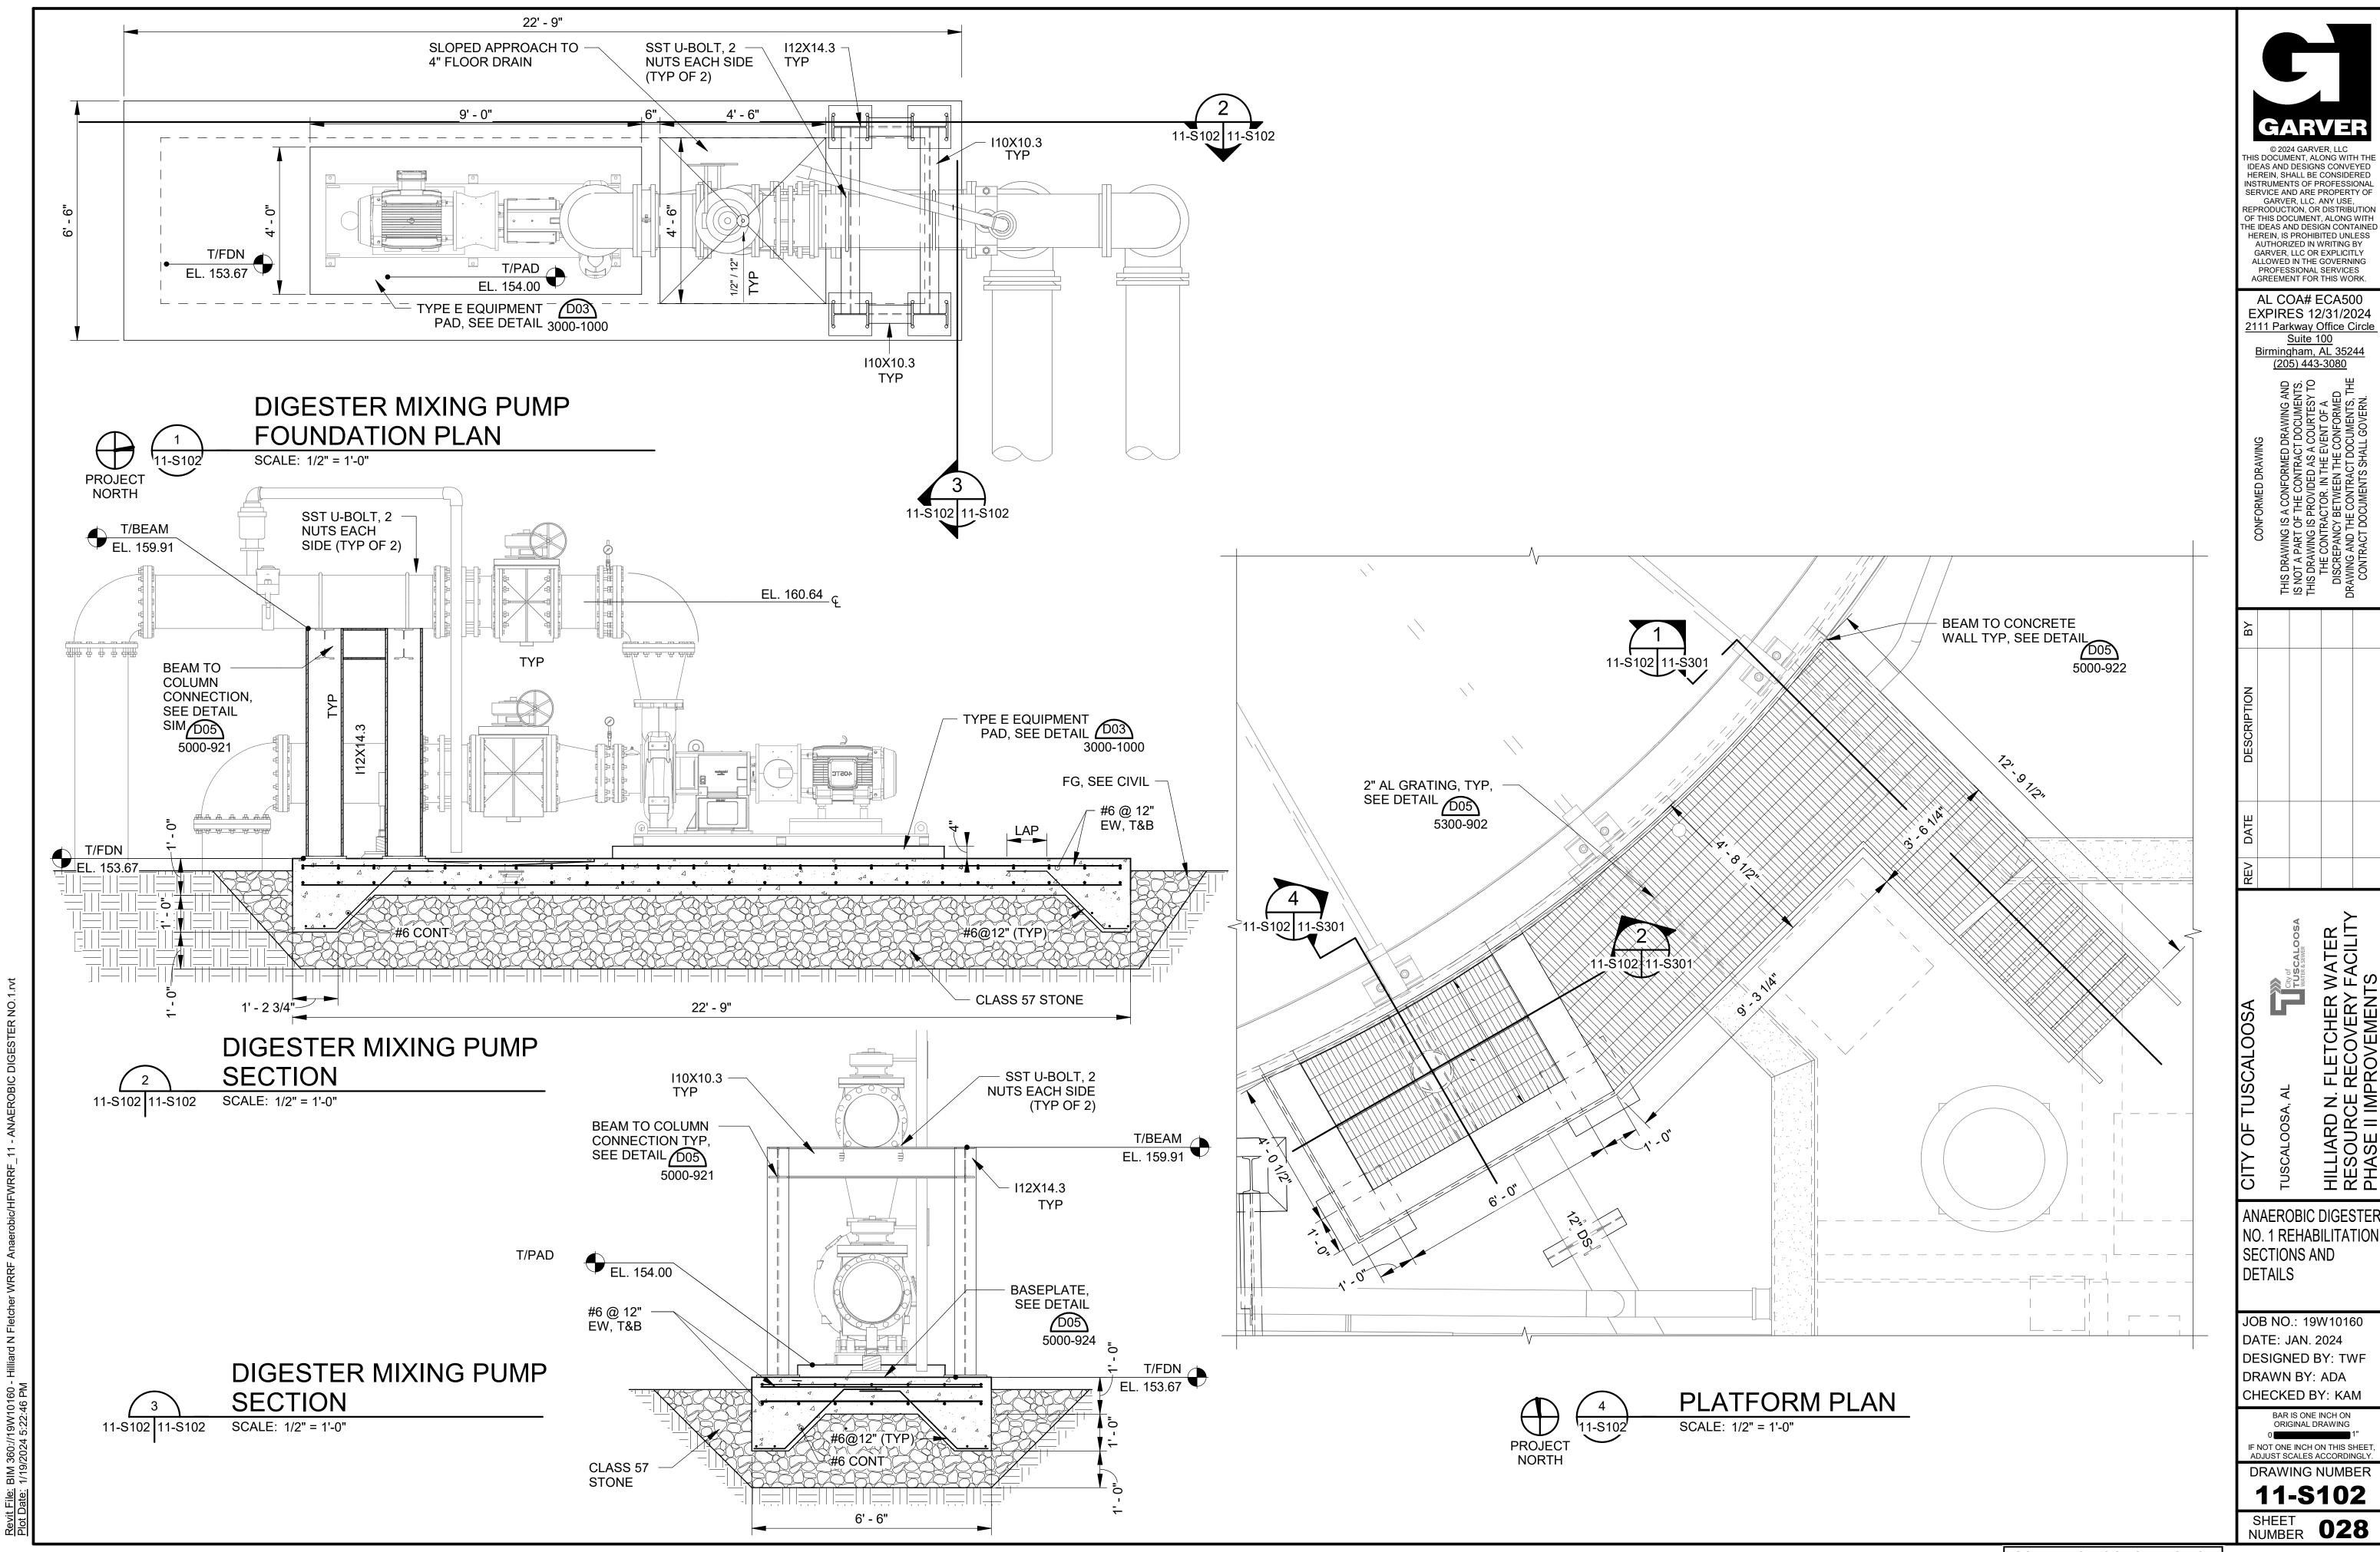
ANAEROBIC DIGESTER NO. 1 REHABILITATION

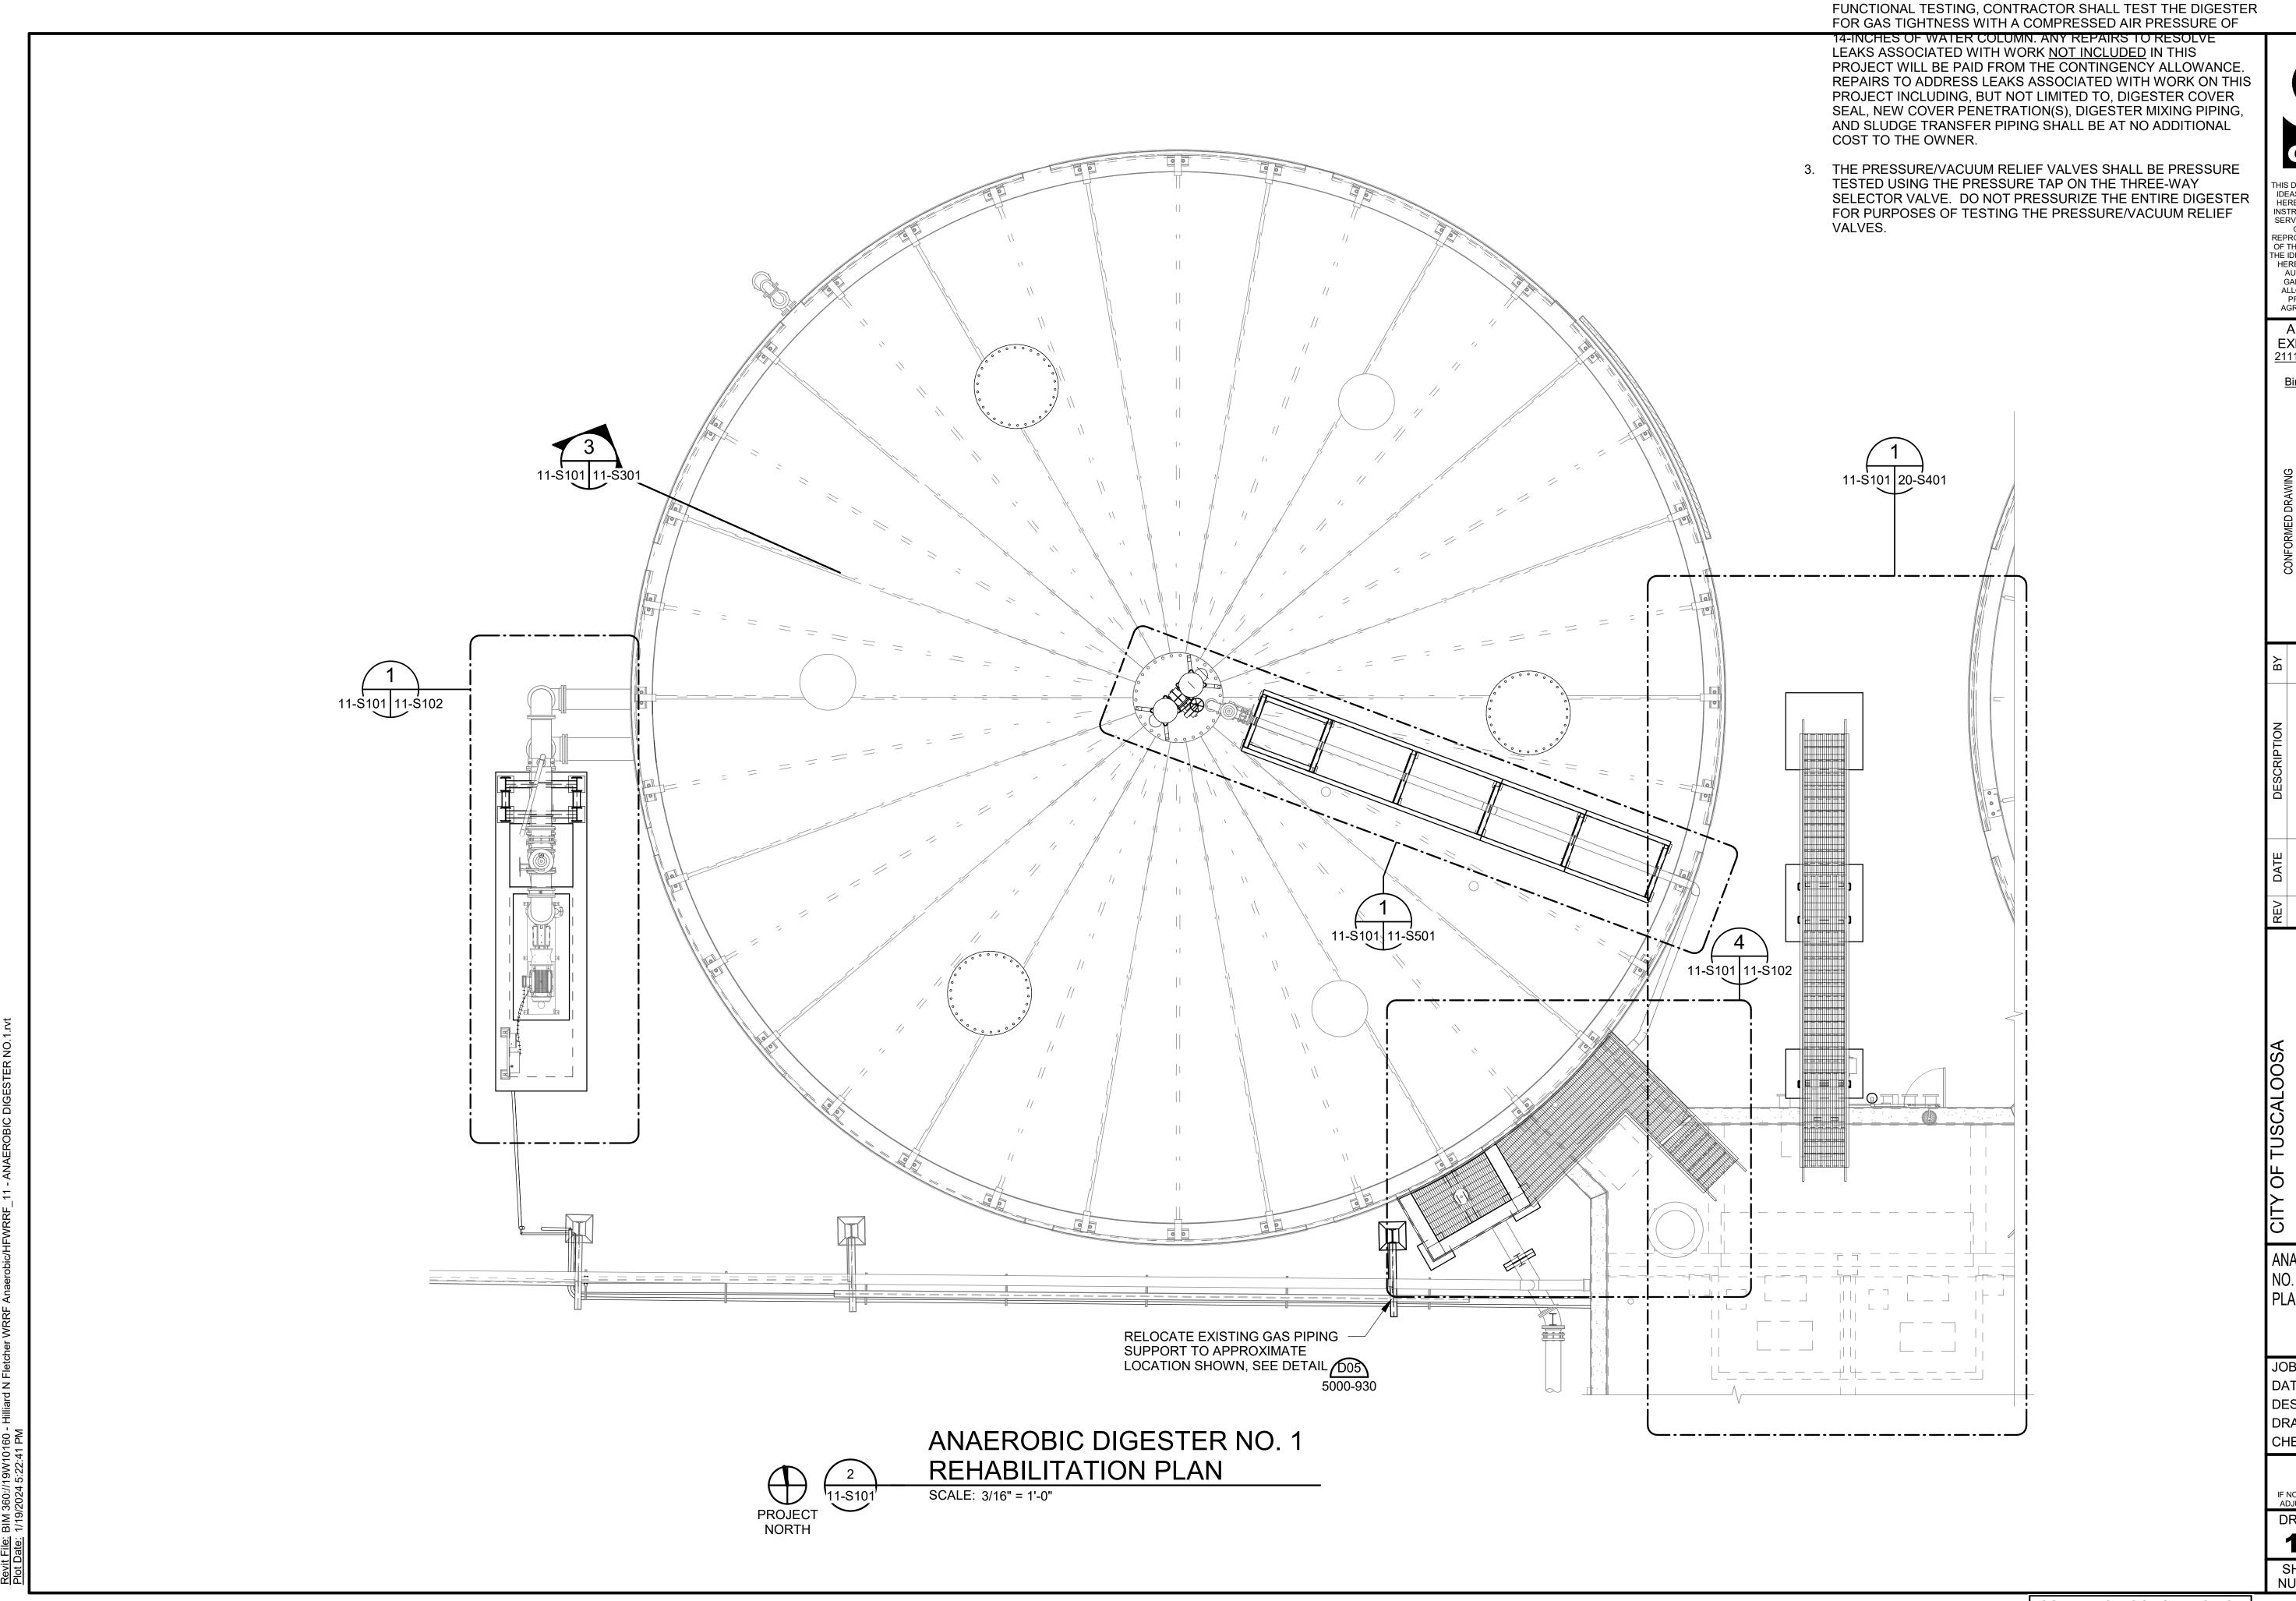
JOB NO.: 19W10160 DATE: JAN. 2024 DESIGNED BY: KAU DRAWN BY: EGB CHECKED BY: KAM


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11-\$101 SHEET **027**







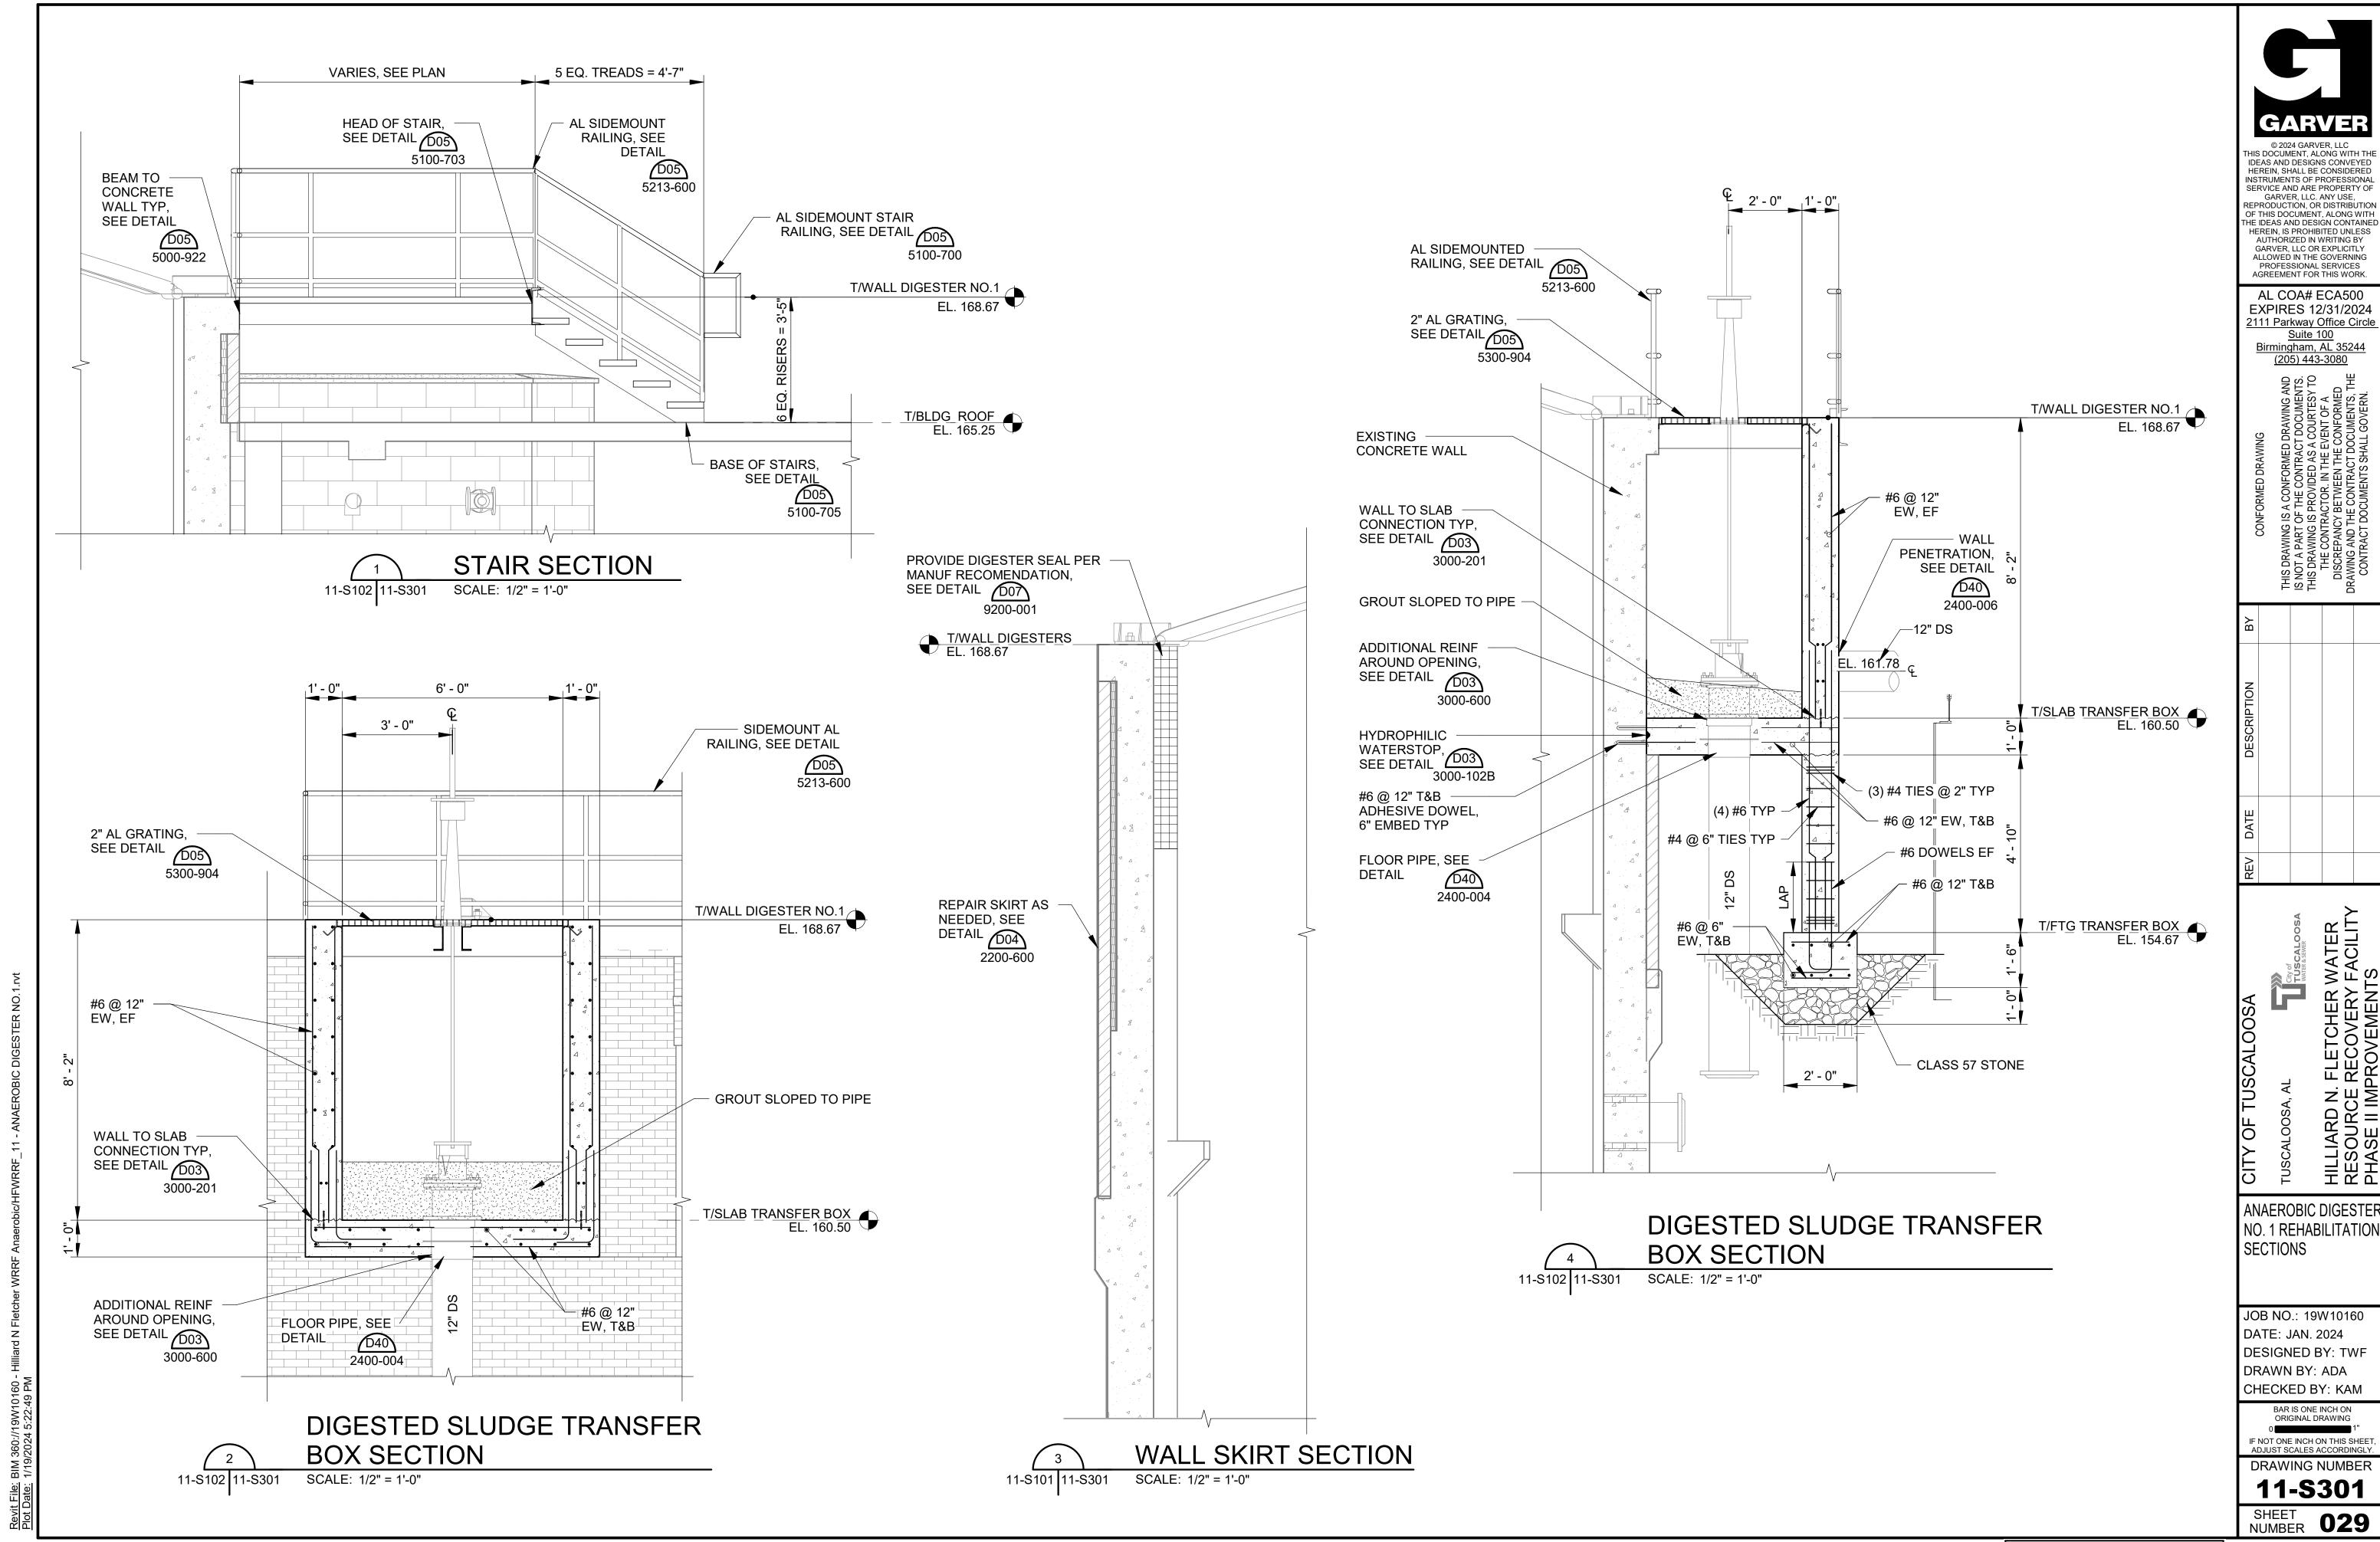
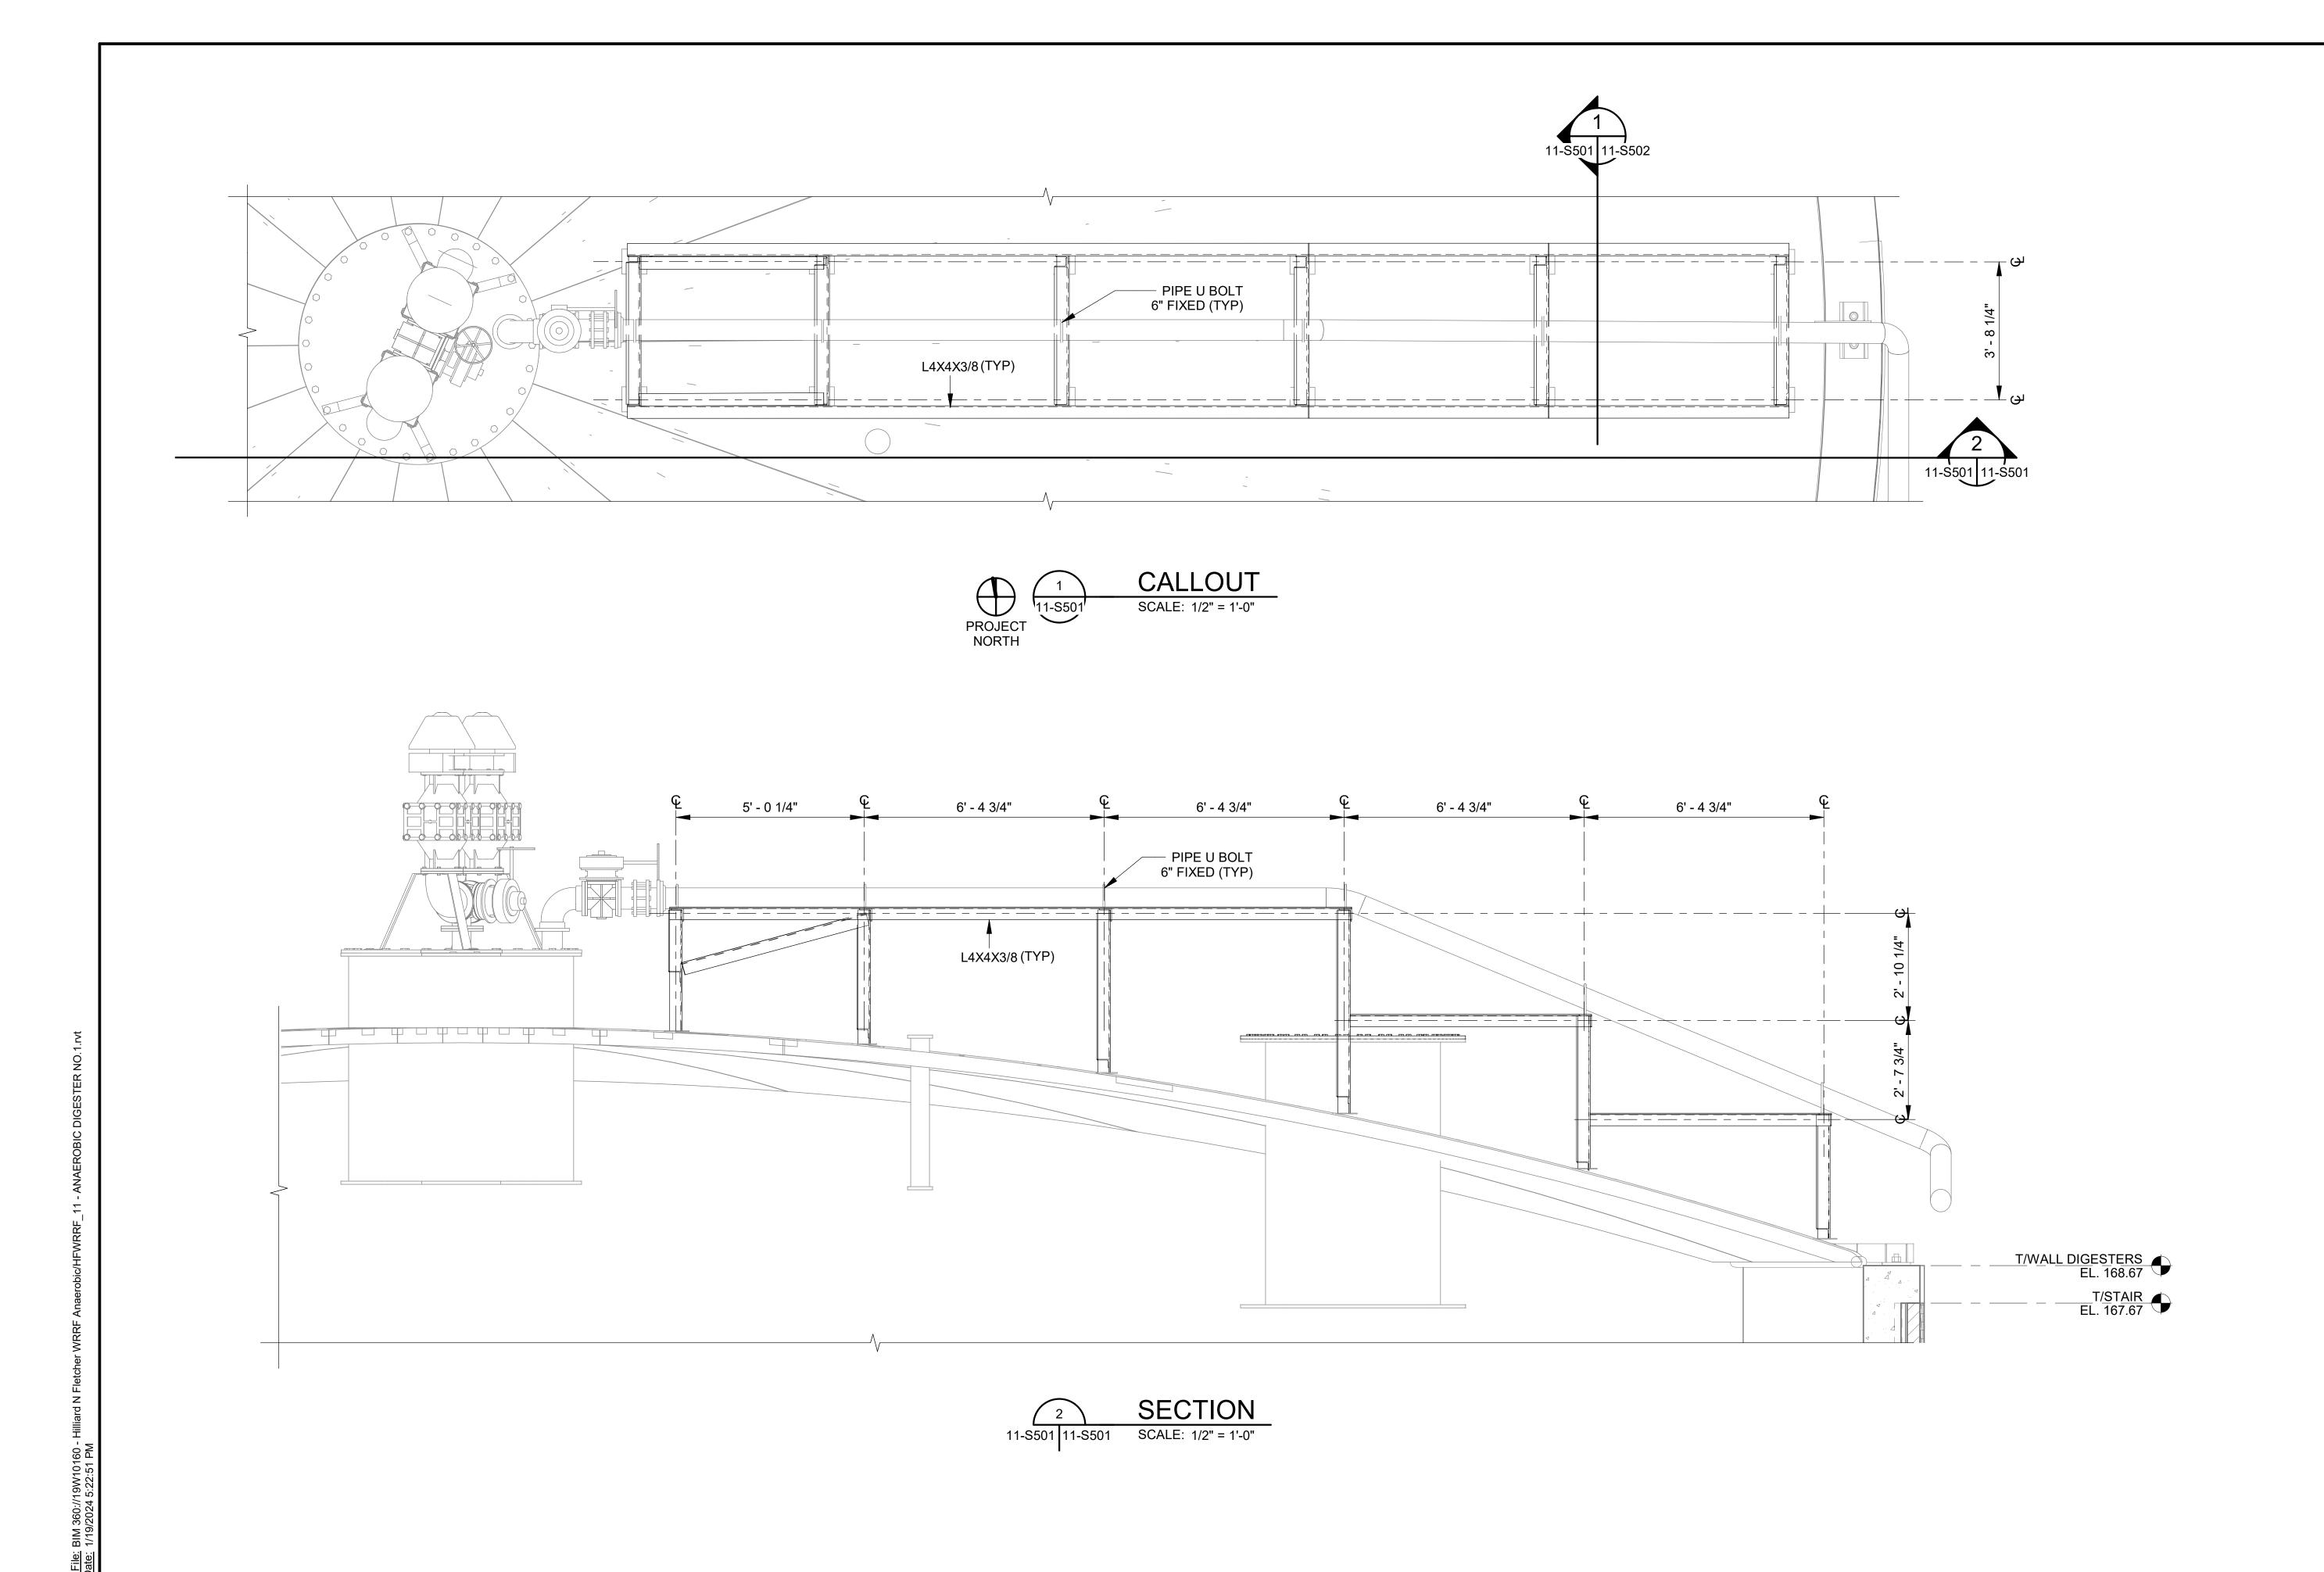
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REV DATE DESCRIPTION BY

CALOOSA, AL TUSCALO LIARD N. FLETCHER WATE SOURCE RECOVERY FACIL

ANAEROBIC DIGESTER PIPE SUPPORT NO. 1 REHABILITATION DETAIL AND SECTION

JOB NO.: 19W10160 DATE: JAN. 2024 DESIGNED BY: TWF DRAWN BY: GBA CHECKED BY: KAM

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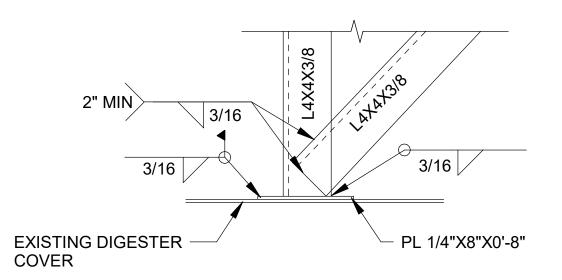
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DRAWING NUMBER

11-8501


SHEET NUMBER 030



NOTES:


- 1. THOROUGHLY CLEAN EXISTING DIGESTER COVER PRIOR TO WELDING
- 2. AFTER INSTALLATION, APPLY COLD GALVANIZING COMPOUND TO ANY WELDS OR DAMAGED AREAS



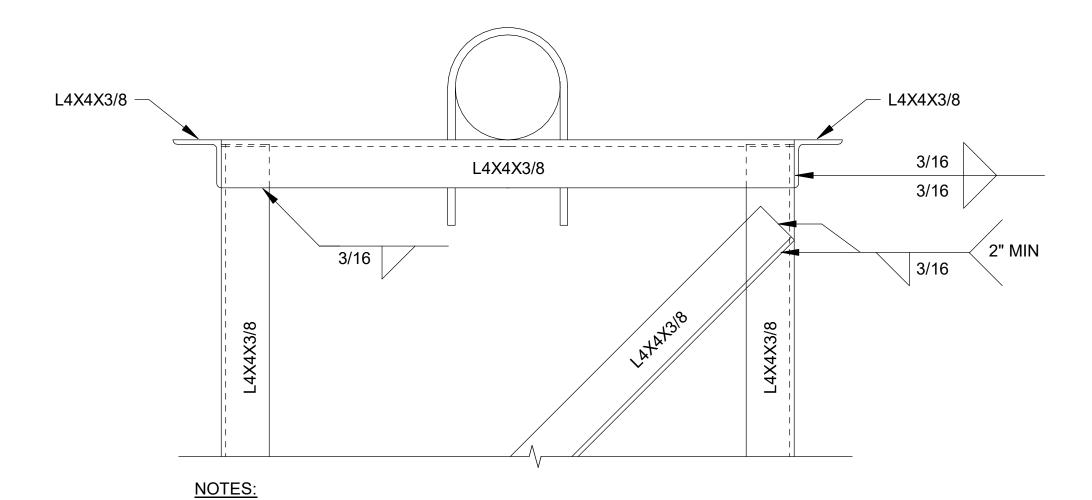

1. AFTER INSTALLATION, APPLY COLD GALVANIZING COMPOUND TO ANY WELDS OR DAMAGED AREAS



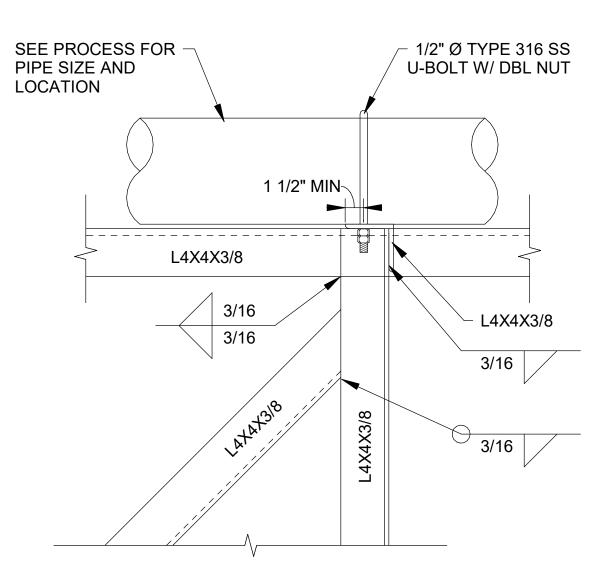

NOTES:

1. AFTER INSTALLATION, APPLY COLD GALVANIZING COMPOUND TO ANY WELDS OR DAMAGED AREAS





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ALOOSA

City of TUSCALOOSA
WATER & SEWER

TUSCALOOSA, AL

ANAEROBIC DIGESTER PIPE SUPPORT NO. 1 REHABILITATION DETAIL


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11-S502
SHEET NUMBER 031



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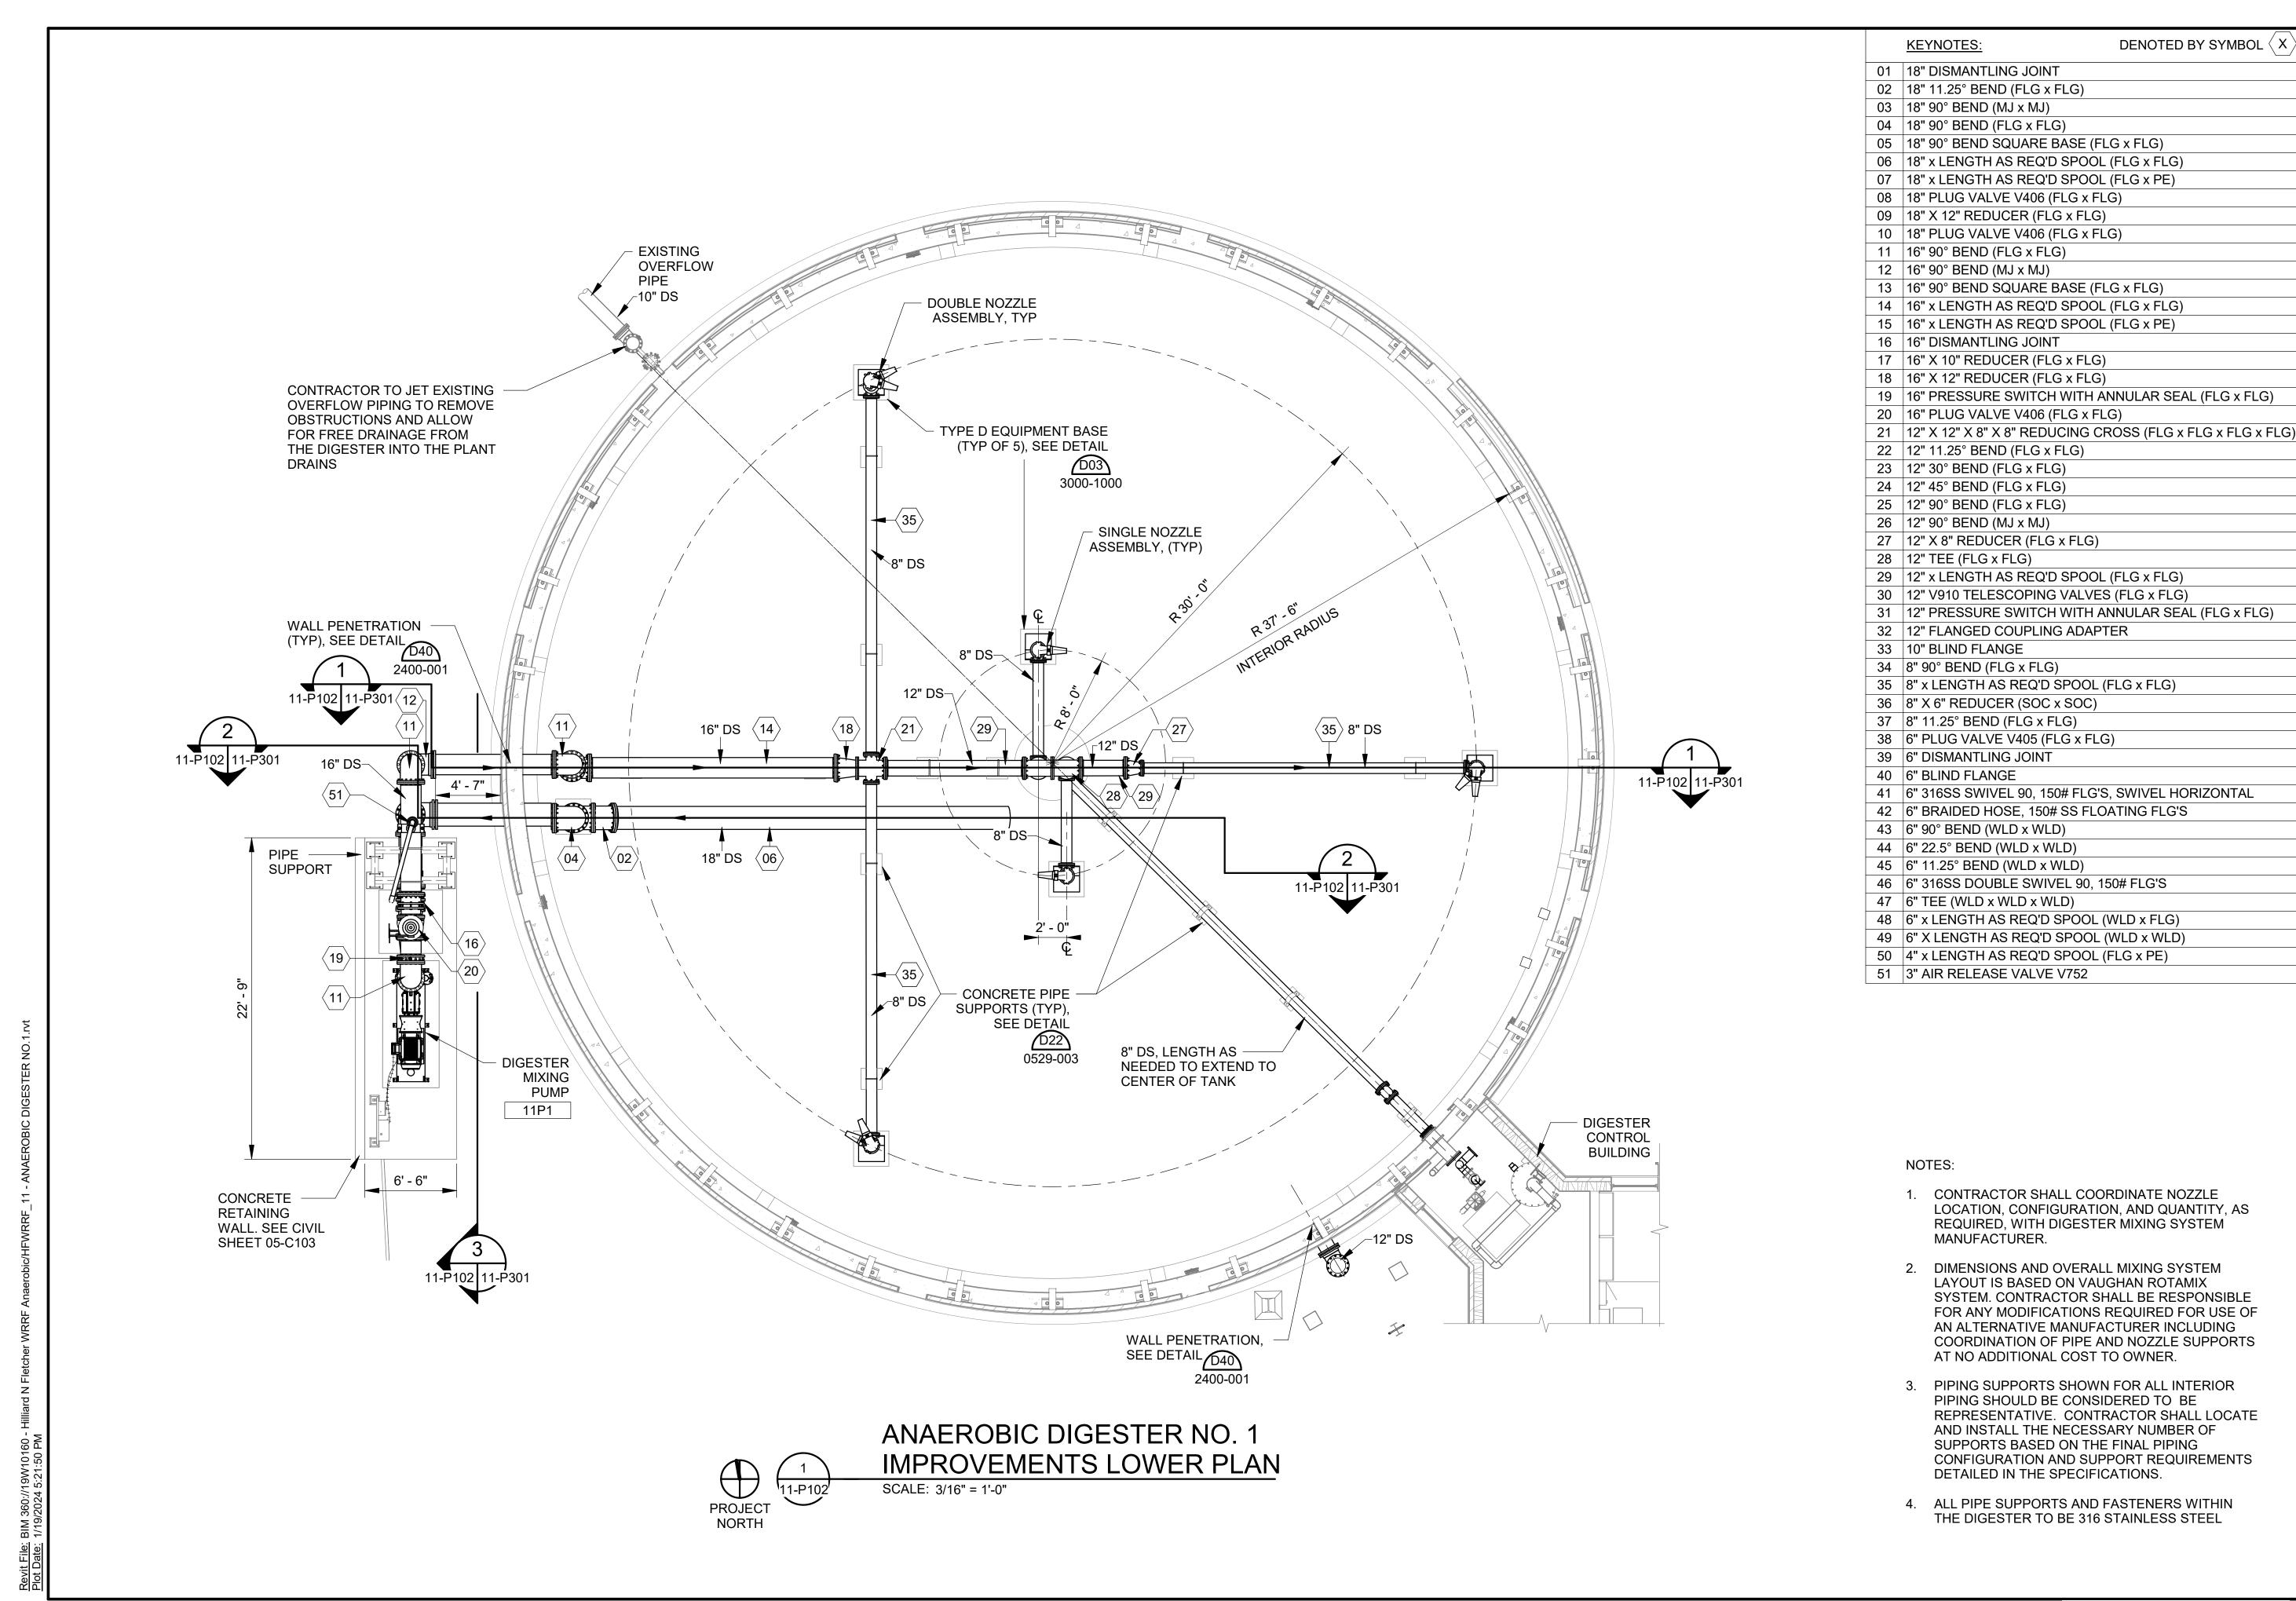
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OVERALL ANAEROBIC DIGESTION REHABILITATION PLAN

JOB NO.: 19W10160 DATE: JAN. 2024 DESIGNED BY: RWC DRAWN BY: WTL CHECKED BY: RDT

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ACILITY

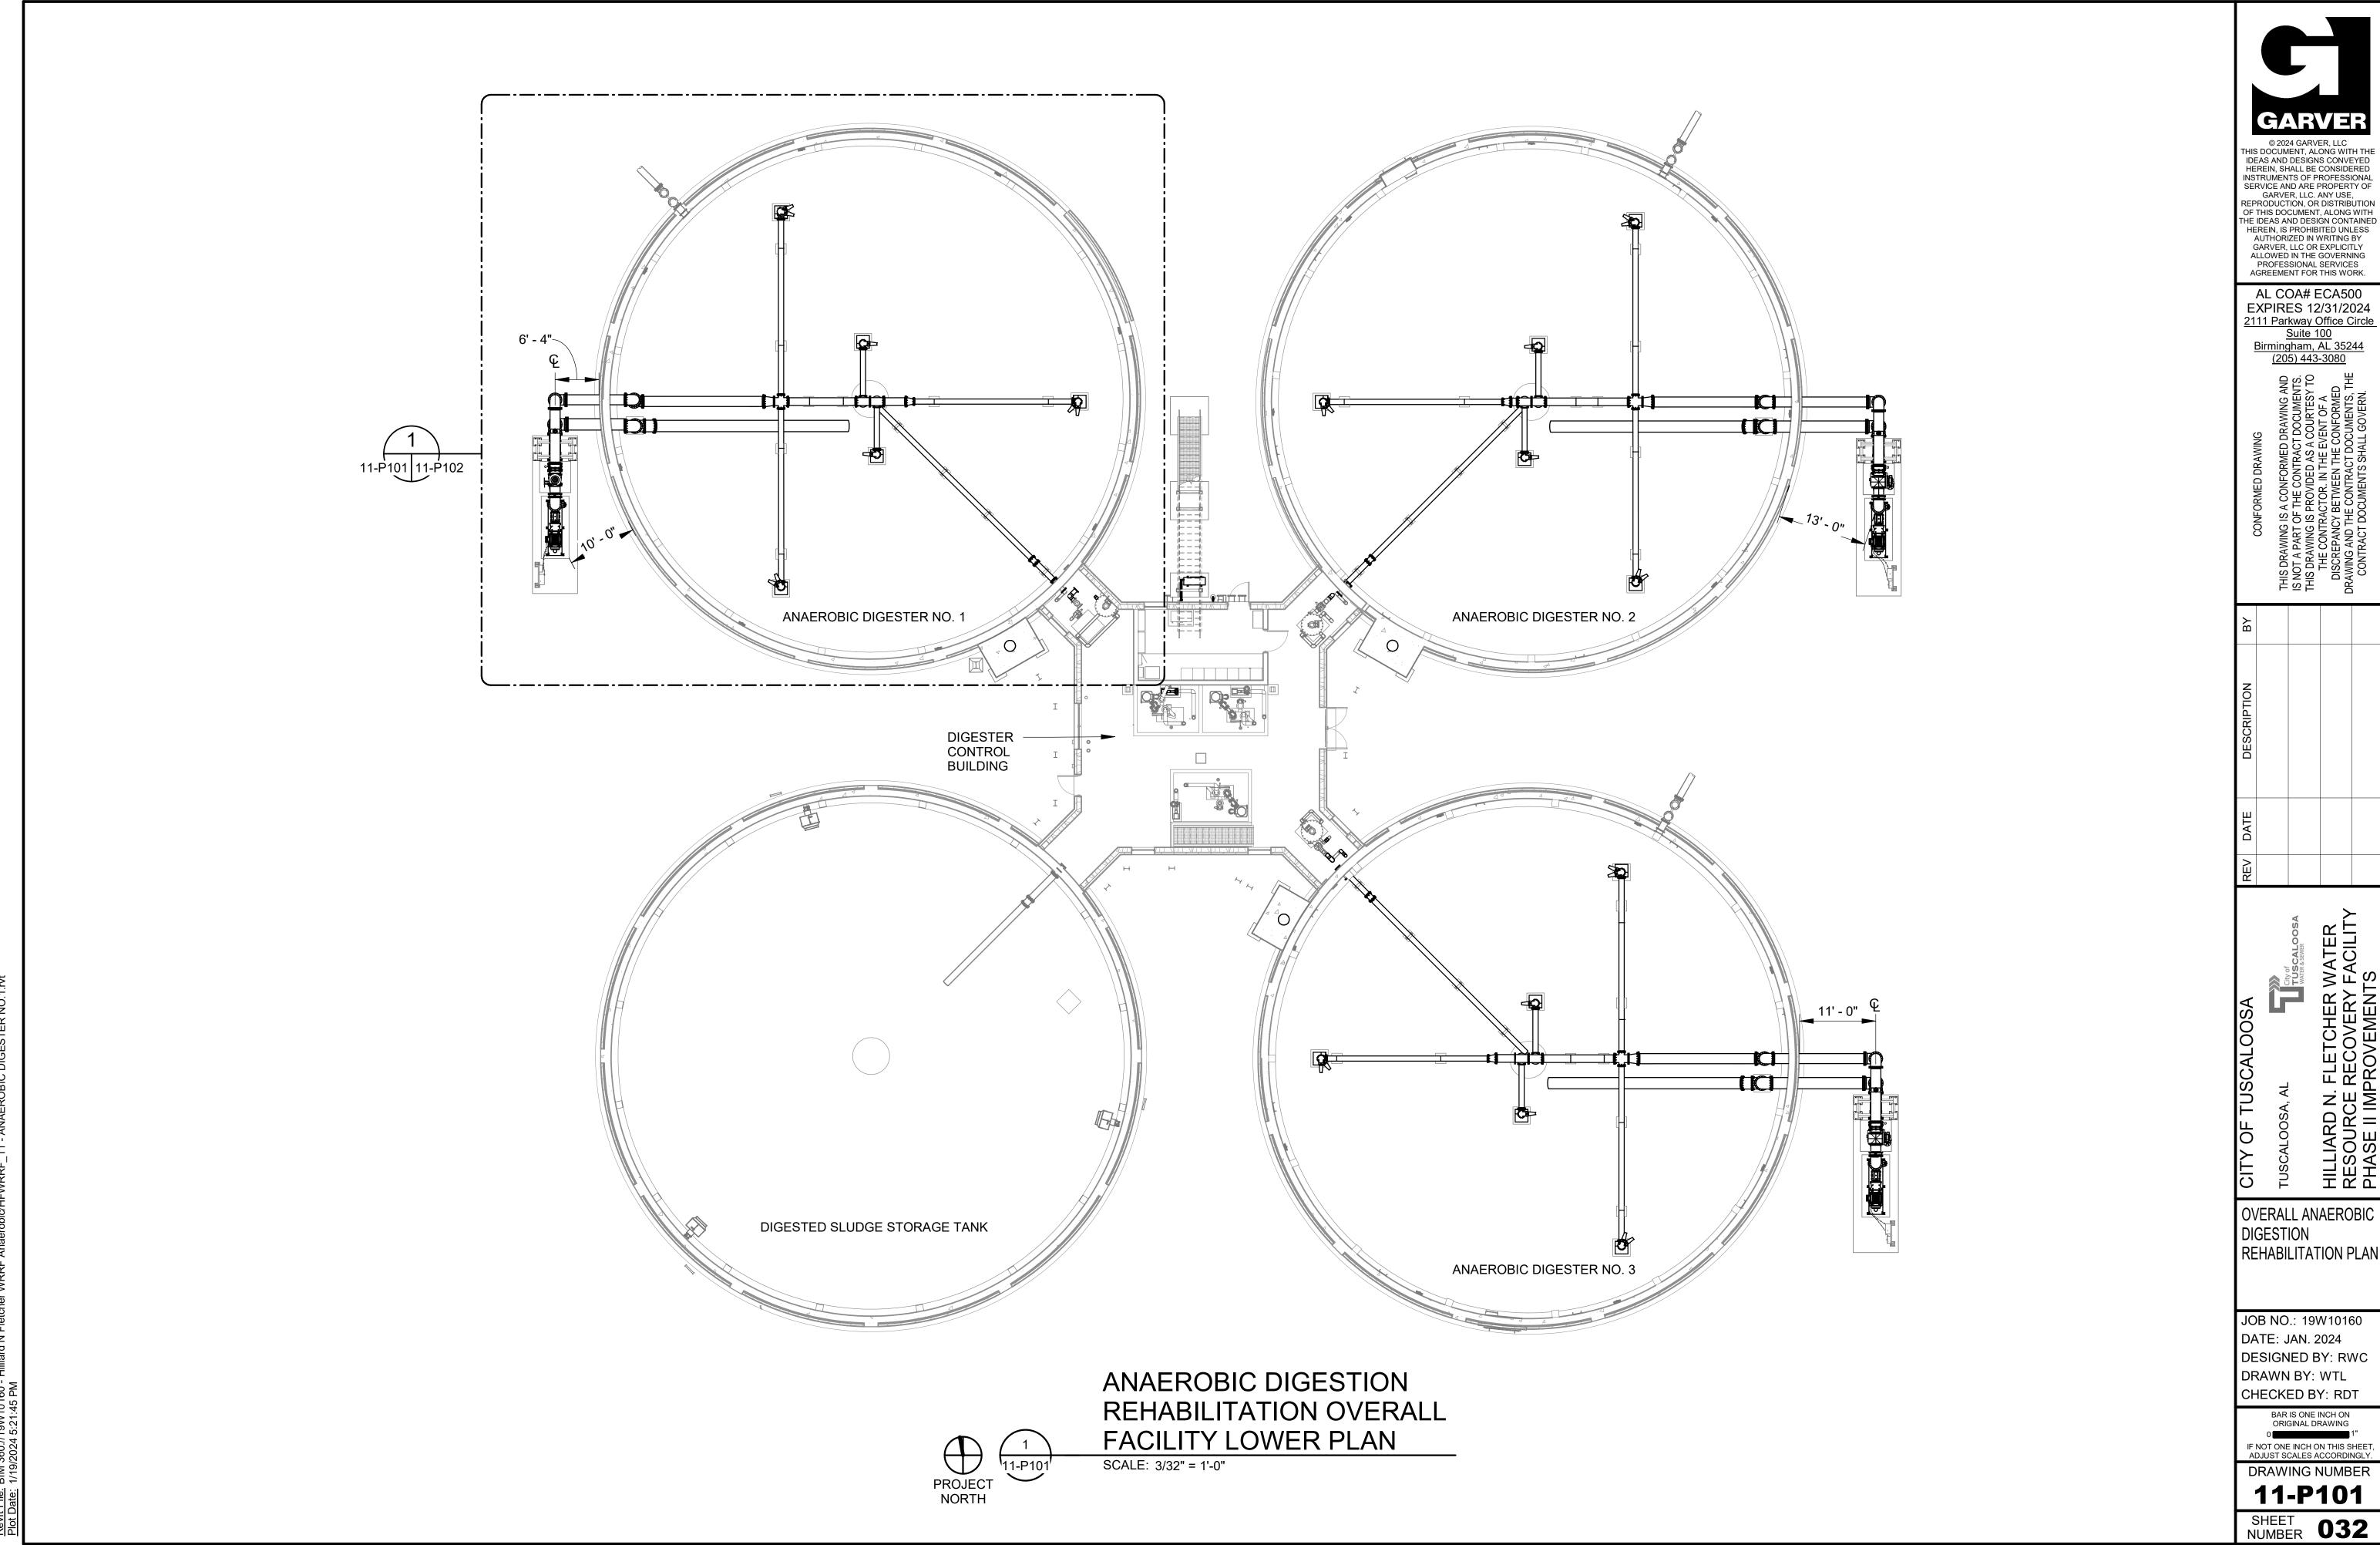JSCALOOSA, AL

ILLIARD N. FLETCHER WATE
ESOURCE RECOVERY FACIL
HASE II IMPROVEMENTS

ANAEROBIC DIGESTER NO. 1 IMPROVEMENTS LOWER PLAN


JOB NO.: 19W10160 DATE: JAN. 2024 DESIGNED BY: RWC DRAWN BY: WTL CHECKED BY: RDT


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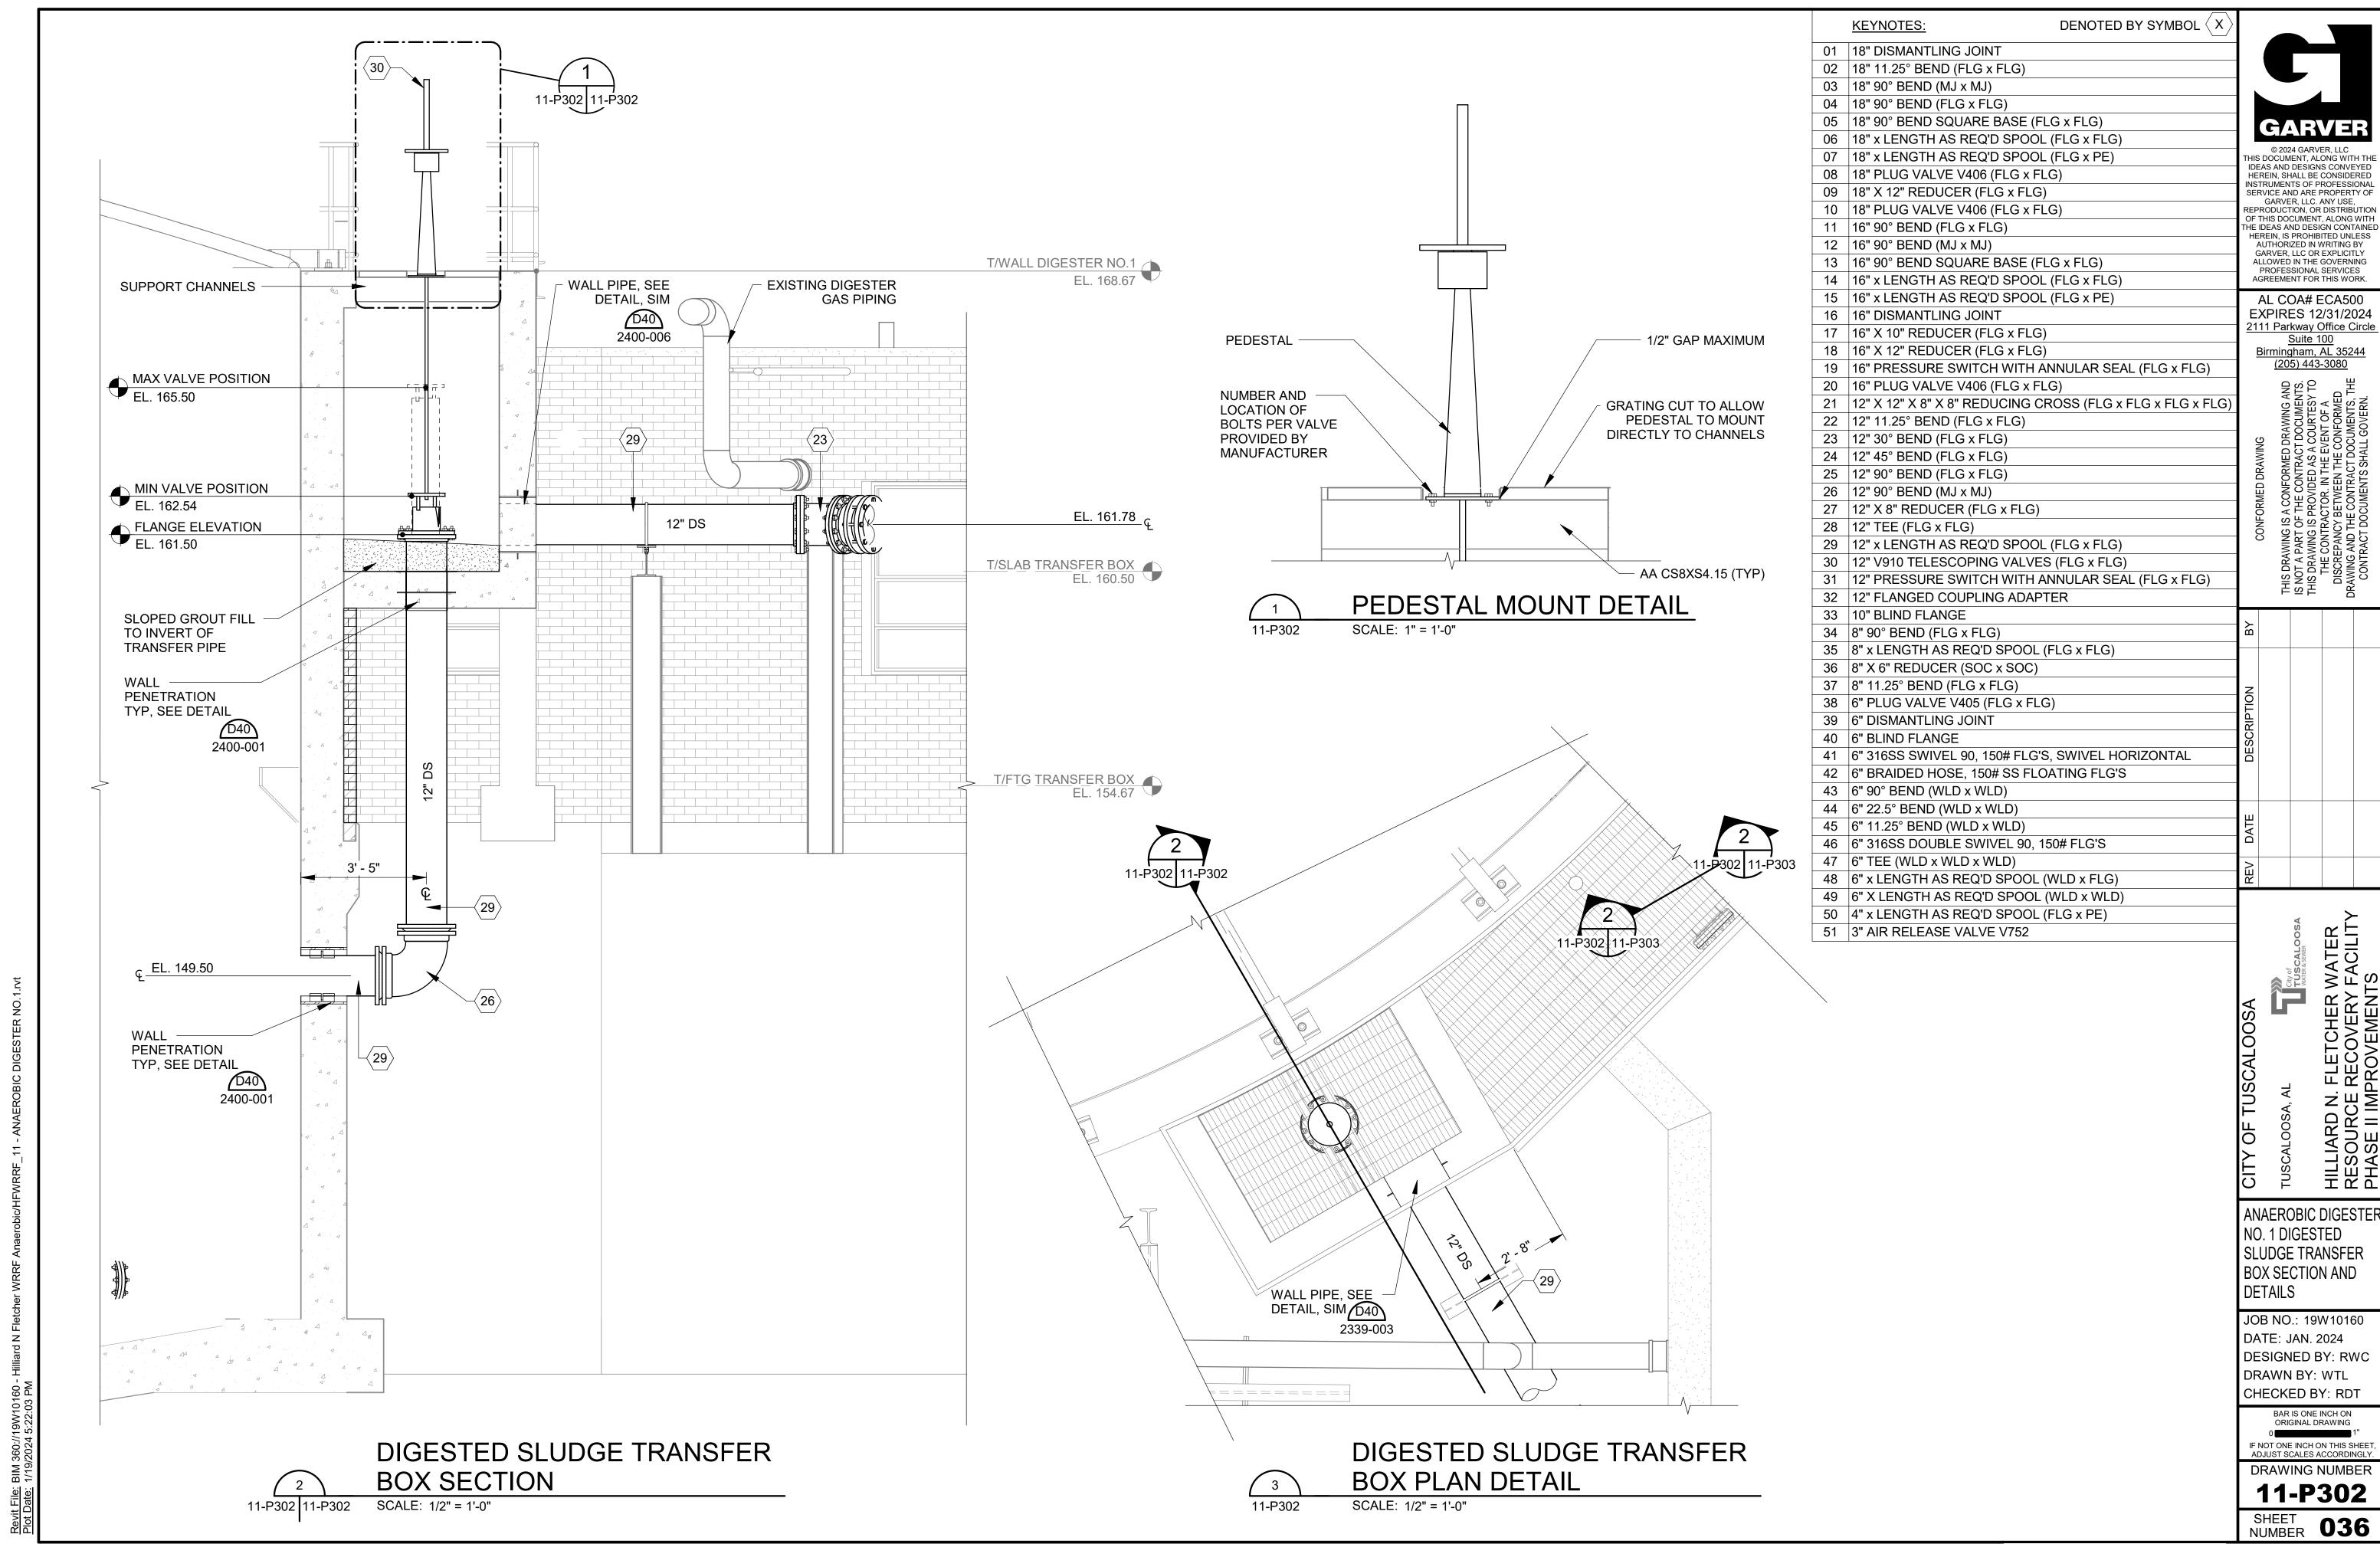
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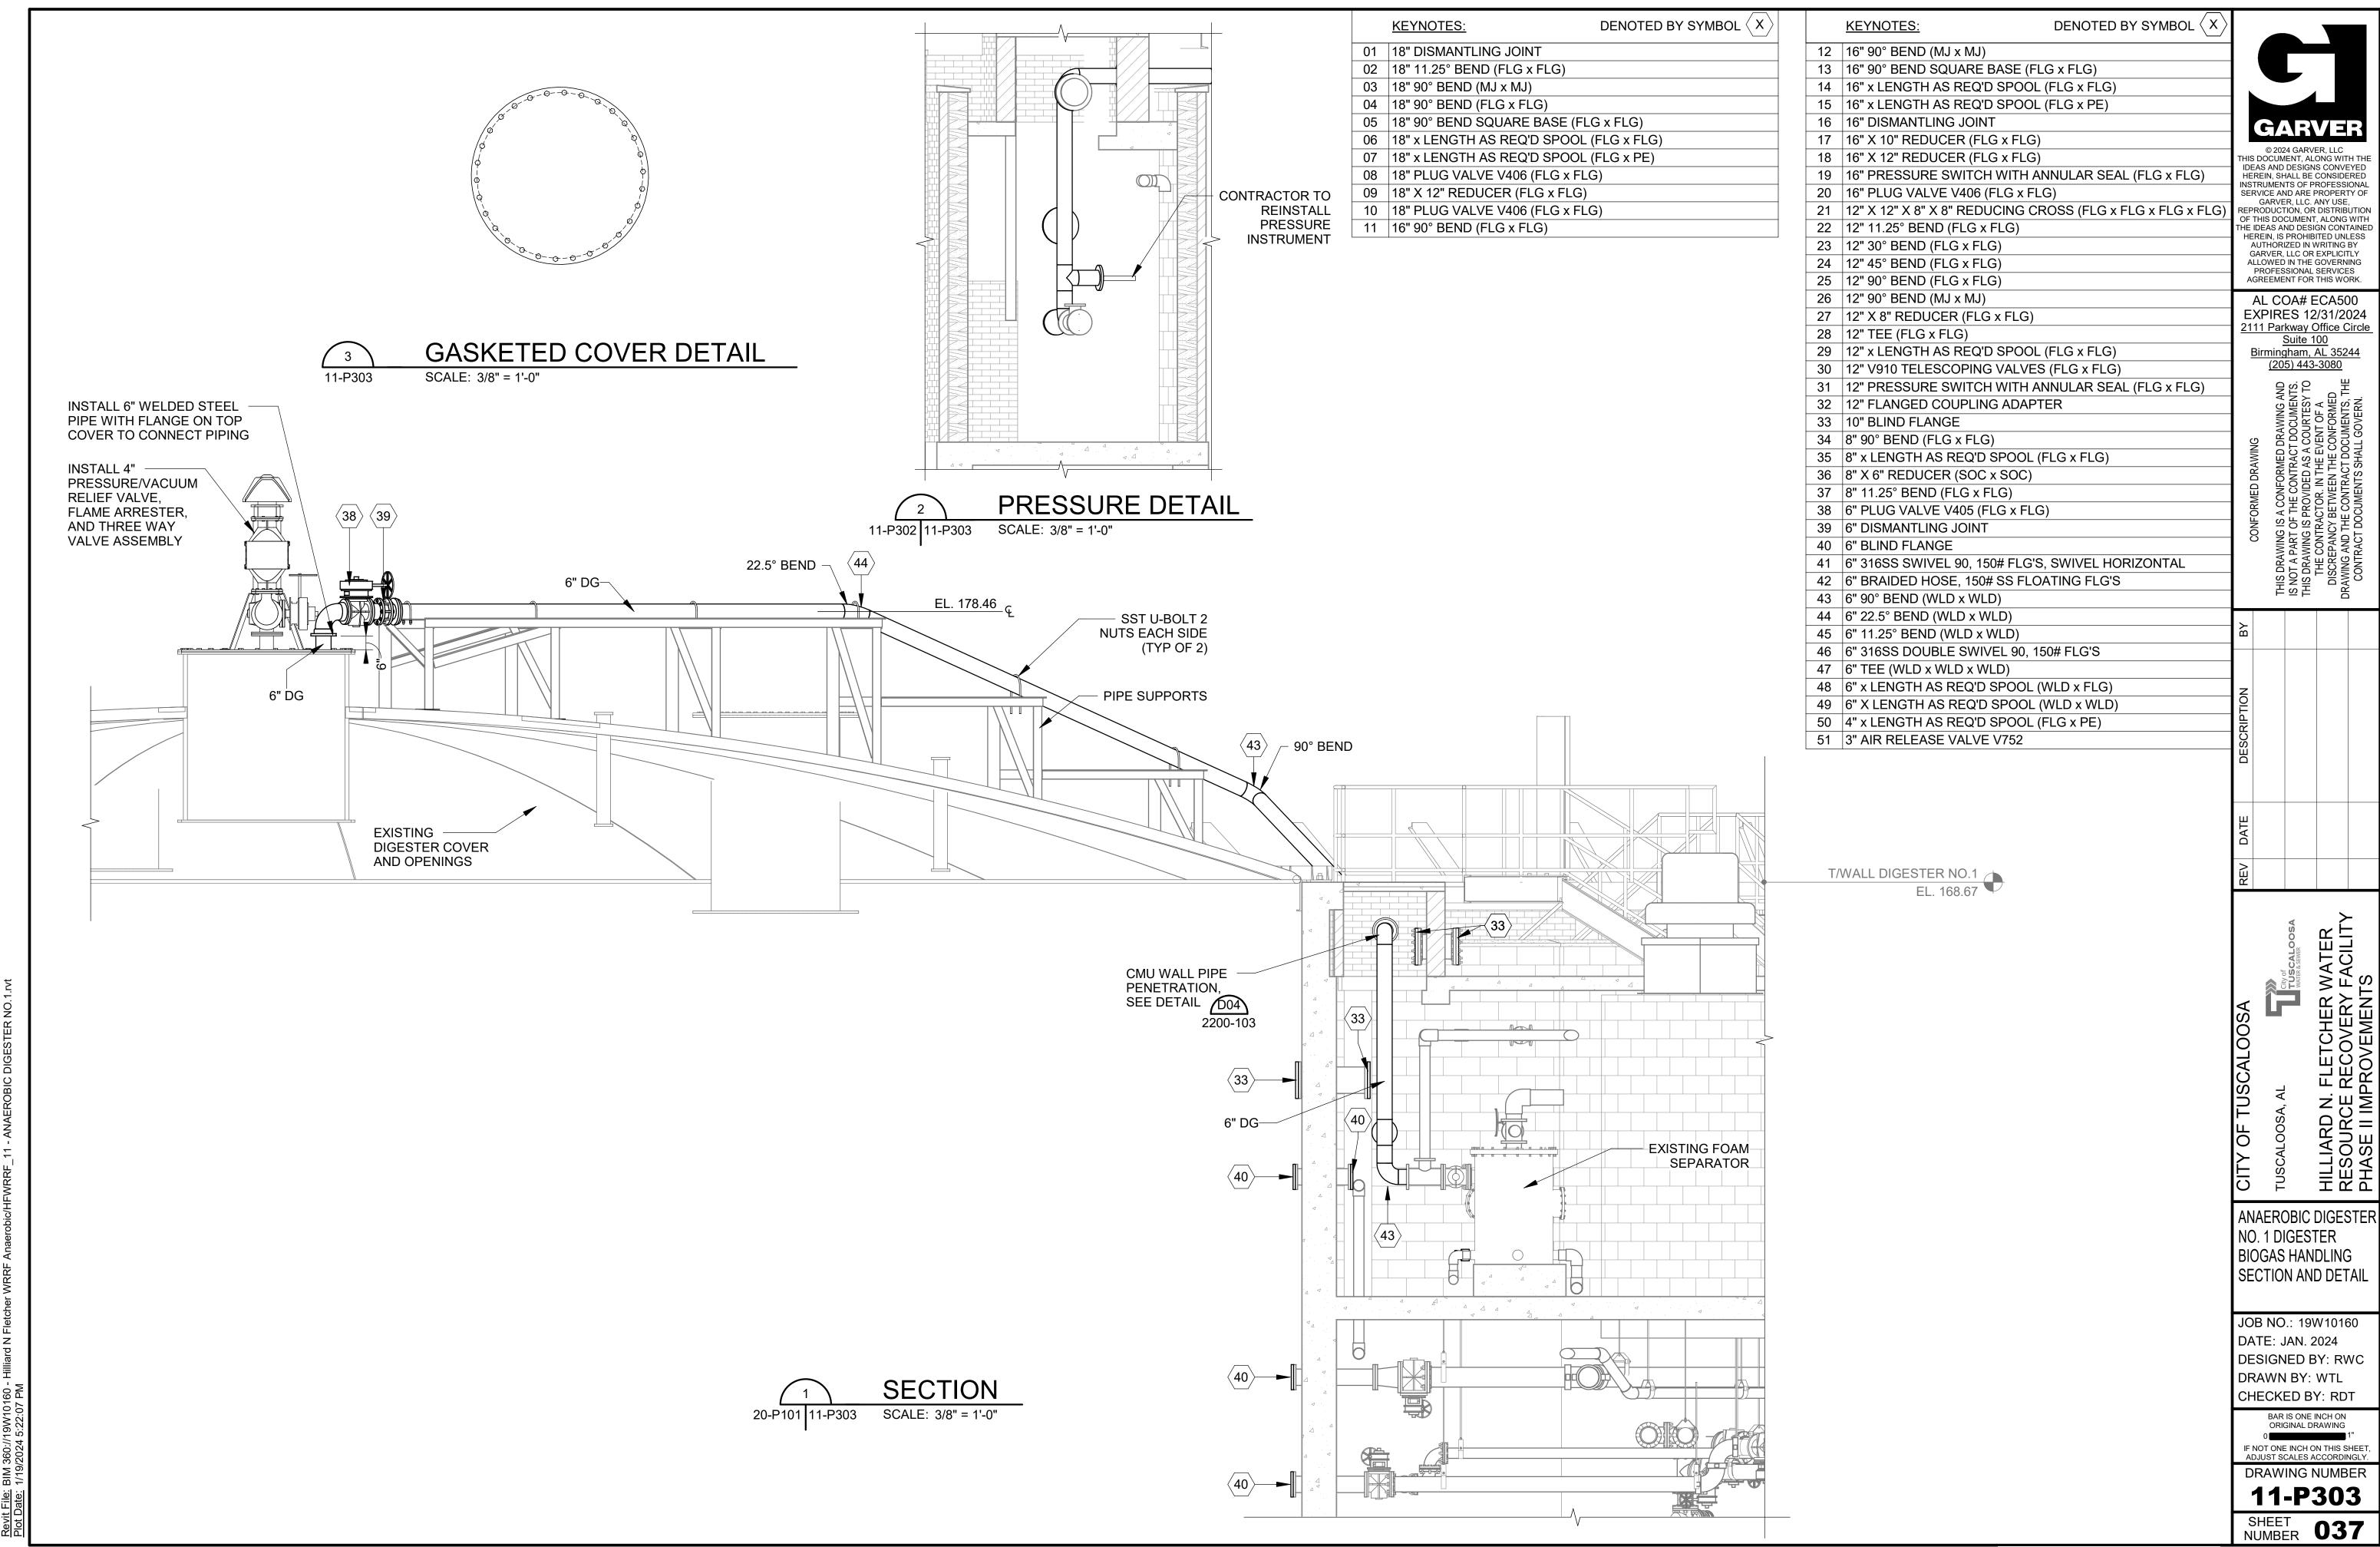
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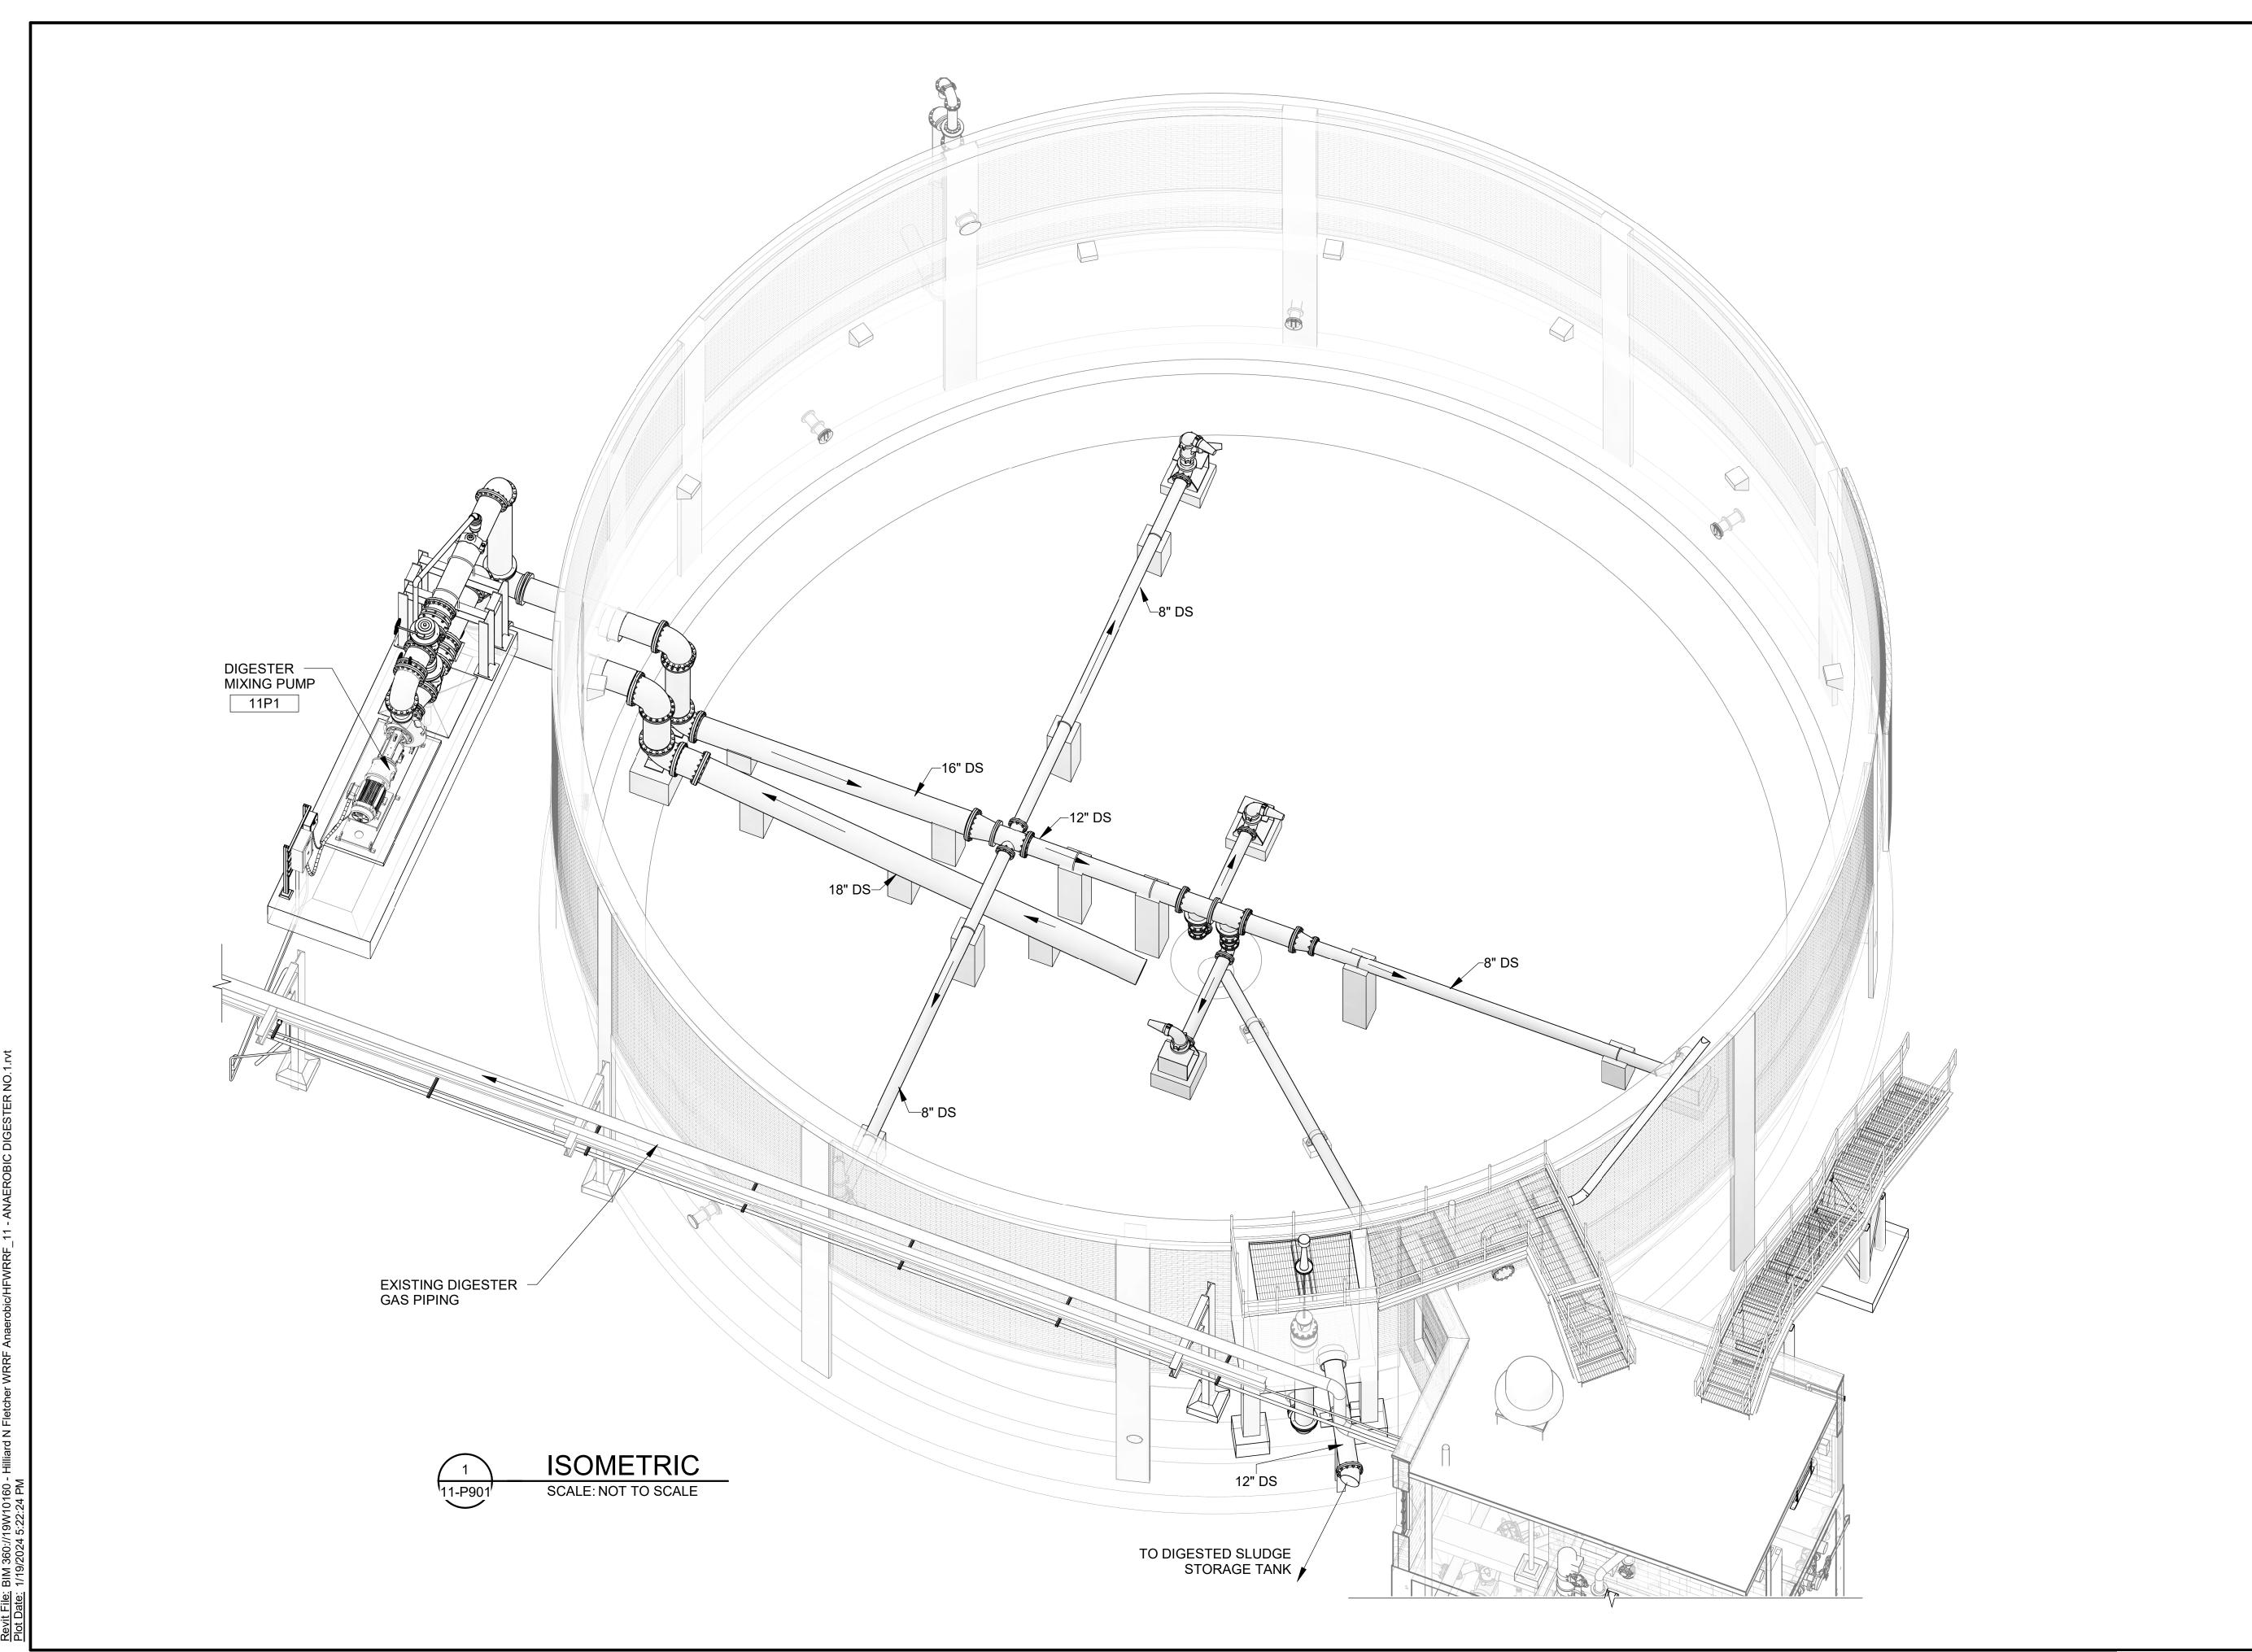
11-P102
SHEET 033







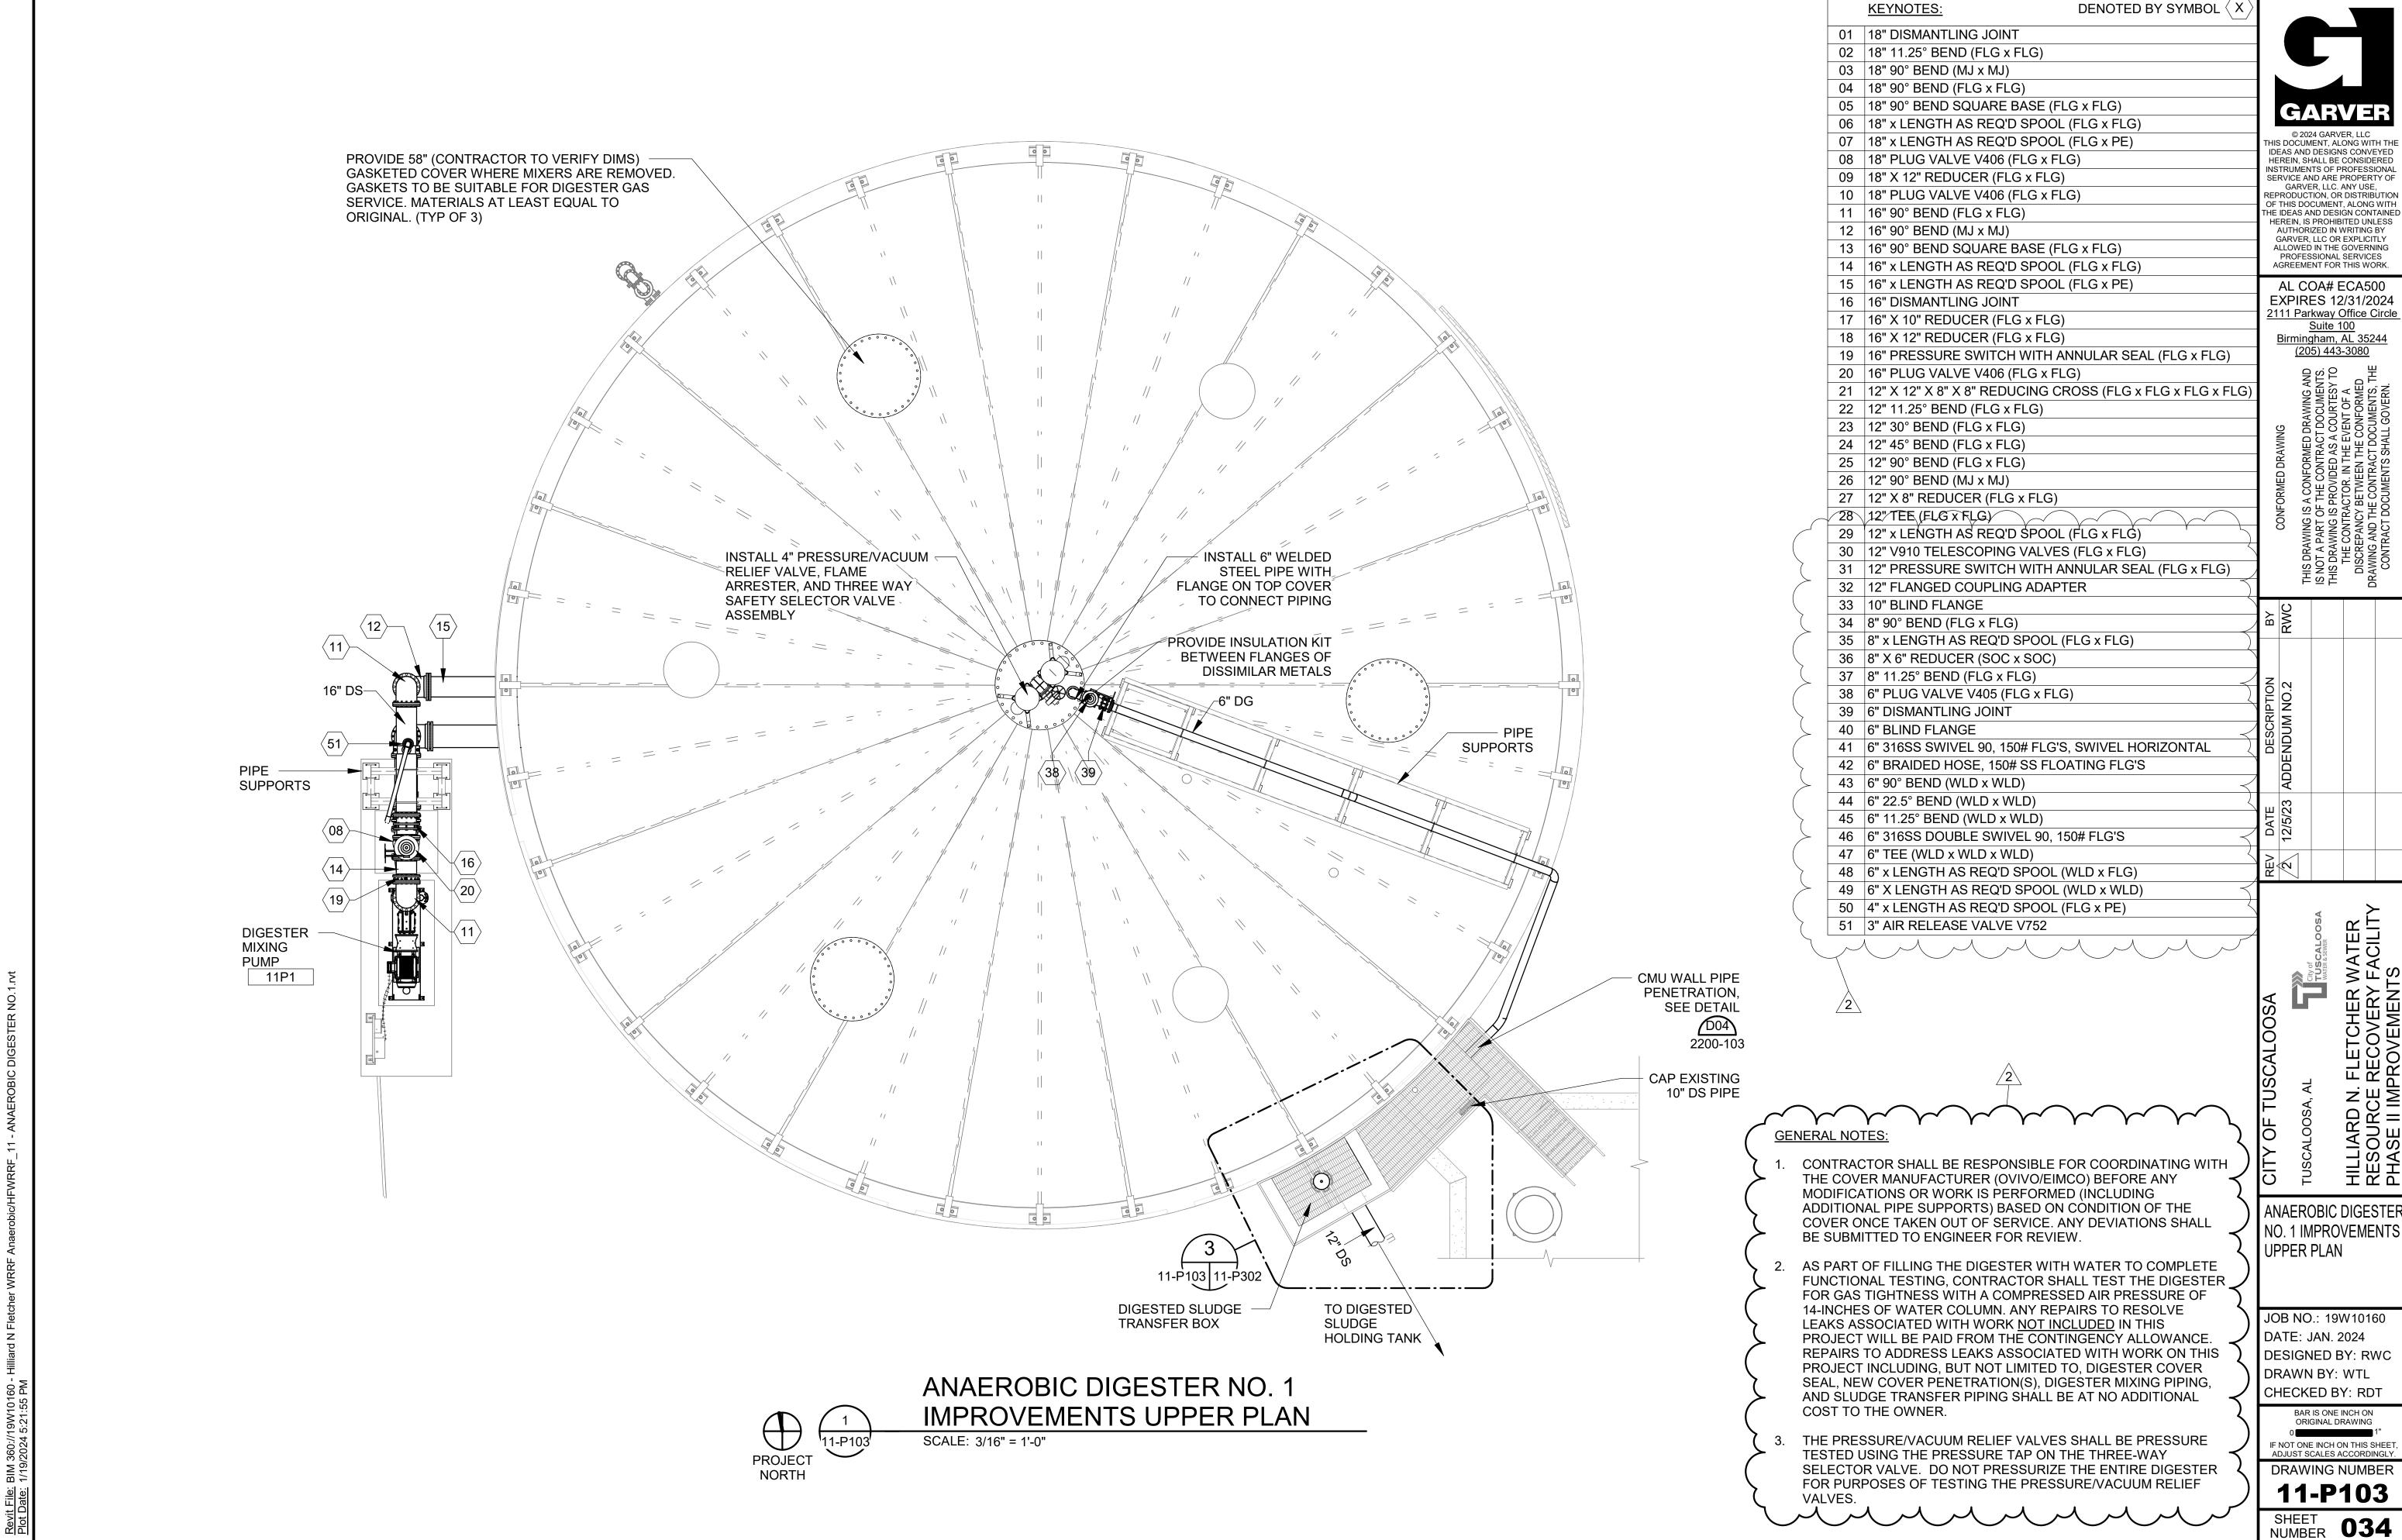

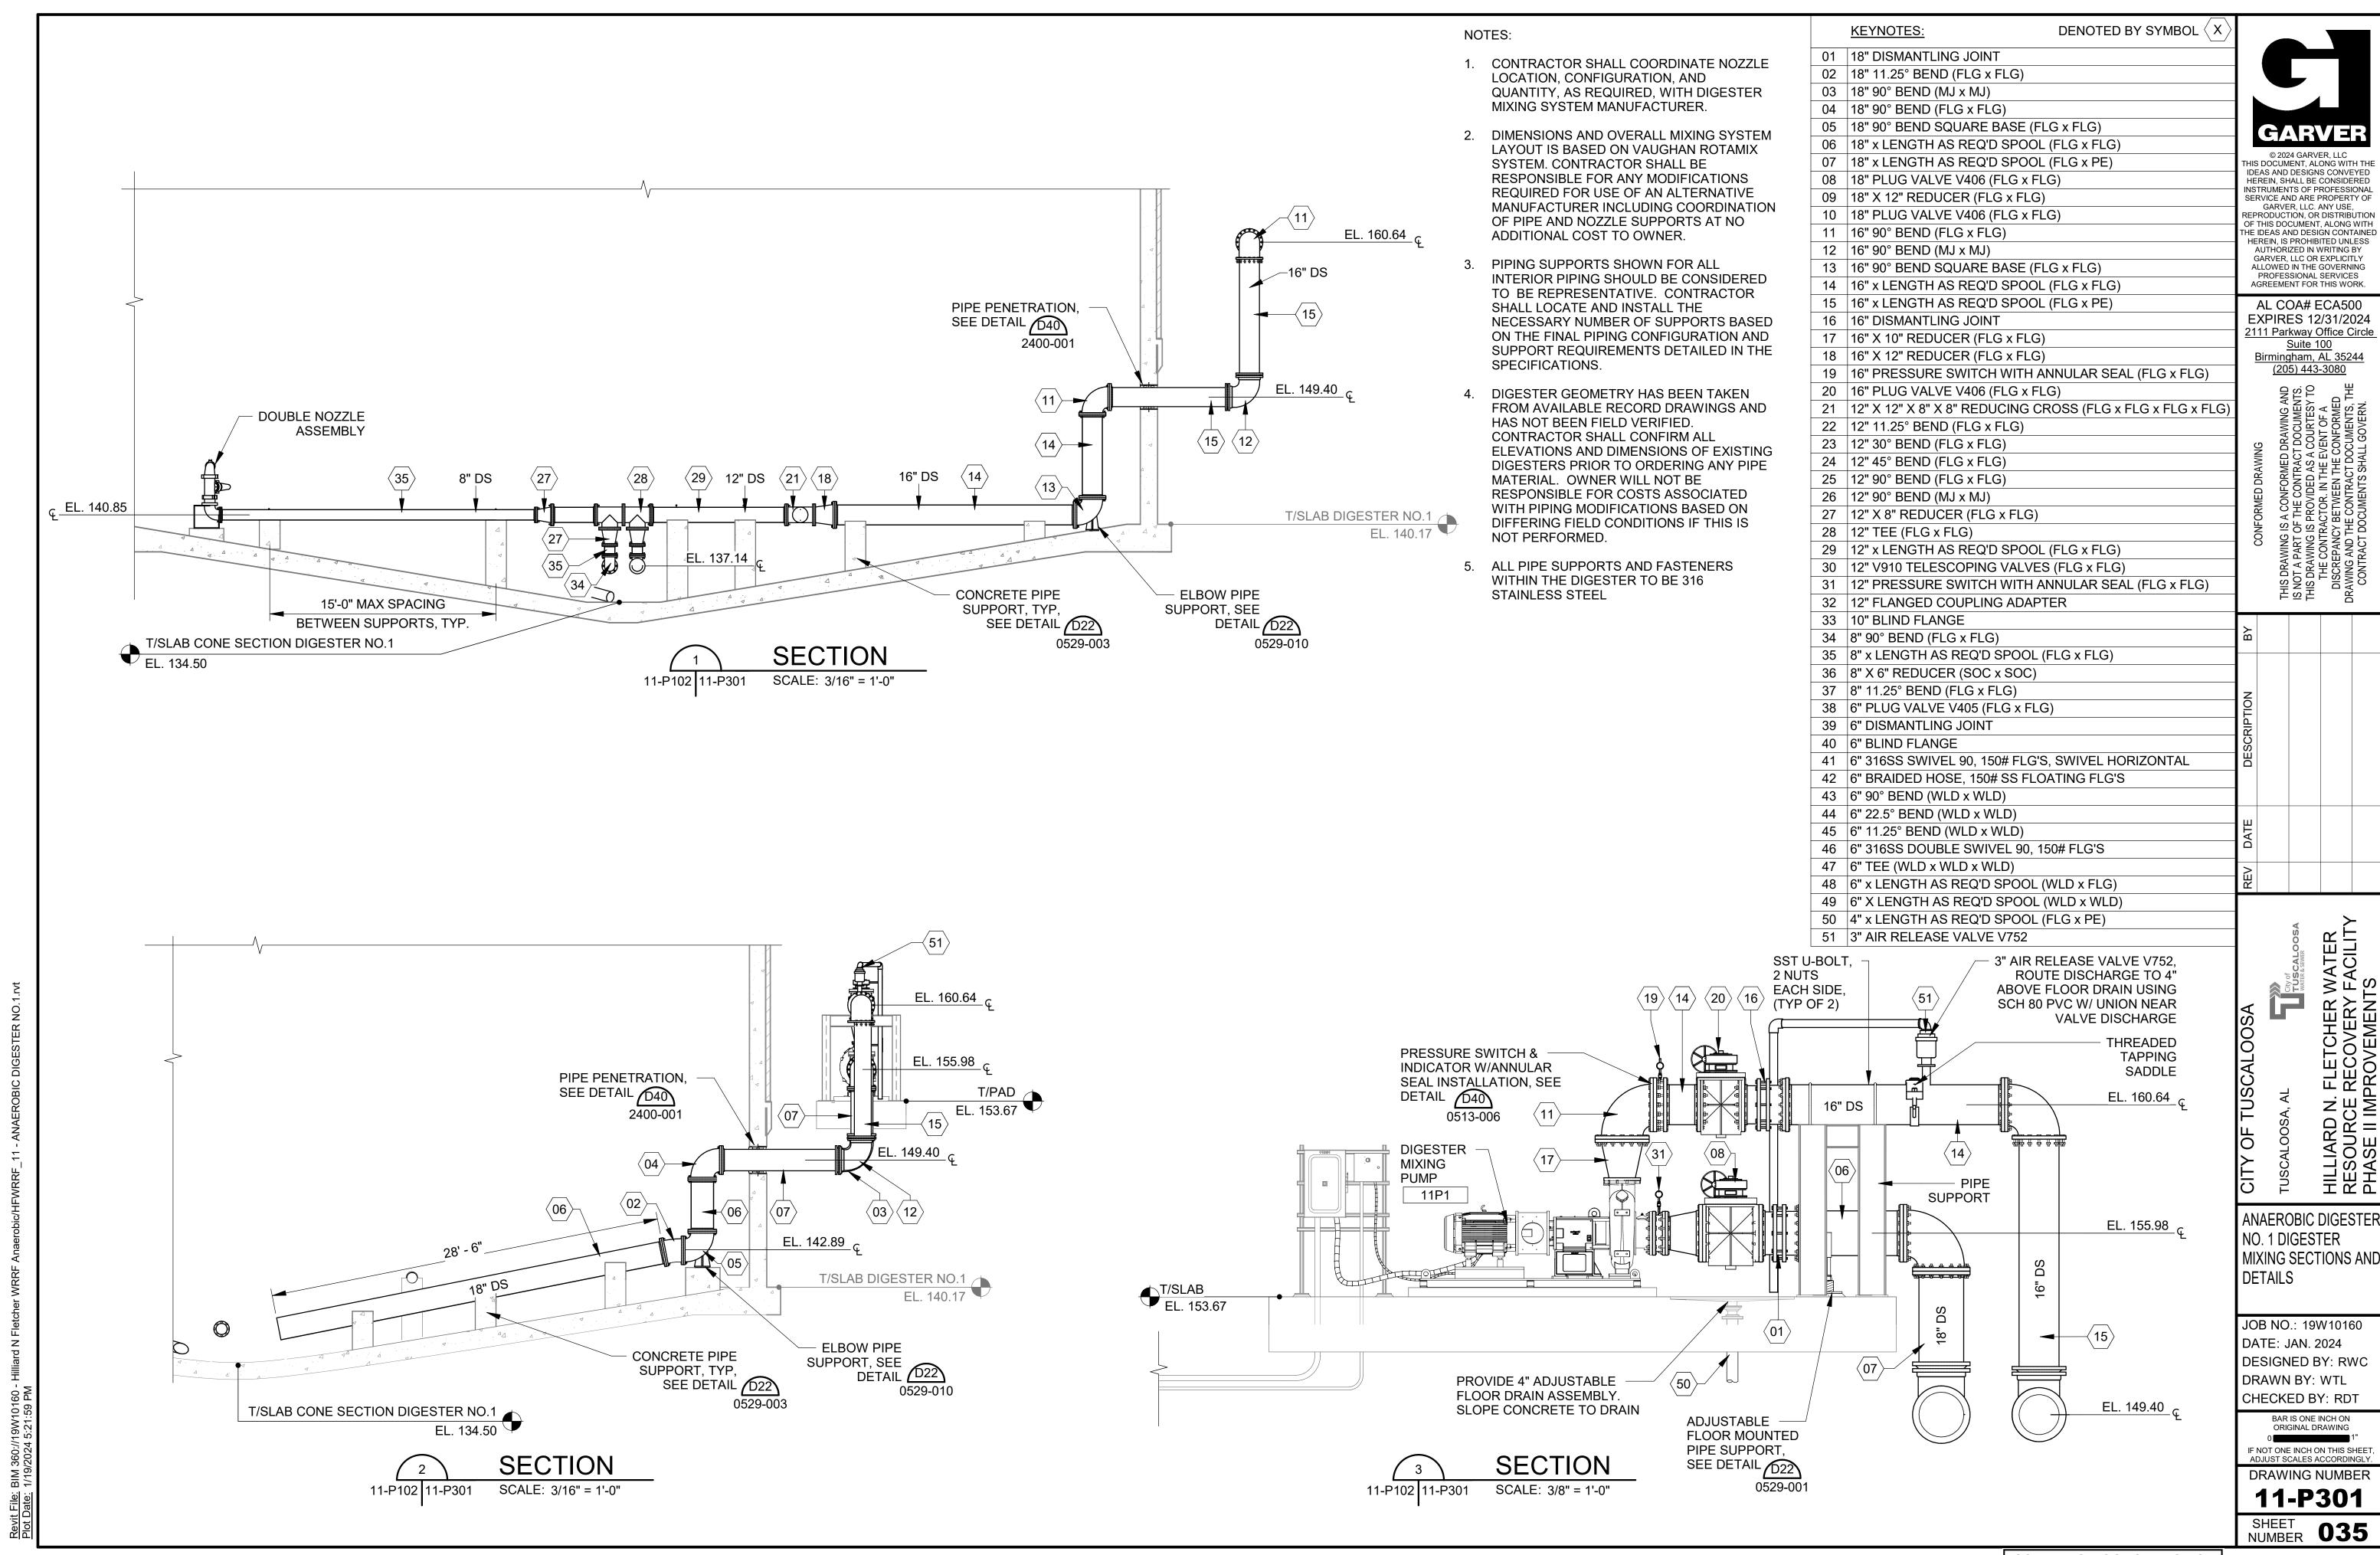



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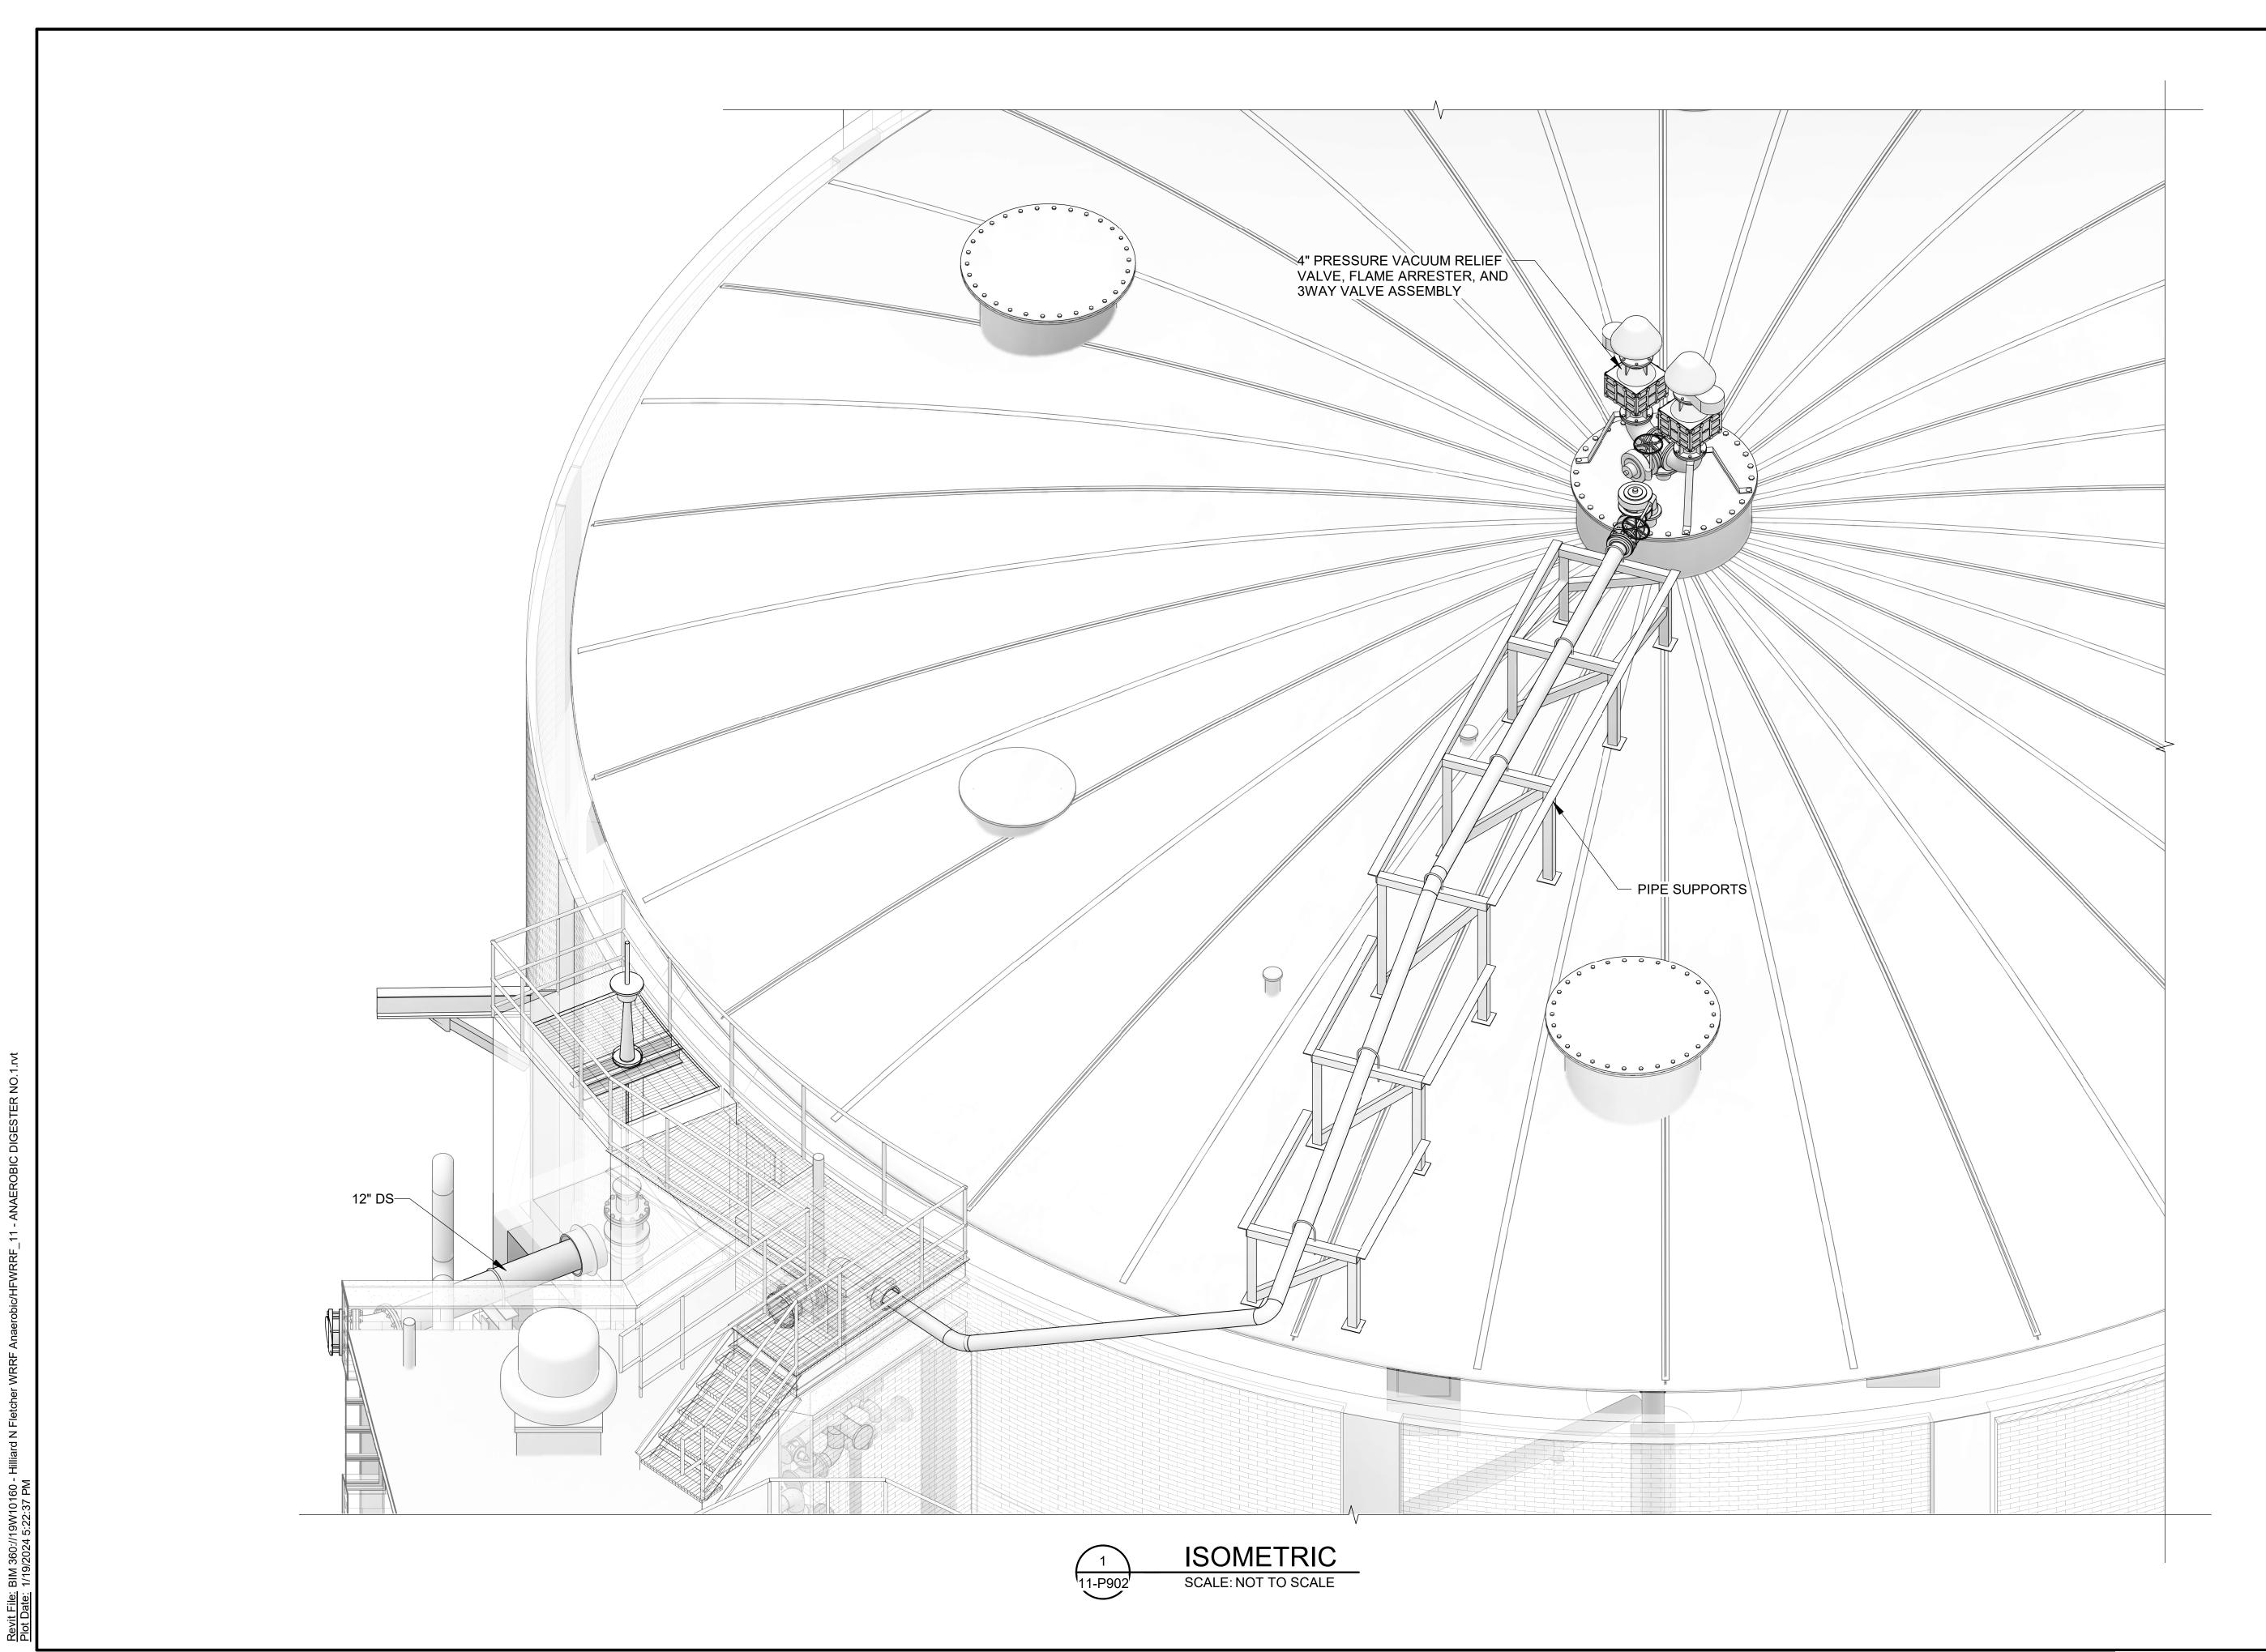
ANAEROBIC DIGESTER NO. 1 DIGESTER MIXING ISOMETRIC

JOB NO.: 19W10160 DATE: JAN. 2024 DESIGNED BY: RWC DRAWN BY: WTL CHECKED BY: RDT

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0 1" 1"
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11-P901 SHEET 038





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ANAEROBIC DIGESTER NO. 1 DIGESTER
COVER BIOGAS PIPING
ISOMETRIC


JOB NO.: 19W10160 DATE: JAN. 2024 DESIGNED BY: RWC DRAWN BY: ADA CHECKED BY: RDT

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0 1"

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11-P902 SHEET NUMBER 039



20CP1 INTERCONNECT DIAGRAM

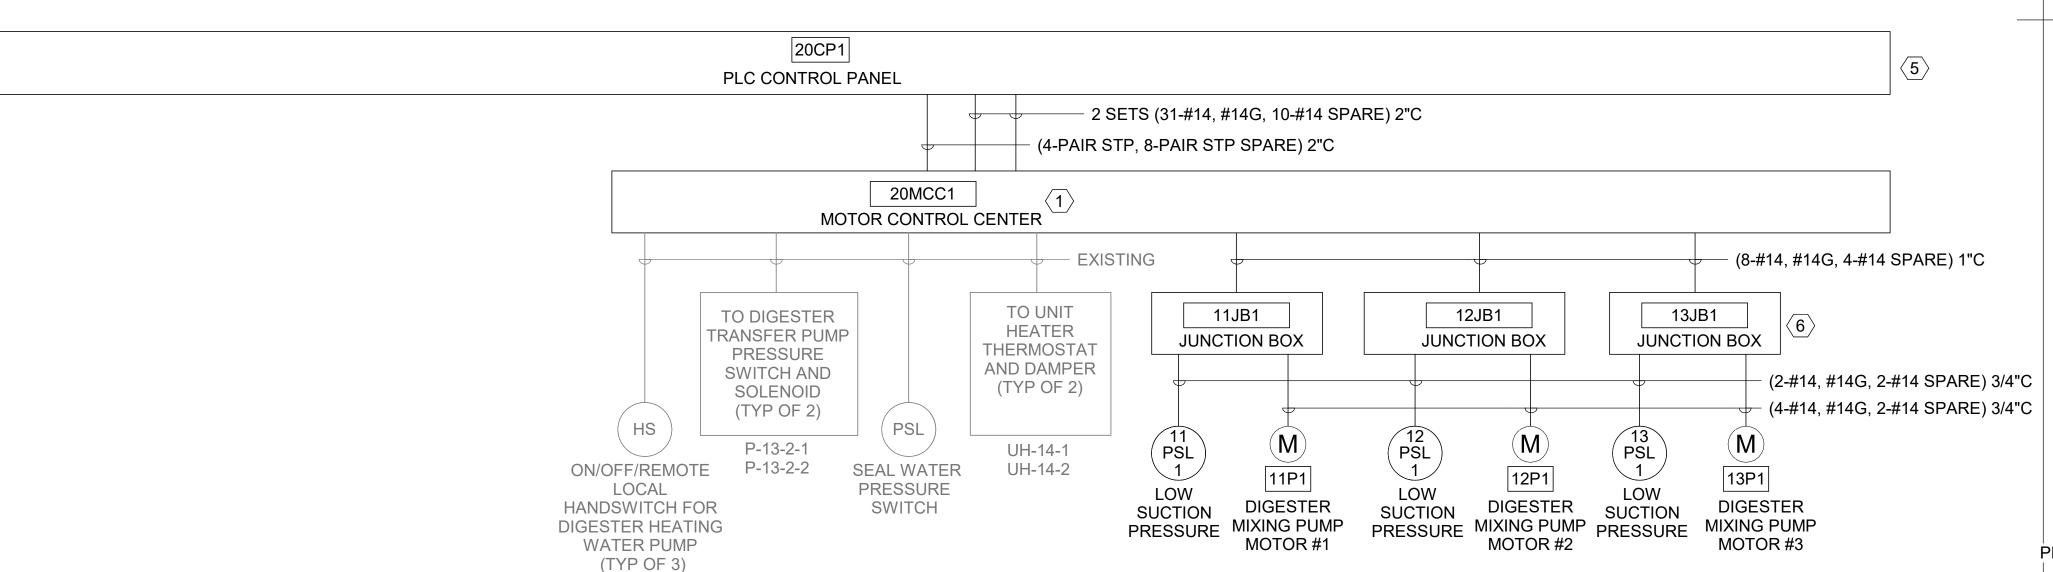DISCONNECT

11DS1

SCALE: NOT TO SCALE

UNISTRUT EQUIPMENT STAND WITH CONCRETE BASE. SEE

0529-014

GENERAL NOTES:

- THE CONTRACTOR SHALL FURNISH AND INSTALL ALL CONDUIT, WIRING, TERMINATIONS, DISCONNECTS, CONTROL RELAYS, CONTROL ENCLOSURES AND OTHER ITEMS AS NECESSARY FOR A COMPLETE AND FUNCTIONAL PUMP MIXING SYSTEM. CONTRACTOR SHALL REFER TO THE SPECIFICATIONS AND OTHER SECTIONS OF THE PLANS FOR ITEMS AS MAY BE REQUIRED.
- CONTRACTOR SHALL COORDINATE CONDUIT, WIRE AND INTERCONNECTIONS AS REQUIRED BY MIXER PUMP EQUIPMENT SUPPLIER. MAKE ALL REQUIRED CONNECTIONS ACCORDING TO MANUFACTURERS RECOMMENDATIONS. NOT ALL CONNECTIONS SHOWN.
- CONDUIT ROUTING AS SHOWN IS DIAGRAMMATIC IN NATURE AND SHOWN FOR REFERENCE ONLY. THE CONTRACTOR SHALL BE RESPONSIBLE FOR COORDINATING NUMBER OF REQUIRED CONDUITS AND PLACEMENT OF THESE CONDUITS. THE CONTRACTOR SHALL DEVELOP AND SUBMIT A CONDUIT ROUTING PLAN FOR REVIEW PRIOR TO INSTALLATION.
- 4. ALL AREAS 25' OVER DIGESTER TANK COVERS AND 10' BEYOND TANK WALLS SHALL BE CONSIDERED A CLASS1. DIVISION 2 LOCATION ACCORDING TO NFPA 820.
- CONTRACTOR SHALL STRICTLY ADHERE TO THE REQUIREMENTS IN NFPA 70, ARTICLE 500, HAZARDOUS (CLASSIFIED) LOCATIONS FOR ALL AREAS REFERENCED IN THE NOTES ABOVE. THIS INCLUDES PROVIDING APPROPRIATE SEAL FITTINGS ON CONDUITS CABLES, ALONG WITH PROVIDING EXPLOSION PROOF EQUIPMENT, RATED FOR THE CLASSIFICATION REFERENCED ABOVE, WITHIN THE HAZARDOUS AREA IF LOCATED IN THE HAZARDOUS AREA.

DIGESTER MIXING PUMP STATION #1 SECTION (TYP OF 3) SCALE: 1/2" = 1'-0" 11-E101 11-E101

PRESSURE

LOW SUCTION **PRESSURE**

SWITCH

11 PSL

DIGESTER

MIXING PUMP #1

11P1


JUNCTION BOX WITH

STOP PUSH BUTTON

11JB1

KEYNOTES:

- (1) SEE ONELINE ON SHEET 90-E502 FOR 480V CONDUIT AND CONDUCTORS.
- 2 SEE INTERCONNECT DIAGRAM ON THIS SHEET FOR MIXER PUMP SIGNAL AND CONTROL CONDUIT AND CONDUCTORS.
- (3) FOR MIXER PUMP CONTROL SCHEMATIC SEE SHEET 11-E601.
- 4 ROUTE CONDUITS ON EXISTING DIGESTER GAS SUPPORT STRUCTURE TO MCC IN DIGESTER CONTROL BUILDING. SEE SHEETS 05-E101, 20-E101 AND CONDUIT SUPPORT DETAIL ON THIS SHEET. ROUTE CONDUITS FOR MIXER PUMPS #2 AND #3 BELOW GRADE FROM MIXER PUMP STATIONS TO DIGESTER CONTROL BUILDING. SEE SHEETS 05-E101 AND 20-E101.
- (5) MAKE ALL REQUIRED CONNECTIONS AT NEW PLC CONTROL PANEL
- $\langle 6 \rangle$ 12" X 12" X 6" NEMA 4X SS ENCLOSURE WITH BACK PANEL, TERMINAL STRIPS AND FACE-MOUNTED MAINTAINED "STOP" PUSHBUTTON.
- (7) INSTALL UNISTRUT STAND, DISCONNECT AND JUNCTION BOX OUTSIDE OF HAZARDOUS AREA. PROVIDE SEAL FITTINGS AS REQUIRED, AS DEFINED IN GENERAL NOTES ABOVE.

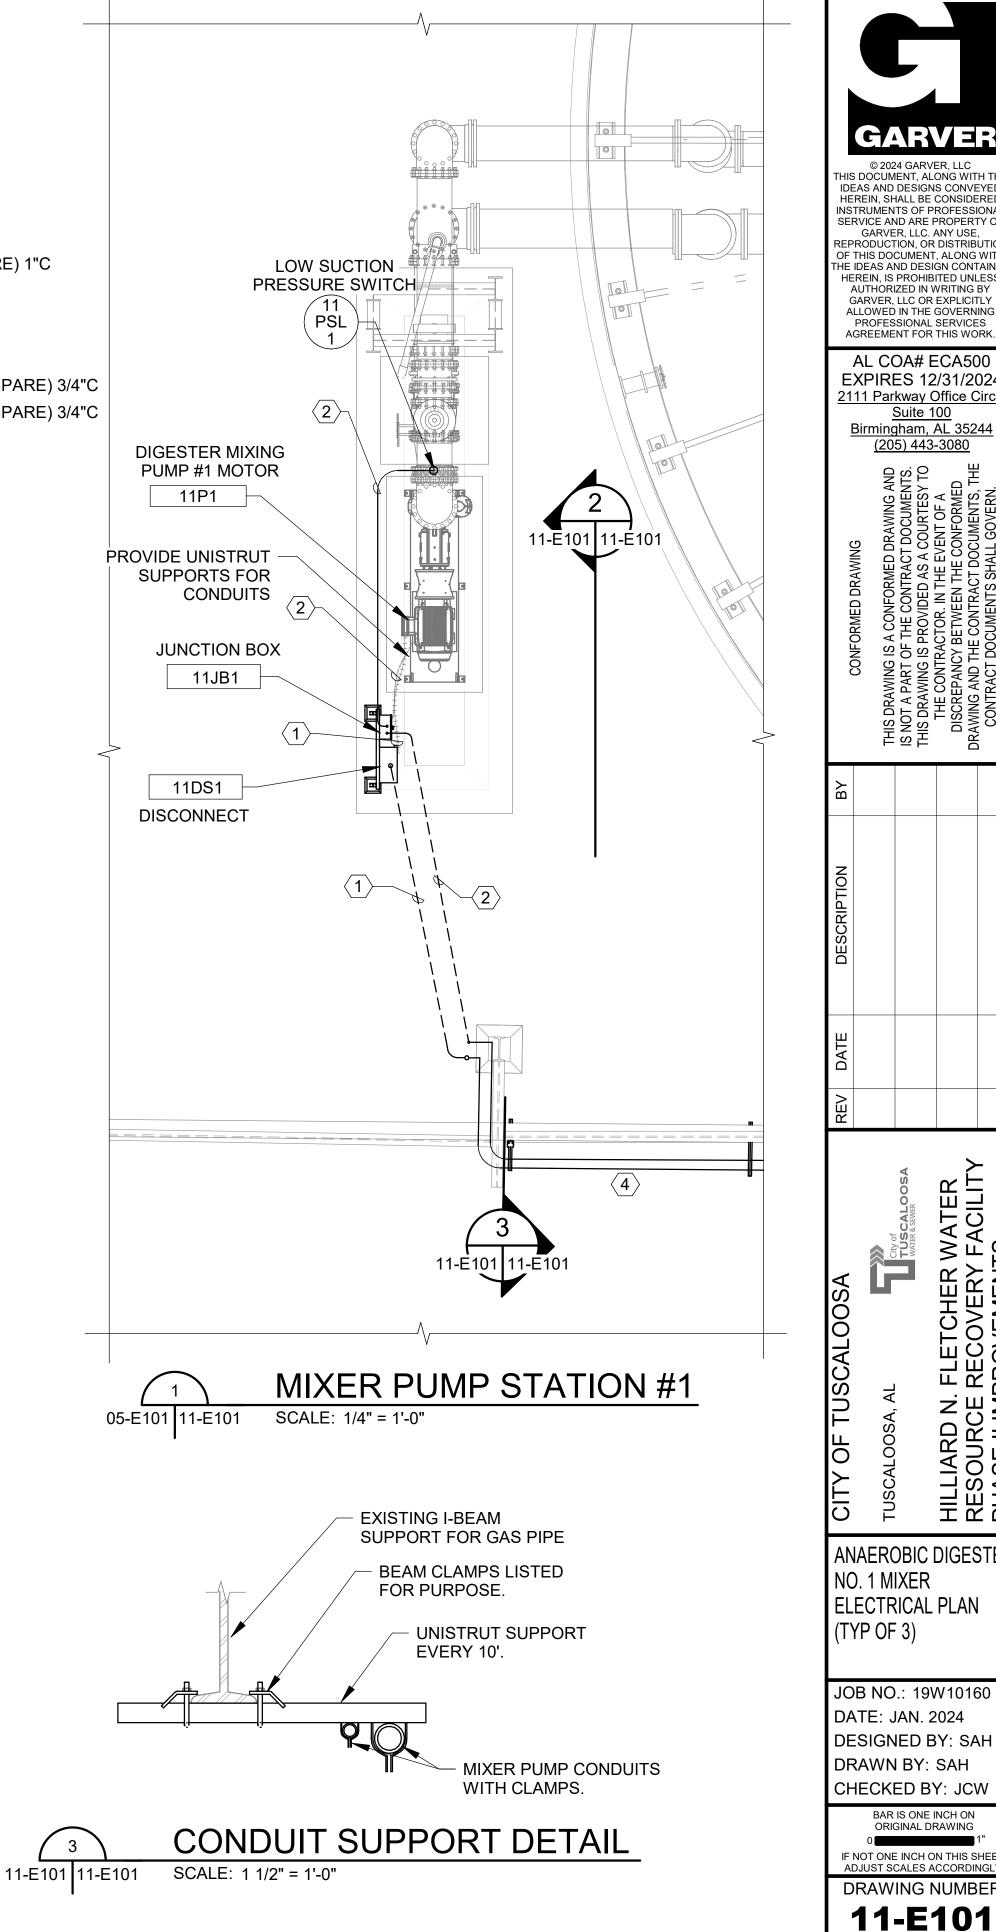

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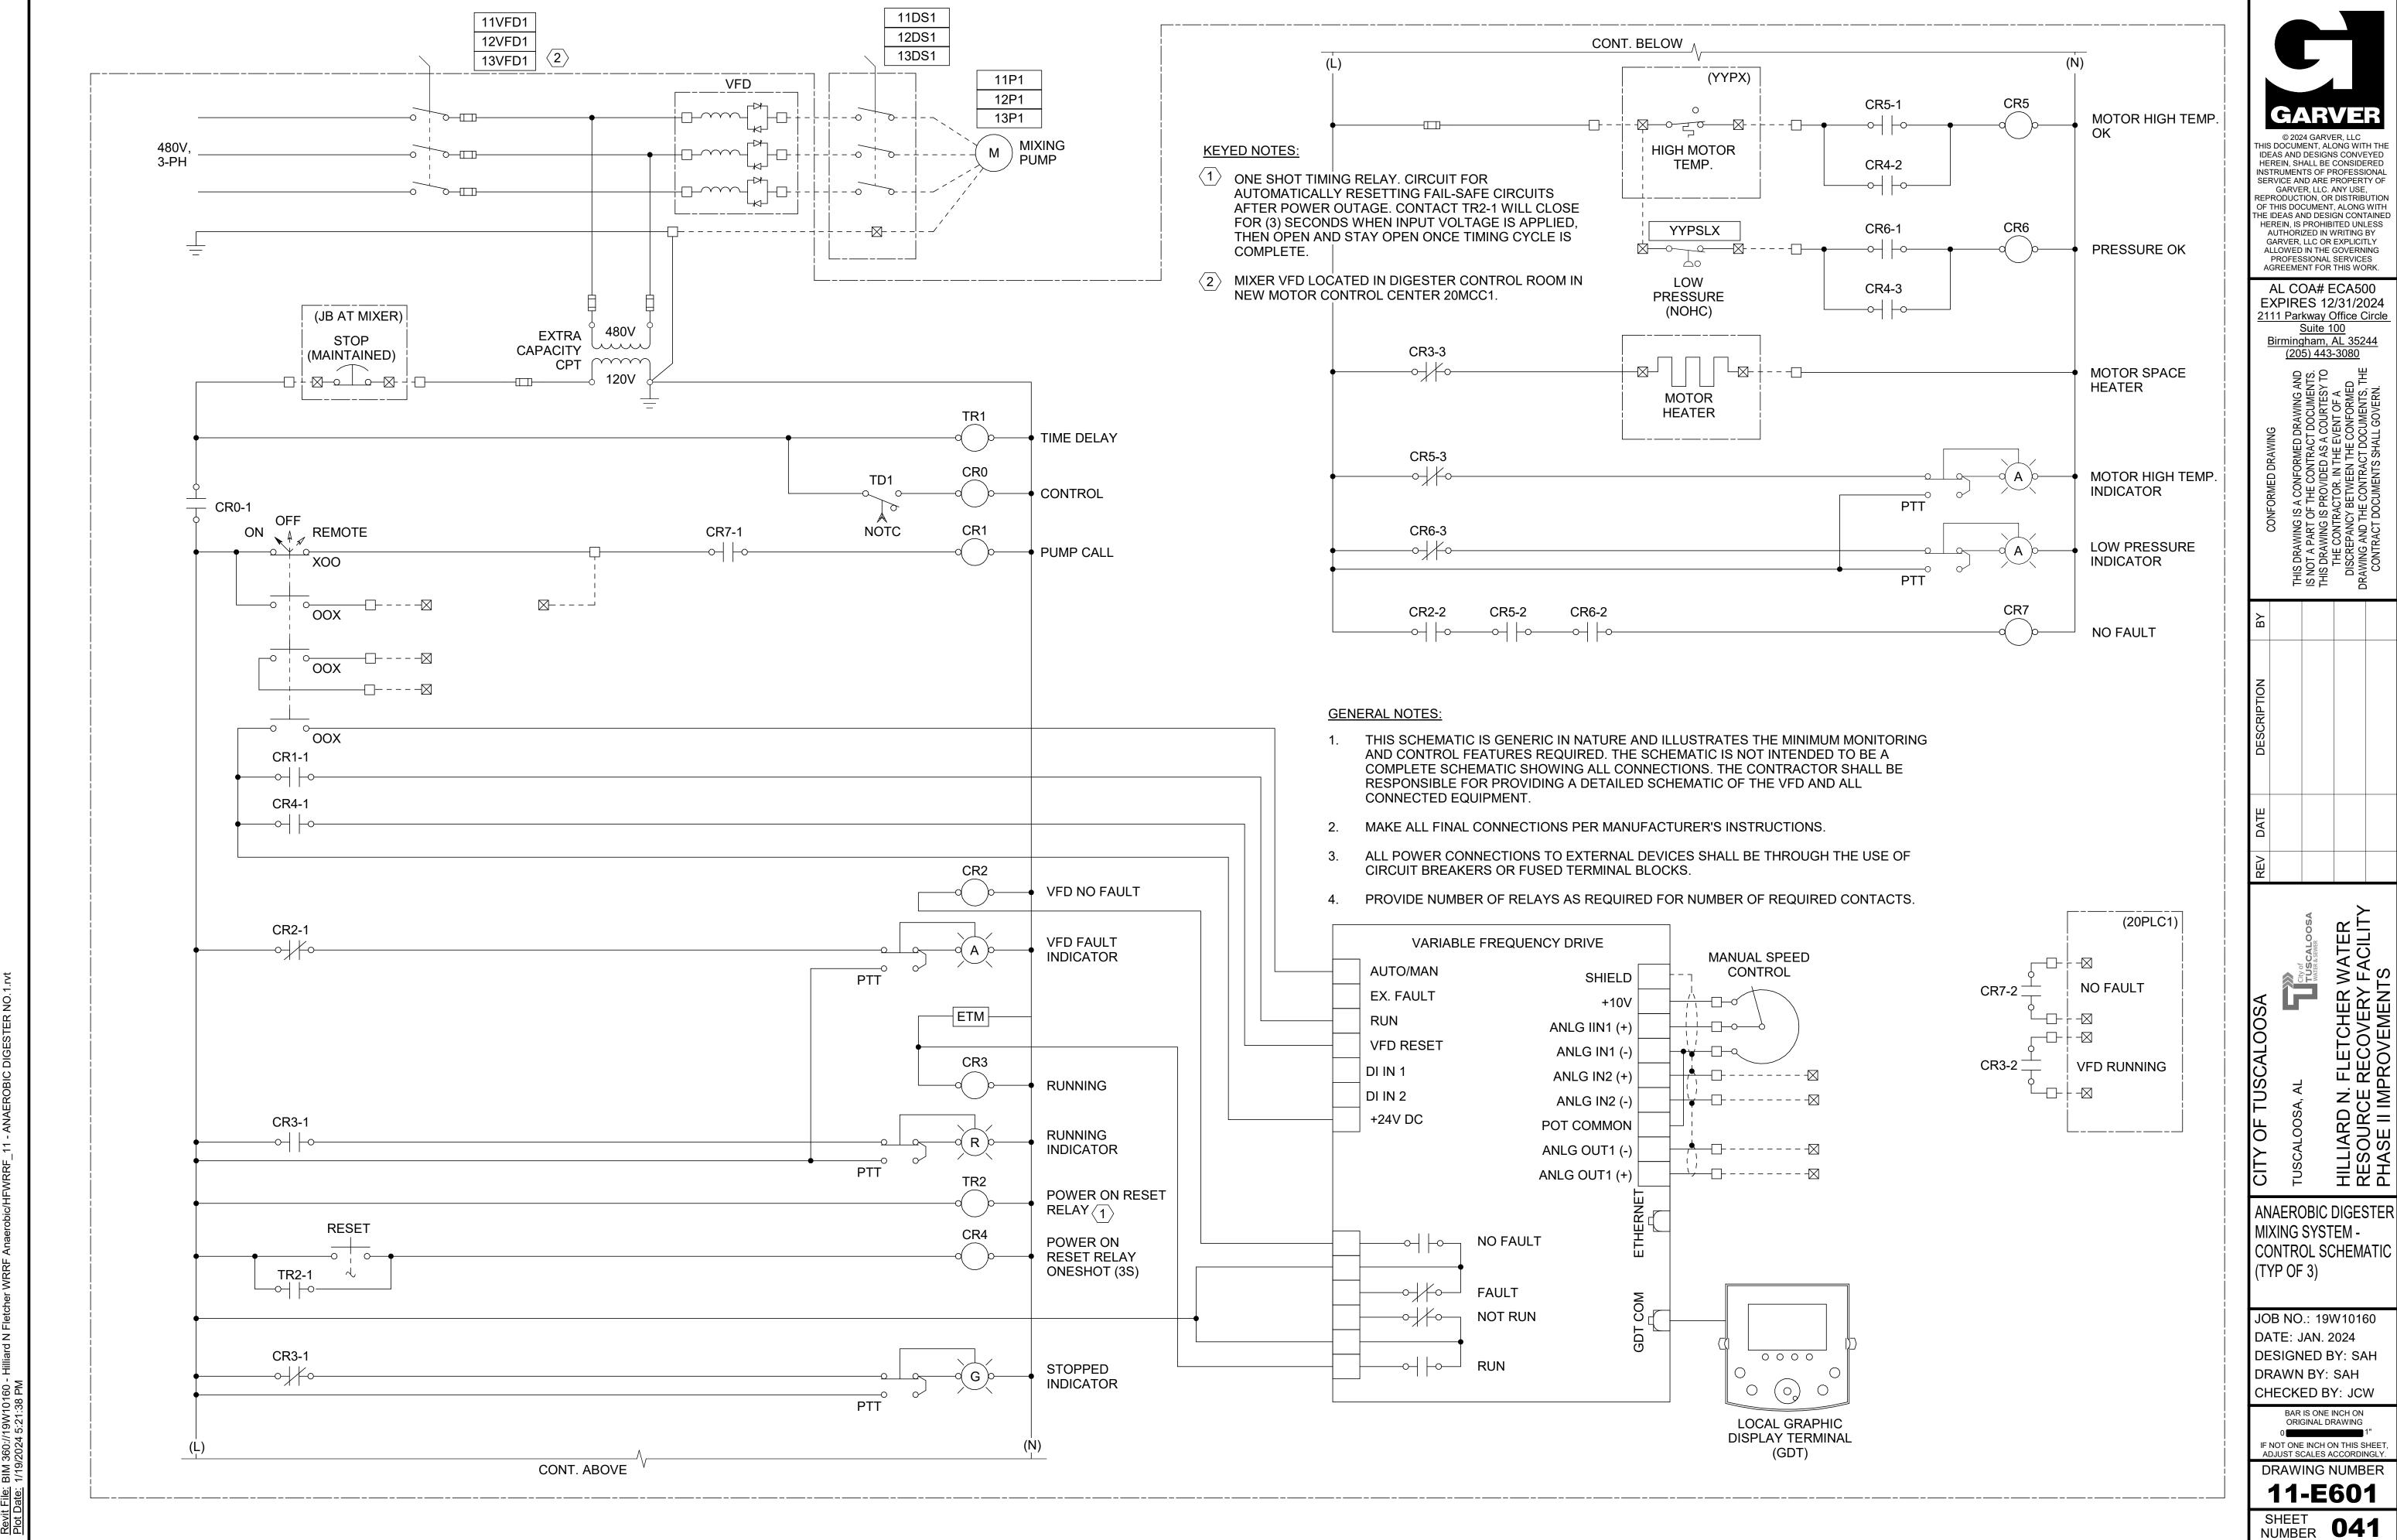
ANAEROBIC DIGESTER NO. 1 MIXER ELECTRICAL PLAN (TYP OF 3)

JOB NO.: 19W10160 **DATE: JAN. 2024 DESIGNED BY: SAH** DRAWN BY: SAH CHECKED BY: JCW


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NUMBER 040



NUMBER



DEMOLITION LEGEND

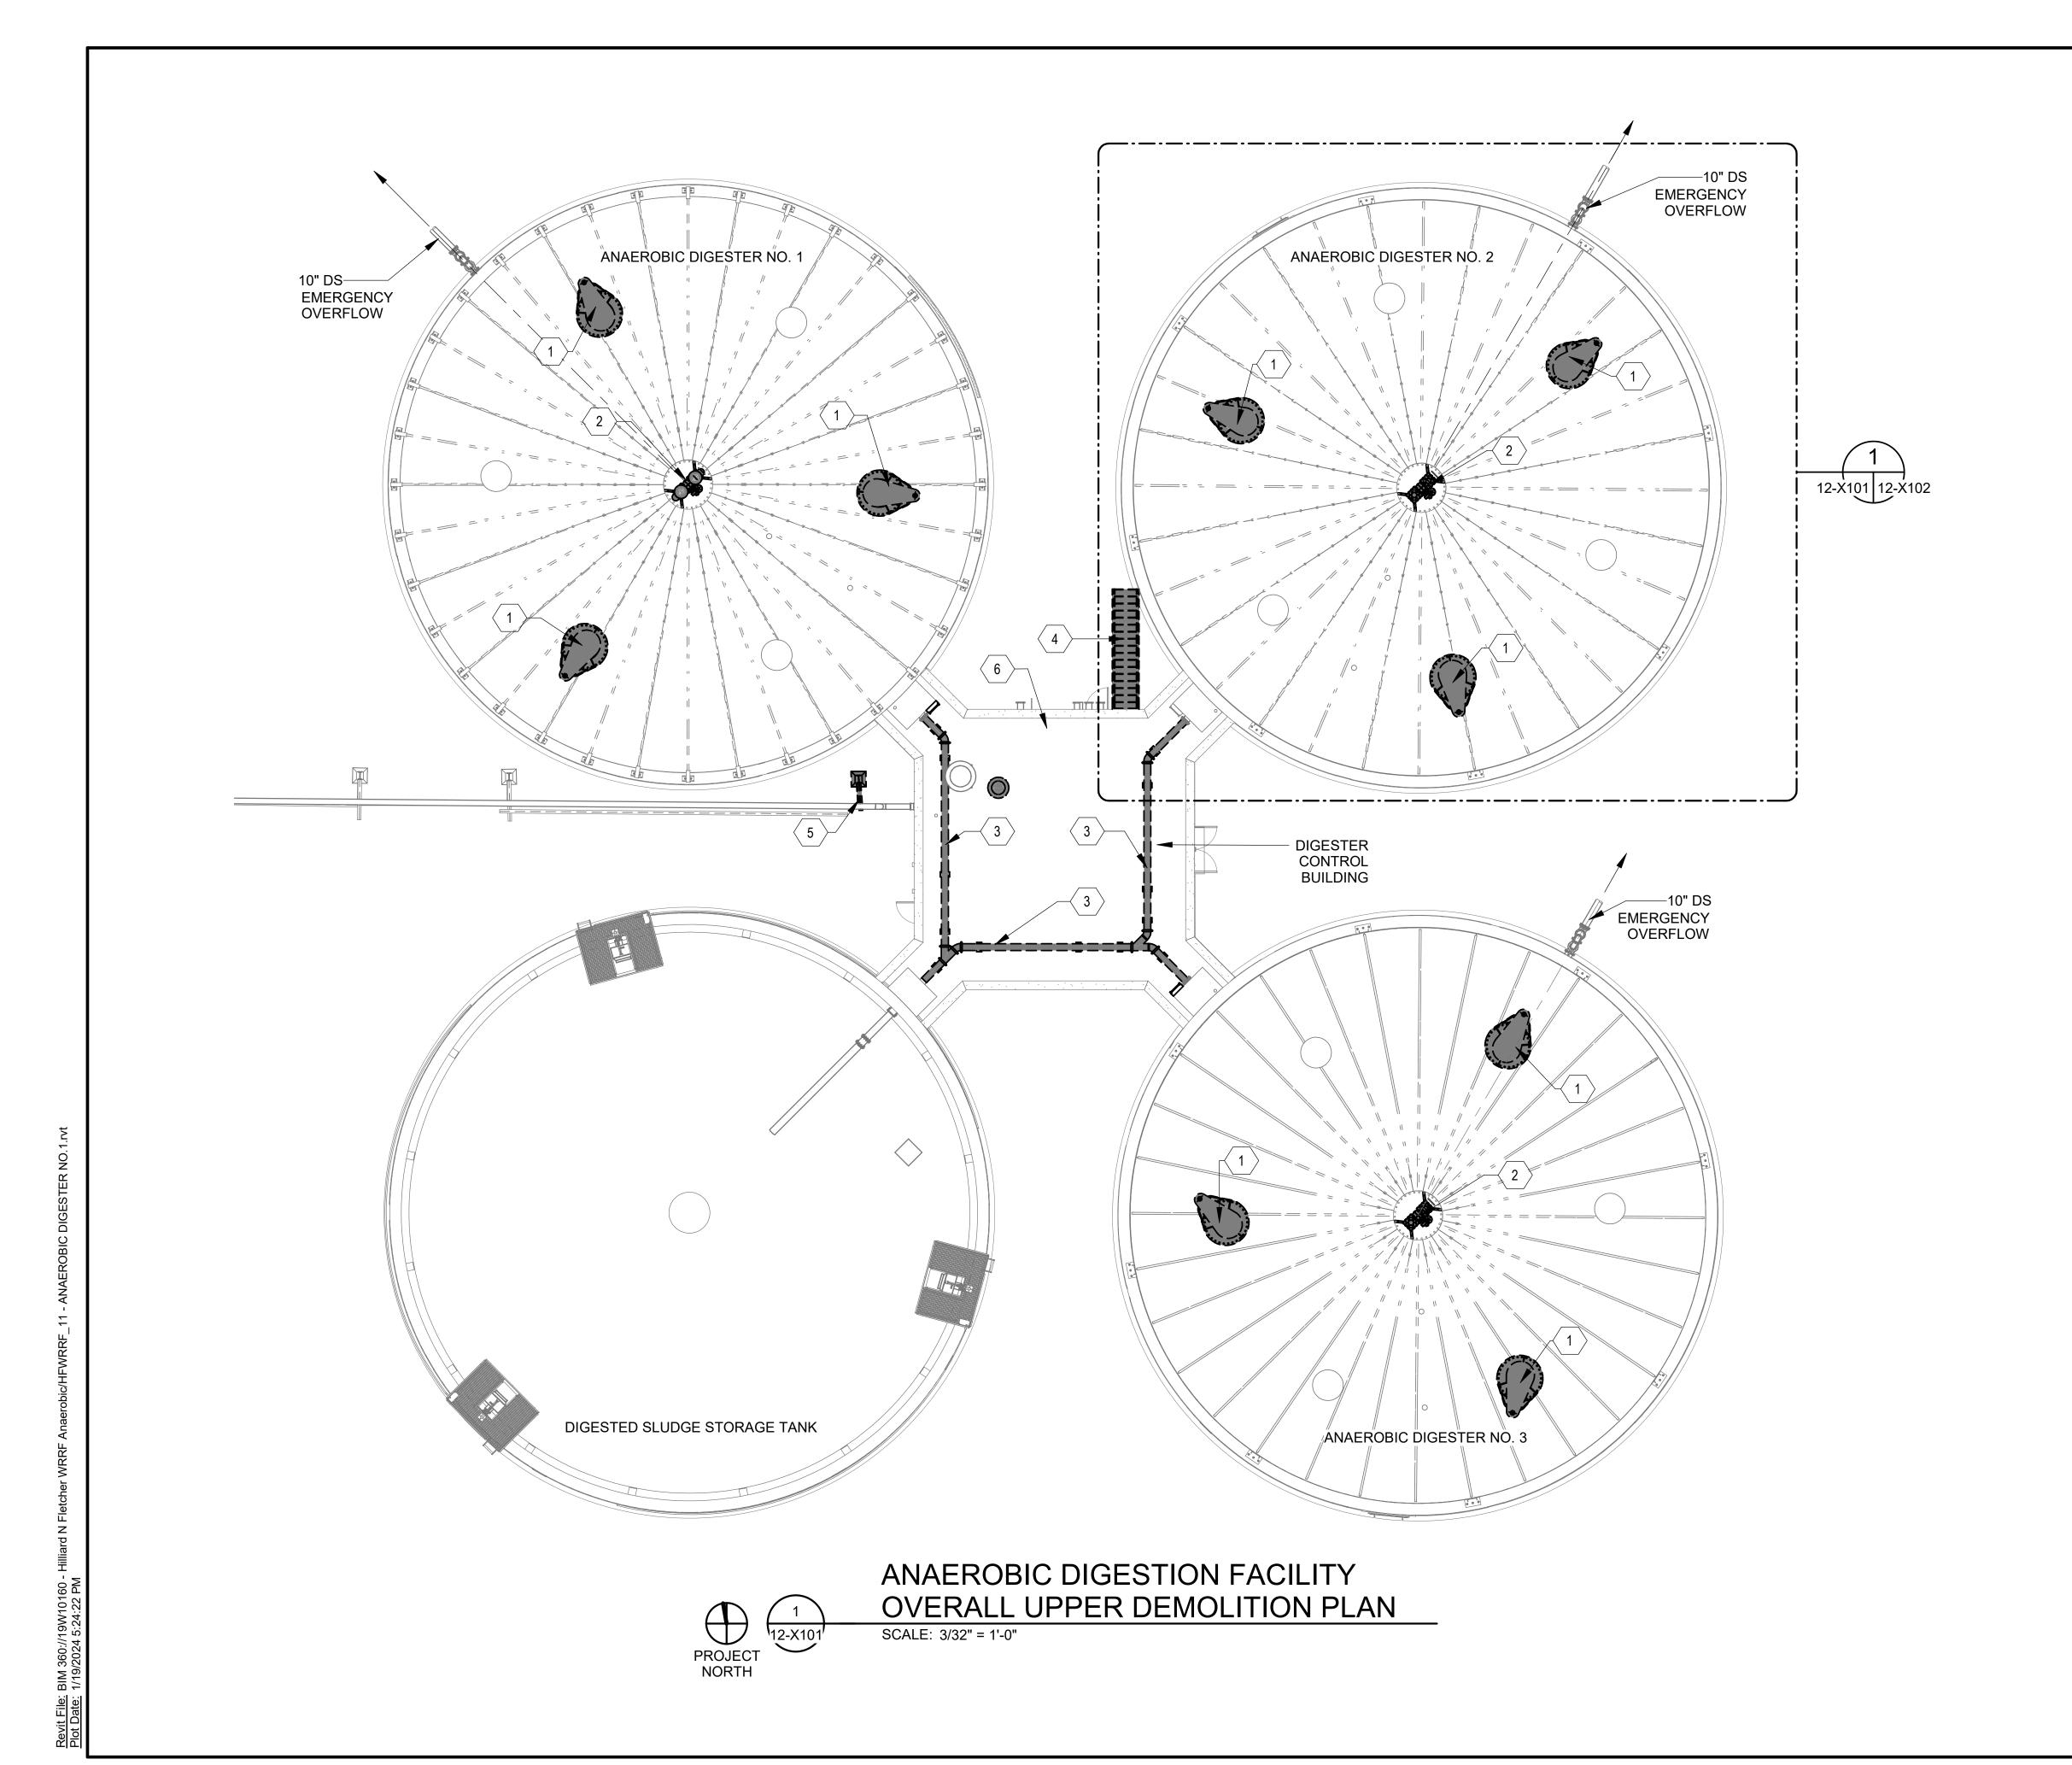TO BE DEMOLISHED



KEYNOTES:

DENOTED BY SYMBOL (X)

- DEMOLISH ALL EXISTING DIGESTER MIXING EQUIPMENT, TUBE SECTIONS, AND CONCRETE MIXER SUPPORTS. DRILL OUT EXPOSED REINFORCEMENT AS NEEDED AND PATCH SURFACE OF DIGESTER SLAB, PROVIDE BOLT-ON COVER OVER COVER OPENING WITH APPROPRIATE GASKET SYSTEM FOR SEALING.
- 2 REMOVE FLAME ARRESTORS, PRESSURE/VACUUM RELIEF VALVES AND THREE WAY VALVE.
- 3 DEMOLISH AND DISPOSE EXISTING 10" DIGESTED SLUDGE TRANSFER PIPE AND ASSOCIATED SUPPORTS ON ROOF.
- 4 DEMOLISH AND DISPOSE EXISTING STAIRS.
- 5 RELOCATE EXISTING PIPE SUPPORT. PROVIDE TEMPORARY PIPE SUPPORT DURING CONSTRUCTION PHASE.
- 6 CLEAN AND PREP ROOF FOR SPECIFIED COATING.

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TUSCALOOSA

WATER SEWER

FLETCHER WATER

CITY OF TUSCA

TUSCALOOSA, AL

HILLIARD N. FLE

RESOURCE RE

UPPER DEMOLITION
PLAN

JOB NO.: 19W10160

DIGESTION FACILITY

JOB NO.: 19W10160 DATE: JAN. 2024 DESIGNED BY: RWC DRAWN BY: WTL CHECKED BY: RDT

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12-X101

SHEET 042

KEYNOTES:

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- 1 DEMOLISH ALL EXISTING DIGESTER MIXING
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 SUPPORTS. DRILL OUT EXPOSED REINFORCEMENT AS
 NEEDED AND PATCH SURFACE OF DIGESTER SLAB,
 PROVIDE BOLT-ON COVER OVER COVER OPENING
 WITH APPROPRIATE GASKET SYSTEM FOR SEALING.
- 2 REMOVE FLAME ARRESTORS, PRESSURE/VACUUM RELIEF VALVES AND THREE WAY VALVE.
- 3 DEMOLISH AND DISPOSE EXISTING 10" DIGESTED SLUDGE TRANSFER PIPE AND ASSOCIATED SUPPORTS ON ROOF.
- 4 DEMOLISH AND DISPOSE EXISTING STAIRS.

DEMOLITION LEGEND

TO BE DEMOLISHED

GENERAL NOTES:

- 1. OWNER SHALL REMOVE ALL EXISTING SOLIDS TO THE GREATEST EXTENT POSSIBLE. ALL REMAINING SOLIDS SHALL BE REMOVED BY THE CONTRACTOR AS DETAILED IN SPECIFICATION SECTION 44 10 00.
- 2. IT IS THE CONTRACTOR'S SOLE RESPONSIBILITY TO DETERMINE PROCEDURE AND SEQUENCE TO ENSURE THE SAFETY OF THE TANK AND ITS COMPONENT PARTS DURING REHABILITATION AND TO PROVIDE ANY REQUIRED TEMPORARY BRACING, GUYS, OR TIEDOWNS AS NECESSARY FOR COMPLETION OF THE WORK. SUCH MATERIAL SHALL BE REMOVED FROM THE SITE AND REMAIN THE CONTRACTOR'S PROPERTY AFTER COMPLETION OF THE WORK.
- 3. CONTRACTOR SHALL EXERCISE EXTREME CARE WHEN DRAINING AND/OR FILLING THE DIGESTER TANK. ALL PRESSURE RELIEF AND VACUUM RELIEF VALVES SHALL BE IN WORKING CONDITION UNLESS OTHER MEANS ARE PROVIDED TO PREVENT PRESSURIZED OR VACUUM CONDITIONS WITHIN THE DIGESTER, WHICH MAY CAUSE DAMAGE TO THE COVER.
- 4. EXISTING DOME FRAMING SUPPORT MEMBERS SHALL NOT BE DAMAGED DURING SAWCUTTING OR OTHER MEANS USED FOR REMOVAL OF THE PLATE SECTIONS.
- CONTRACTOR SHALL REMOVE ALL EXISTING EXPOSED CONDUIT TO COVER MOUNTED EQUIPMENT, INSTRUMENTATION, AND OTHER DEVICES THAT IS/WILL BE NO LONGER IN SERVICE. SEAL/PATCH ANY HOLES, AS REQUIRED.
- CONTRACTOR SHALL ASSESS THE STRUCTURAL STABILITY OF ALL EXPOSED BRICK SECTIONS/FACADES ON EXTERIOR OF DIGESTER TANK. ANY ADDITIONAL REPAIRS AND/OR DEMOLITION NECESSARY TO ADDRESS THESE AREAS SHALL BE PAID FROM USING THE CONTINGENCY ALLOWANCE BASED ON EXTENT OF REPAIRS OR ADDITIONAL DEMOLITION.

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N. FLETCHER WATER
SE RECOVERY FACILITY
IMPROVEMENTS

ANAEROBIC DIGESTER
NO. 2 UPPER
DEMOLITION PLAN

JOB NO.: 19W10160 DATE: JAN. 2024 DESIGNED BY: RWC DRAWN BY: WTL CHECKED BY: RDT

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 NEEDED AND PATCH SURFACE OF DIGESTER SLAB,
 PROVIDE BOLT-ON COVER OVER COVER OPENING
 WITH APPROPRIATE GASKET SYSTEM FOR SEALING.
- 2 DEMOLISH AND DISPOSE EXISTING STAIRS.
- DEMOLISH AND REMOVE EXISTING DIGESTER RECIRCULATION PIPING AND SUPPORT STRUCTURE. EXISTING PIPING TO BE DEMO'D UP TO THE FIRST FLANGE FROM THE WALL. DRILL OUT EXPOSED REINFORCEMENT AS NEEDED AND PATCH SURFACE OF DIGESTER SLAB.
- 4 DEMOLISH EXISTING BRICK FACADE TO EXTENT NECESSARY TO INSTALL NEW DIGESTER TRANSFER BOX. REPLACE BRICK FACADE UP TO THE EDGE OF THE TRANSFER BOXES WITH MATCHING BRICK.

DEMOLITION LEGEND

TO BE DEMOLISHED

GENERAL NOTES:

- 1. OWNER SHALL REMOVE ALL EXISTING SOLIDS TO THE GREATEST EXTENT POSSIBLE. ALL REMAINING SOLIDS SHALL BE REMOVED BY THE CONTRACTOR AS DETAILED IN SPECIFICATION SECTION 44 10 00.
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- B. CONTRACTOR SHALL EXERCISE EXTREME CARE WHEN DRAINING AND/OR FILLING THE DIGESTER TANK. ALL PRESSURE RELIEF AND VACUUM RELIEF VALVES SHALL BE IN WORKING CONDITION UNLESS OTHER MEANS ARE PROVIDED TO PREVENT PRESSURIZED OR VACUUM CONDITIONS WITHIN THE DIGESTER, WHICH MAY CAUSE DAMAGE TO THE COVER.

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NO N. FLETCHER WATER
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II IMPROVEMENTS

ANAEROBIC DIGESTER NO. 2 LOWER DEMOLITION PLAN

JOB NO.: 19W10160 DATE: JAN. 2024 DESIGNED BY: RWC DRAWN BY: WTL CHECKED BY: RDT

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DRAWING NUMBER

ANAEROBIC DIGESTER NO. 2 LOWER DEMOLITION PLAN

PROJECT 1 12-X103

NORTH

ANAEROBIC DIGESTER NO. 2 DEMOLITION SECTION

SCALE: 3/16" = 1'-0"

DENOTED BY SYMBOL \langle X \rangle

1 DEMOLISH ALL EXISTING DIGESTER MIXING EQUIPMENT, TUBE SECTIONS, AND CONCRETE MIXER SUPPORTS. DRILL OUT EXPOSED REINFORCEMENT AS NEEDED AND PATCH SURFACE OF DIGESTER SLAB, PROVIDE BOLT-ON COVER OVER COVER OPENING WITH APPROPRIATE GASKET SYSTEM FOR SEALING.

KEYNOTES:

- 2 DEMOLISH AND REMOVE EXISTING DIGESTER RECIRCULATION PIPING AND SUPPORT STRUCTURE EXISTING PIPING TO BE DEMO'D UP TO THE FIRST FLANGE FROM THE WALL. DRILL OUT EXPOSED REINFORCEMENT AS NEEDED AND PATCH SURFACE OF DIGESTER SLAB.
- 3 REMOVE ALL EXISTING EXTERIOR DIGESTER MIXING EQUIPMENT. PROVIDE BOLT-ON COVER OVER COVER OPENING WITH APPROPRIATE GASKET SYSTEM FOR SEALING.
- 4 REMOVE FLAME ARRESTORS, PRESSURE/VACUUM RELIEF VALVES AND THREE WAY VALVE.
- 5 REFER TO SPECIFICATION SECTION 44 10 00 FOR DIGESTER CLEANOUT REQUIREMENTS.
- 6 CONTRACTOR TO JET AND CLEANOUT EXISTING OVERFLOW PIPING TO REMOVE ANY OBSTRUCTIONS OR BLOCKAGE. SANDBLAST AND RECOAT PIPING ACCORDING TO COATING SCHEDULE SPECIFIED IN
- CONTRACTOR TO REMOVE AND REPLACE EXISTING DIGESTED SLUDGE TRANSFER PIPING AND PIPE SUPPORT HARDWARE. EXISTING PIPE SUPPORTS TO REMAIN. PIPING TO BE DEMO'D UP TO THE FIRST

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<u>Suite 100</u>

Birmingham, AL 35244

(205) 443-3080

ANAEROBIC DIGESTER NO. 2 DEMOLITION SECTION

JOB NO.: 19W10160 DATE: JAN. 2024 **DESIGNED BY: RWC** DRAWN BY: WTL CHECKED BY: RDT

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12-X301

SHEET **045**

NOTES:

1. INTERIOR TANK DETAILS HAVE BEEN PROVIDED BASED ON

CONTRACTOR IS RESPONSIBLE FOR FIELD VERIFYING ALL

CONTRACTOR SHALL NOTIFY ENGINEER IF THERE IS A


CONFLICT BETWEEN THE CONTRACT DOCUMENTS AND EXISTING CONDITIONS BEFORE PROCEEDING WITH WORK.

OF ALL EXISTING STRUCTURES, EQUIPMENT, AND UTILITIES.

VERIFIED FOR ACCURACY.

AVAILABLE RECORD DRAWINGS. DIMENSIONS HAVE NOT BEEN

EXISTING CONDITIONS INCLUDING LOCATION AND DIMENSIONS

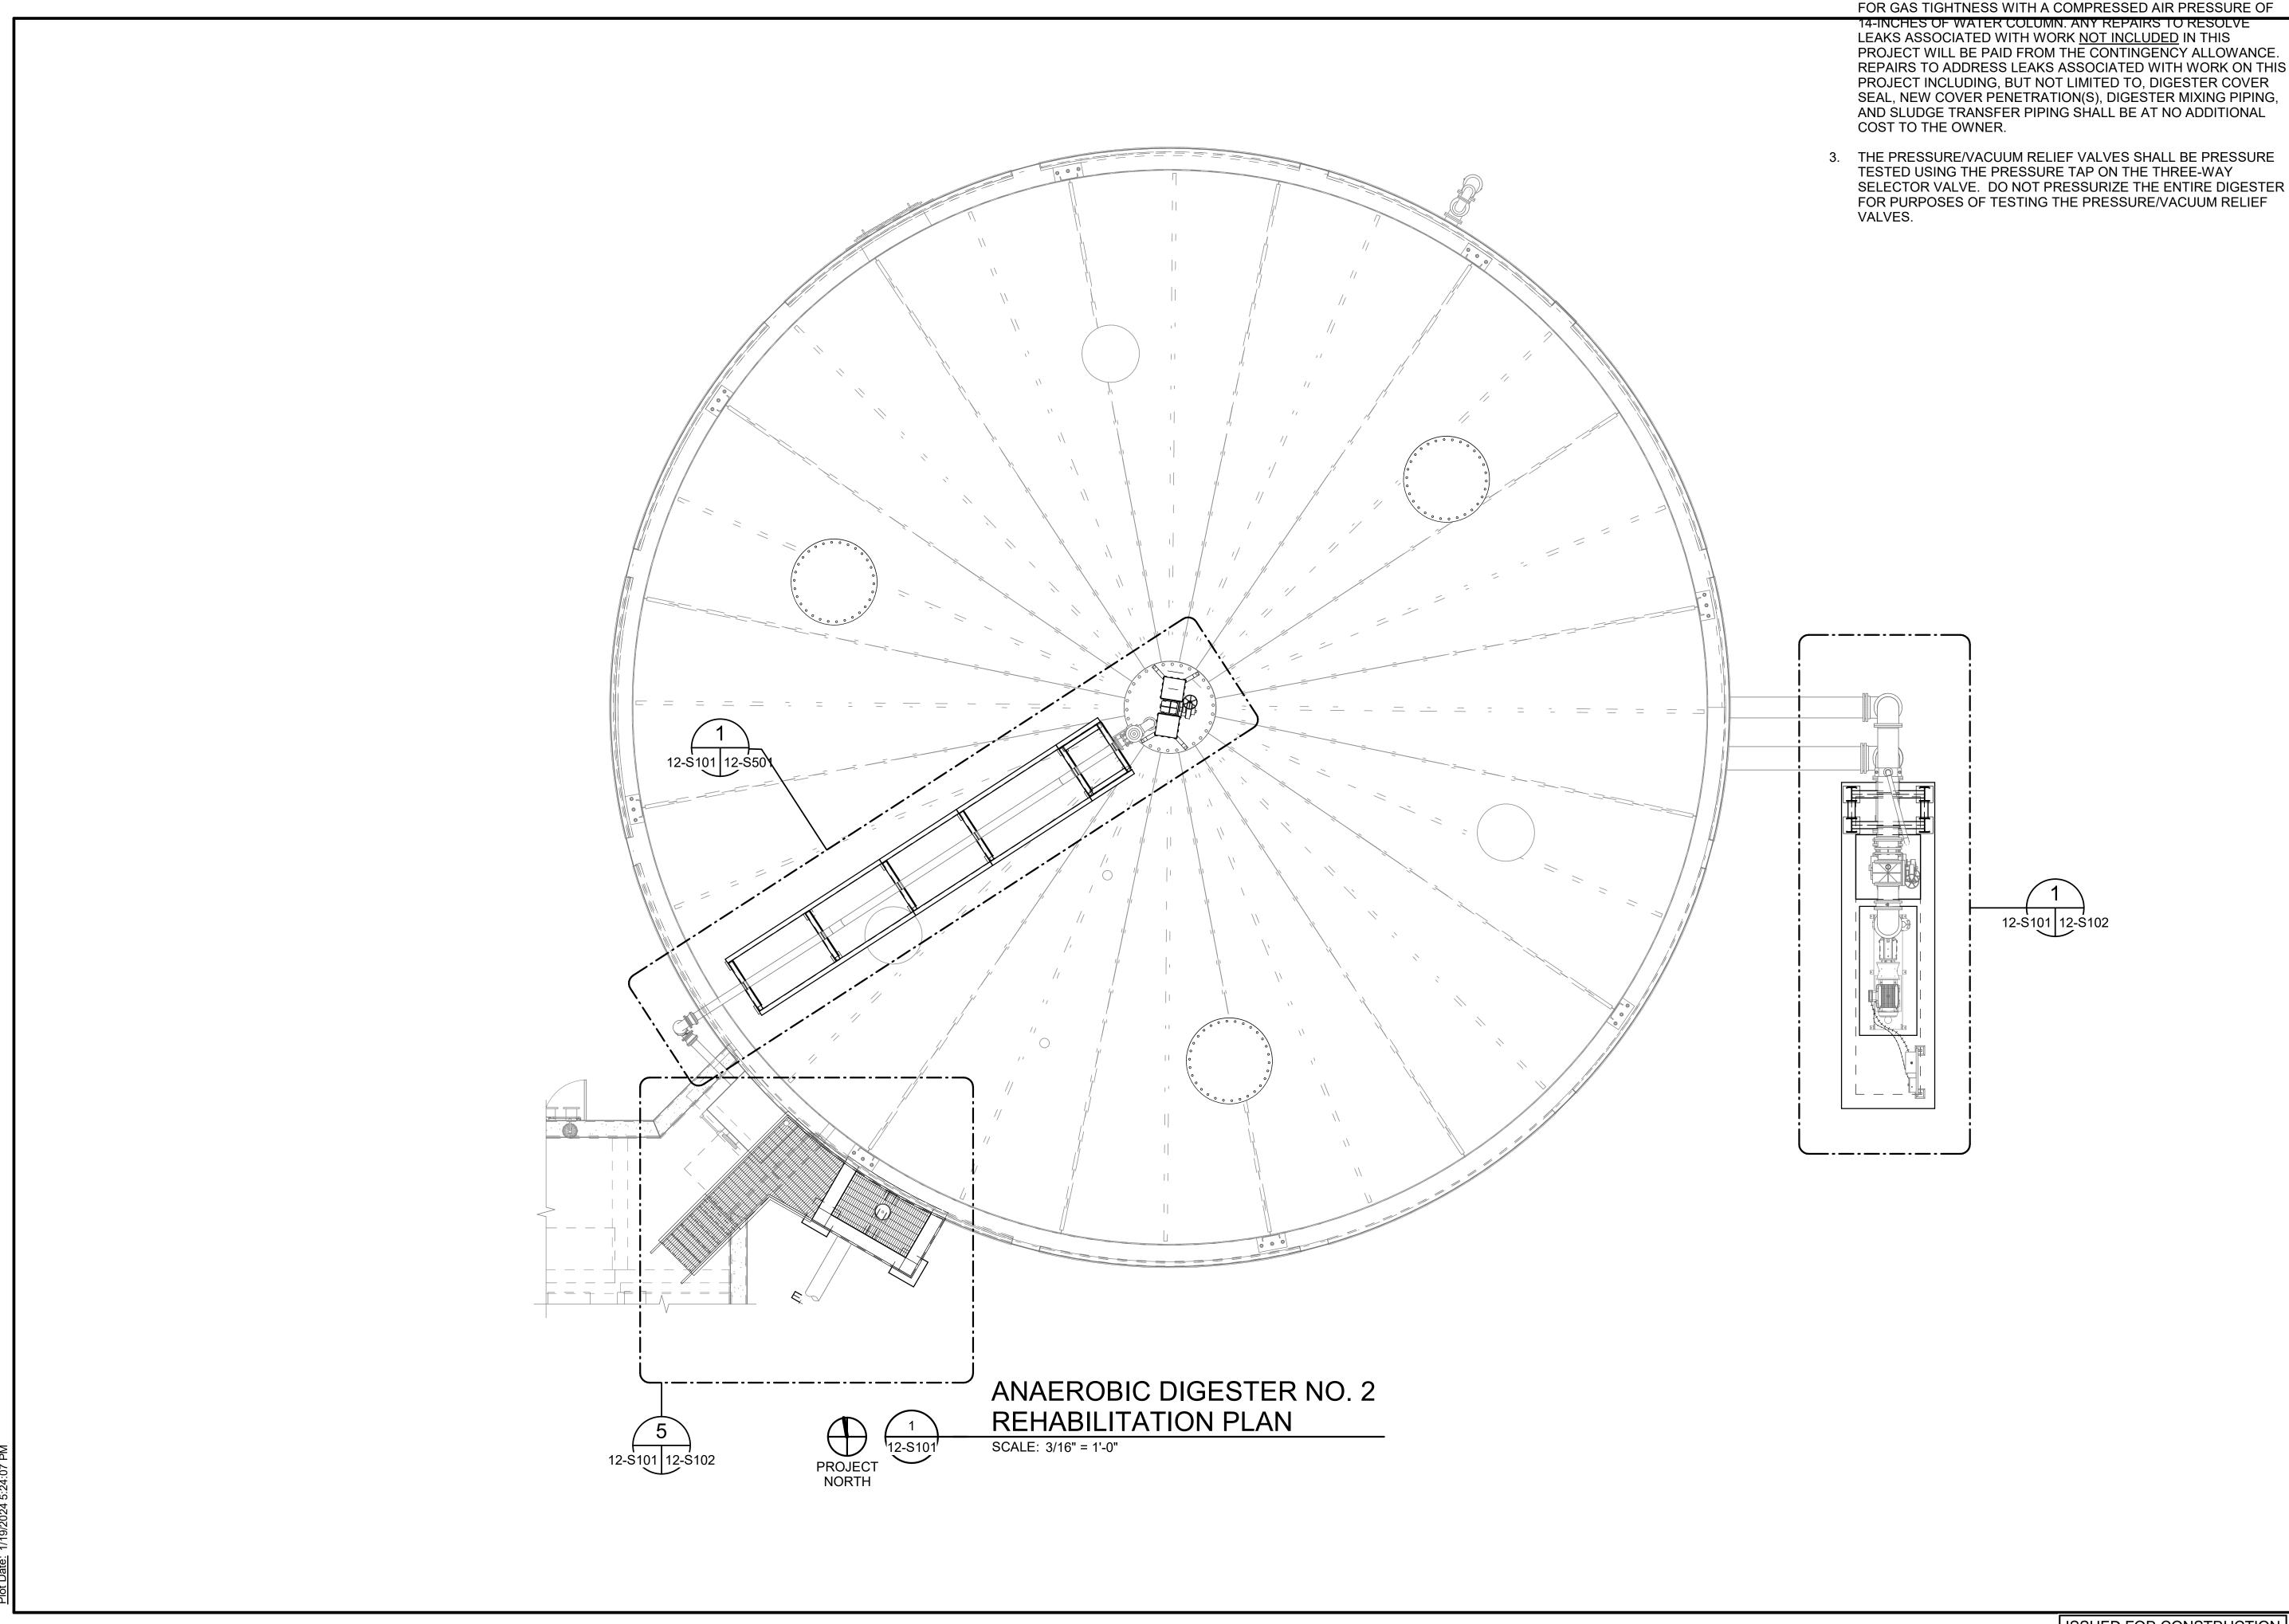

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2. AS PART OF FILLING THE DIGESTER WITH WATER TO COMPLETE

FUNCTIONAL TESTING, CONTRACTOR SHALL TEST THE DIGESTER

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HILLIARD N. FLETCHER WATE

RESOURCE RECOVERY FACIL

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ANAEROBIC DIGESTER NO. 2 REHABILITATION PLAN


JOB NO.: 19W10160 DATE: JAN. 2024 DESIGNED BY: KAU DRAWN BY: EGB CHECKED BY: KAM


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SHEET 046





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**TUSCALOOSA, AL TUSCALOOSA, AL MUSCALOOSA, AL MULLIARD N. FLETCHER WATER RESOURCE RECOVERY FACILIARD

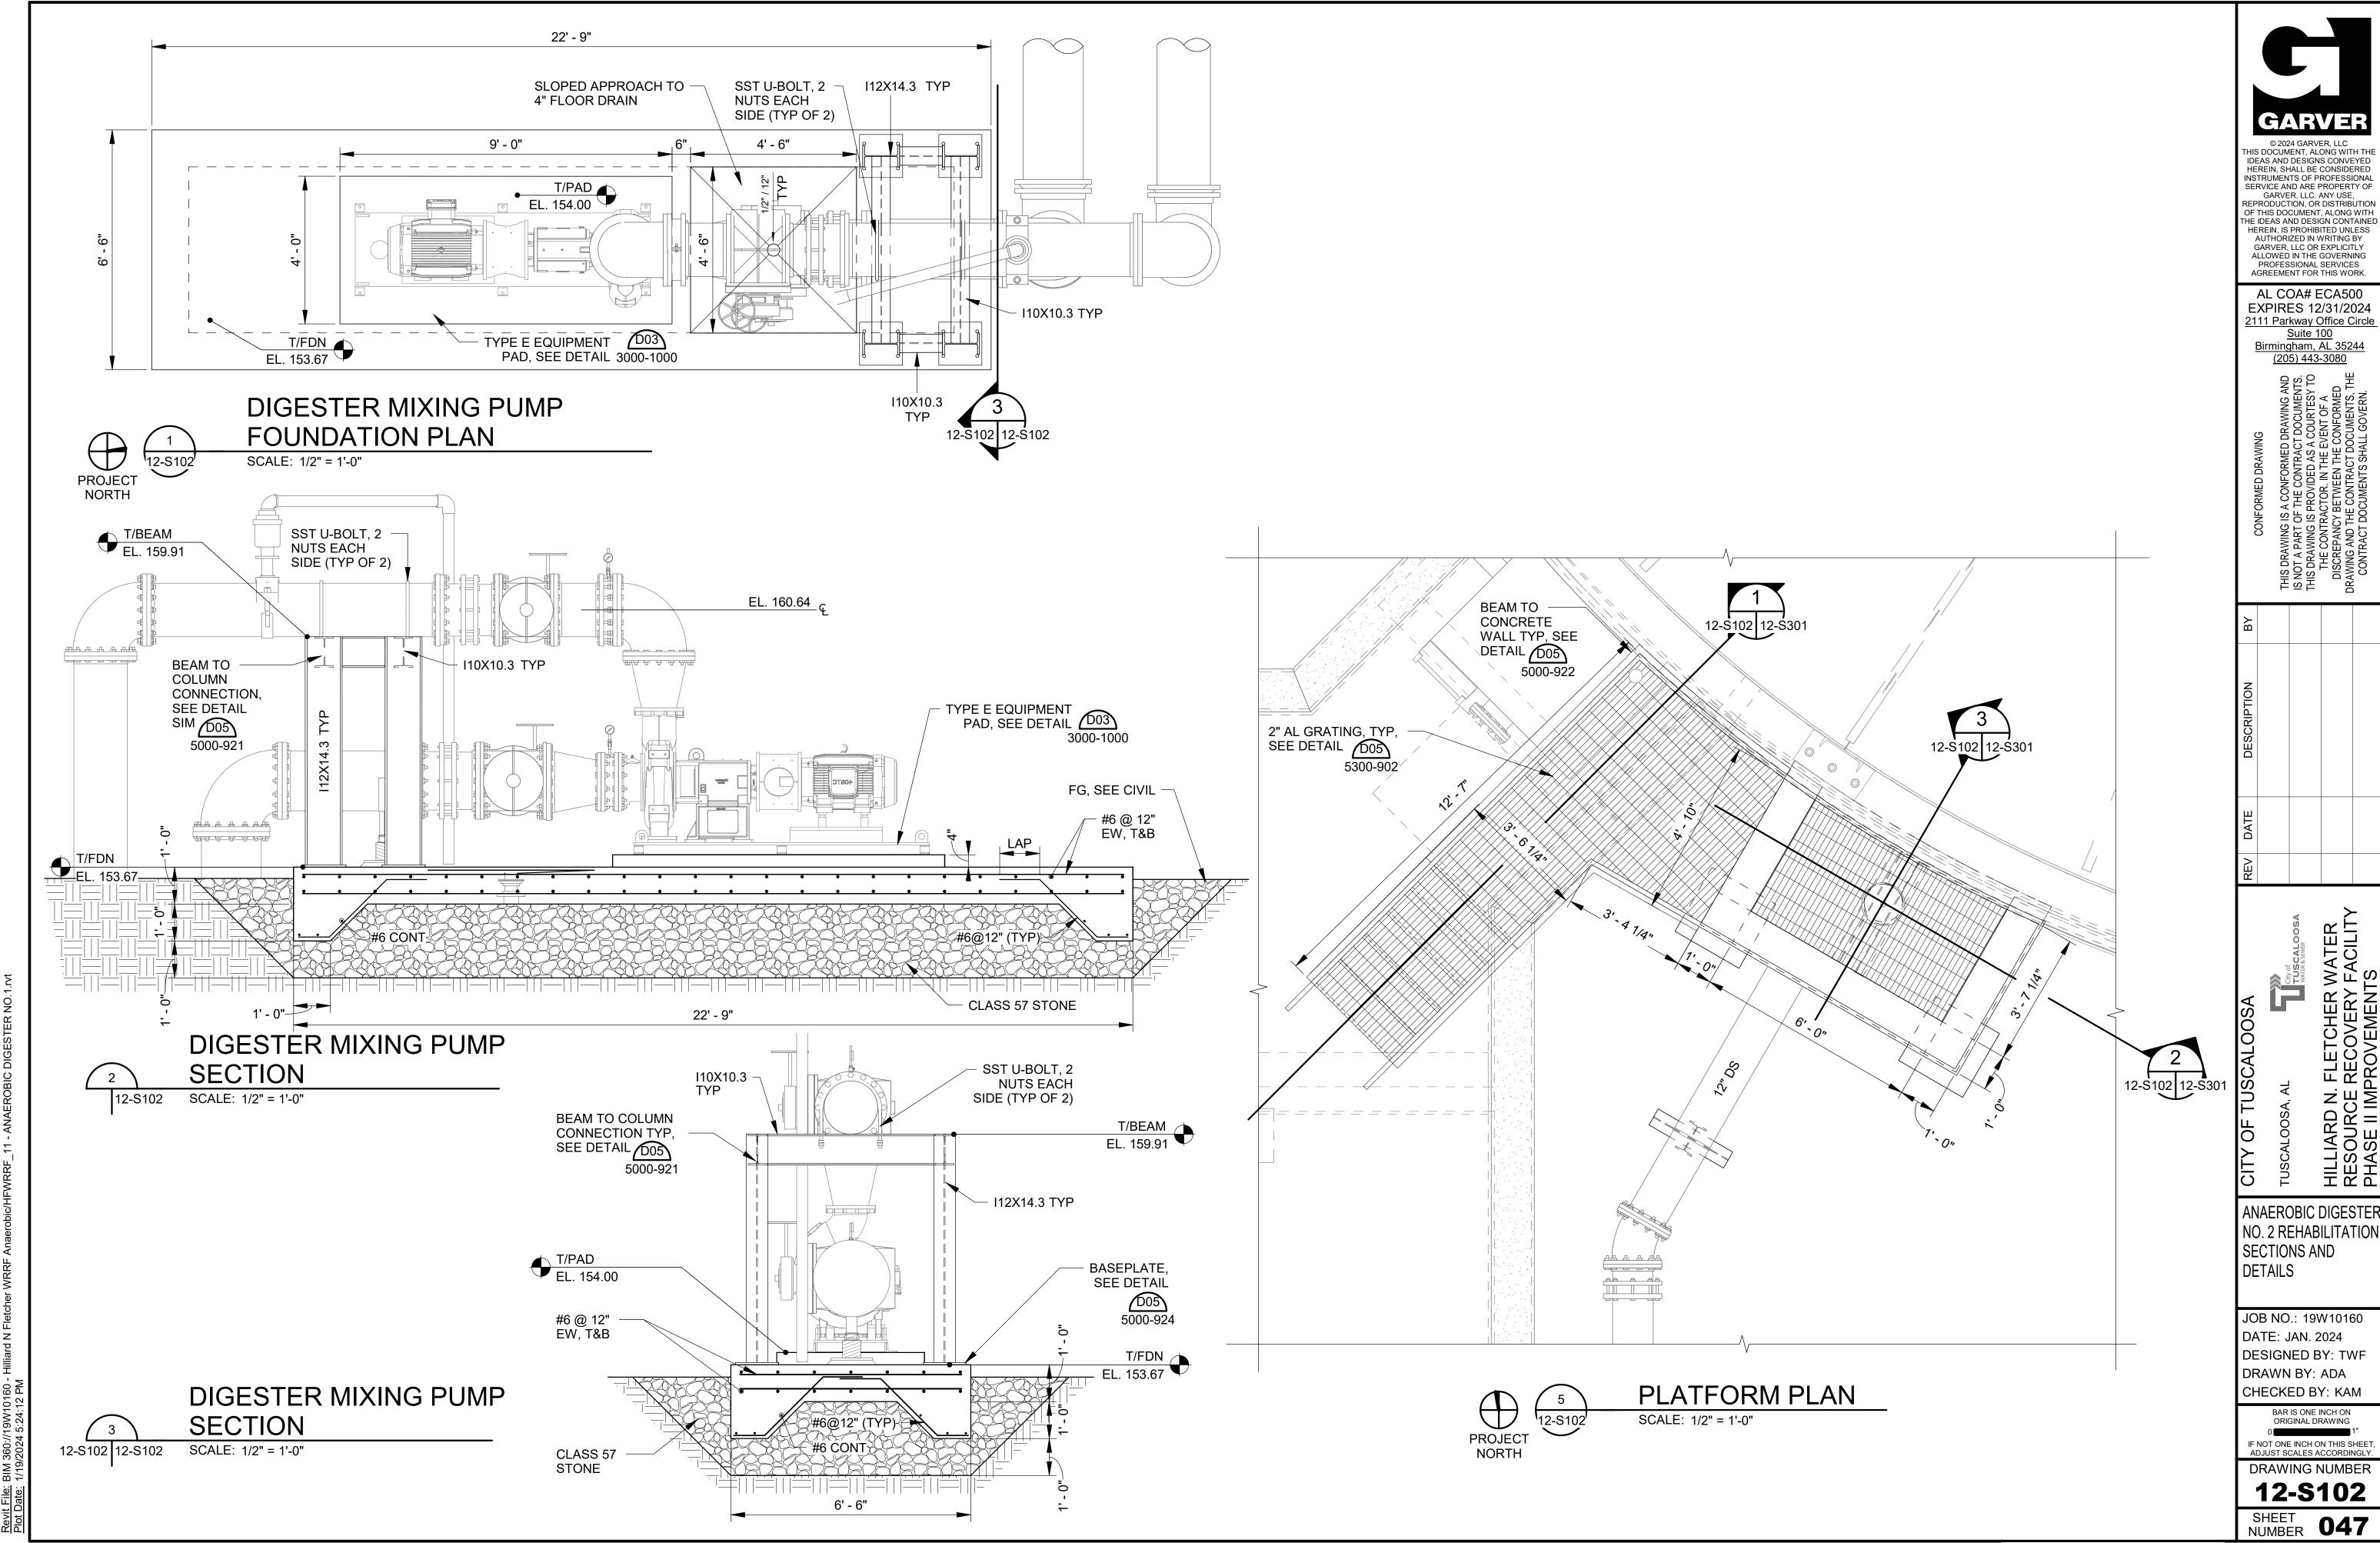ANAEROBIC DIGESTER NO. 2 REHABILITATION SECTIONS

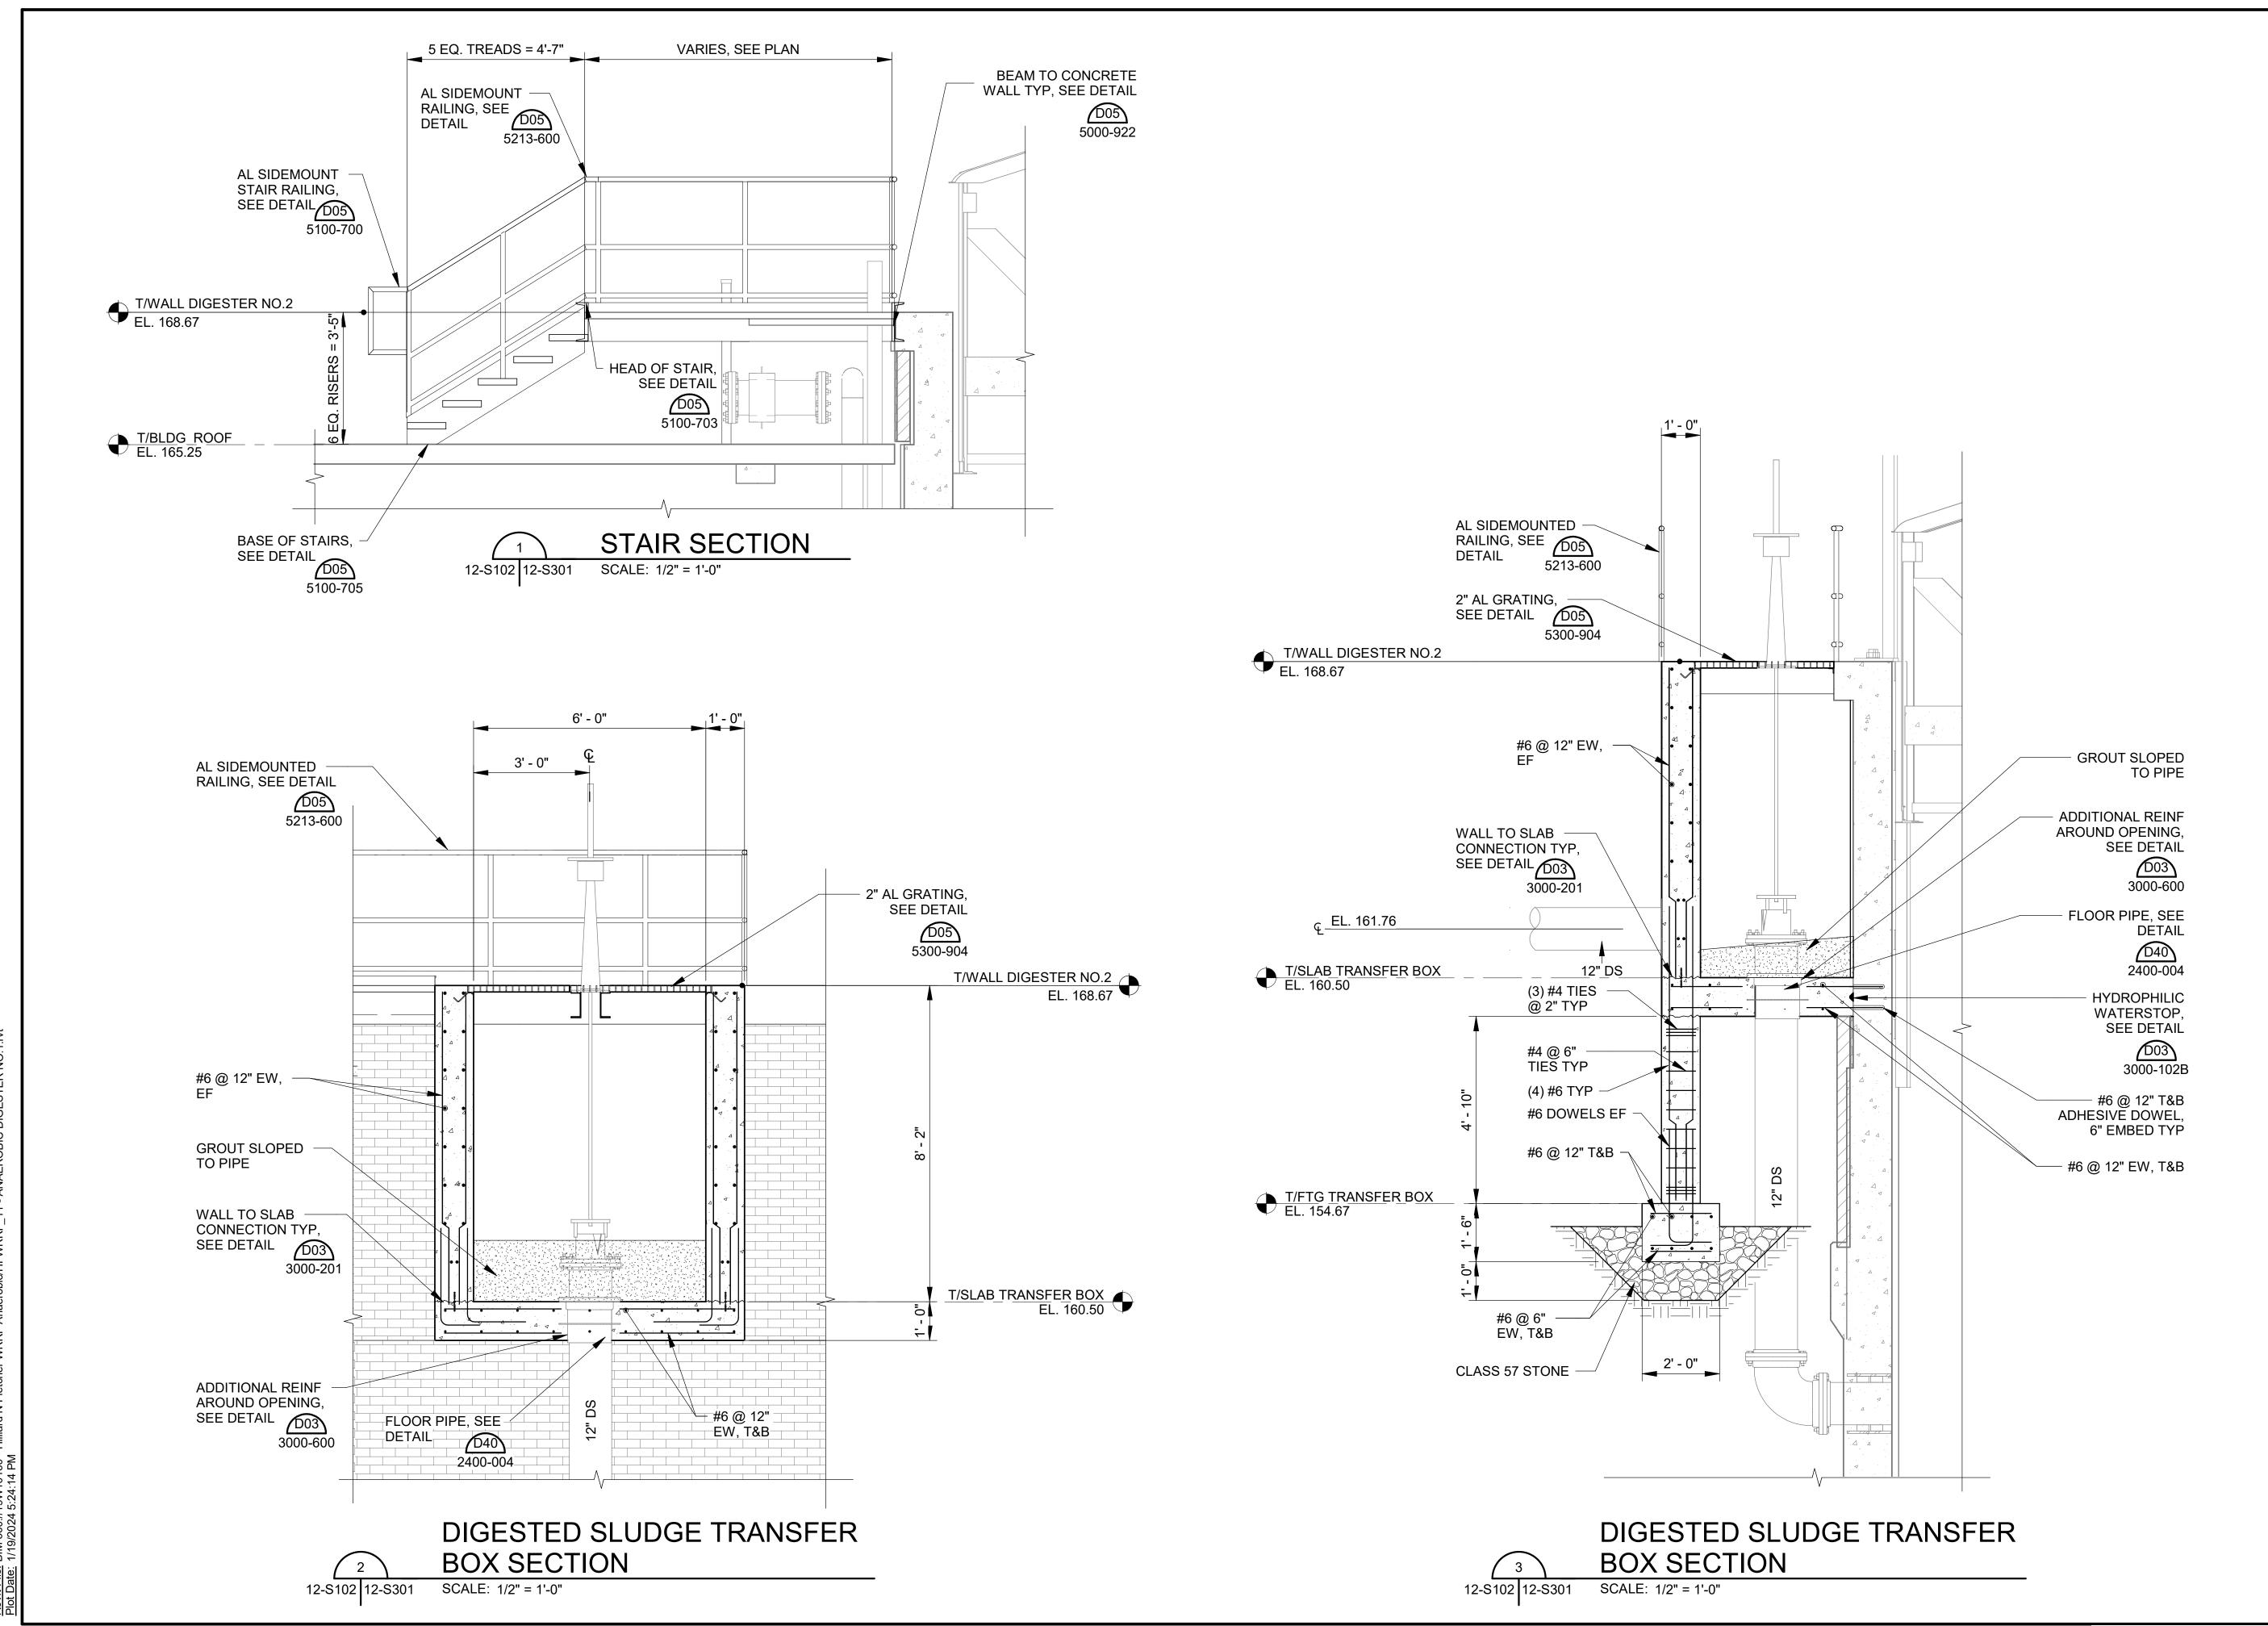JOB NO.: 19W10160 DATE: JAN. 2024 DESIGNED BY: TWF DRAWN BY: ADA CHECKED BY: KAM

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SHEET 048



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CALOOSA, AL
CALOOSA, AL
LIARD N. FLETCHER WATE

ANAEROBIC DIGESTER PIPE SUPPORT NO. 2 REHABILITATION DETAIL AND SECTION

JOB NO.: 19W10160 DATE: JAN. 2024 DESIGNED BY: TWF DRAWN BY: GBA CHECKED BY: KAM


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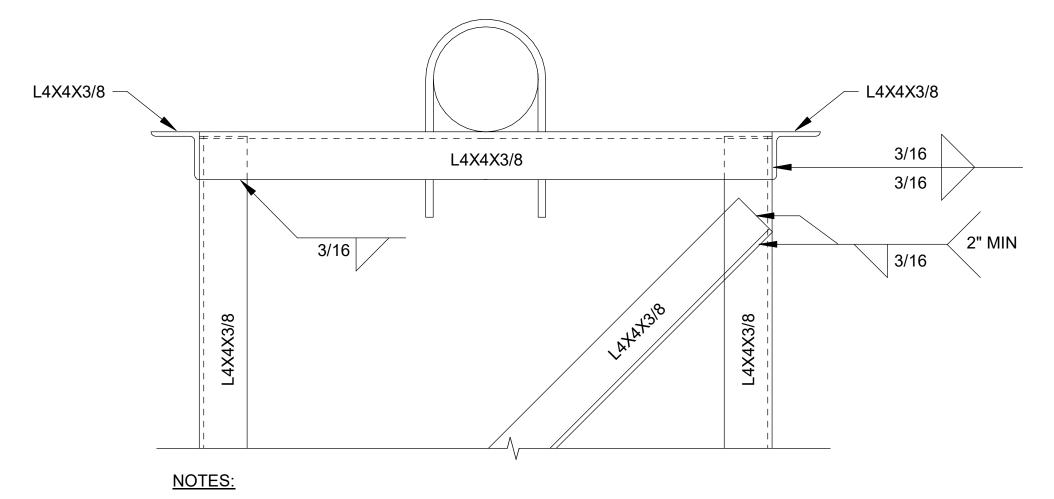
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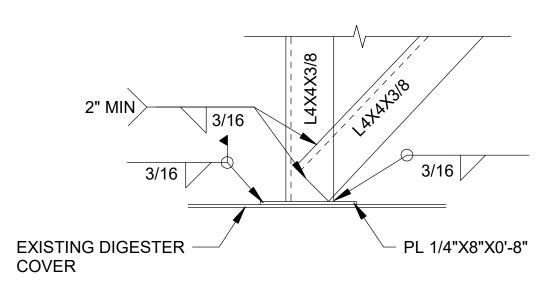
12-S501
SHEET 049





1. AFTER INSTALLATION, APPLY COLD GALVANIZING COMPOUND TO ANY WELDS OR DAMAGED AREAS




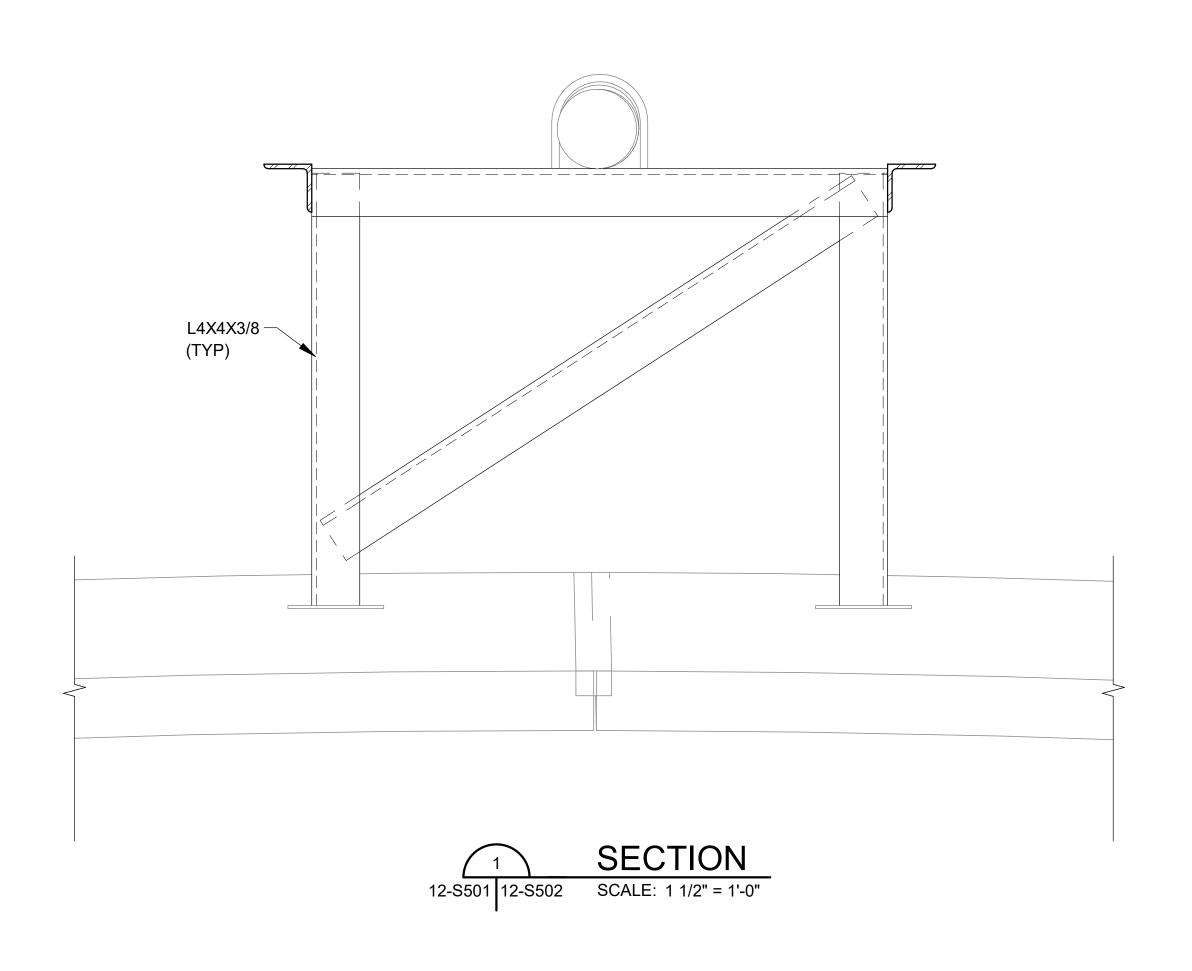

NOTES:

- 1. THOROUGHLY CLEAN EXISTING DIGESTER COVER PRIOR TO WELDING
- 2. AFTER INSTALLATION, APPLY COLD GALVANIZING COMPOUND TO ANY WELDS OR DAMAGED AREAS



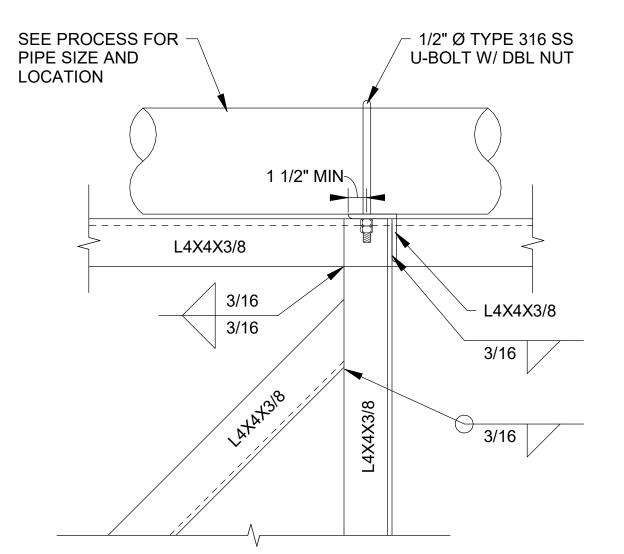

NOTES:

1. AFTER INSTALLATION, APPLY COLD GALVANIZING COMPOUND TO ANY WELDS OR DAMAGED AREAS





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SCALOOSA, AL
LIARD N. FLETCHER


ANAEROBIC DIGESTER PIPE SUPPORT NO. 2 REHABILITATION DETAIL

JOB NO.: 19W10160
DATE: JAN. 2024
DESIGNED BY: TWF
DRAWN BY: GBA
CHECKED BY: KAM

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ILLIARD N. FLETCHER WATE
ESOURCE RECOVERY FACIL

OVERALL ANAEROBIC DIGESTION REHABILITATION PLAN


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DRAWN BY: WTL
CHECKED BY: RDT
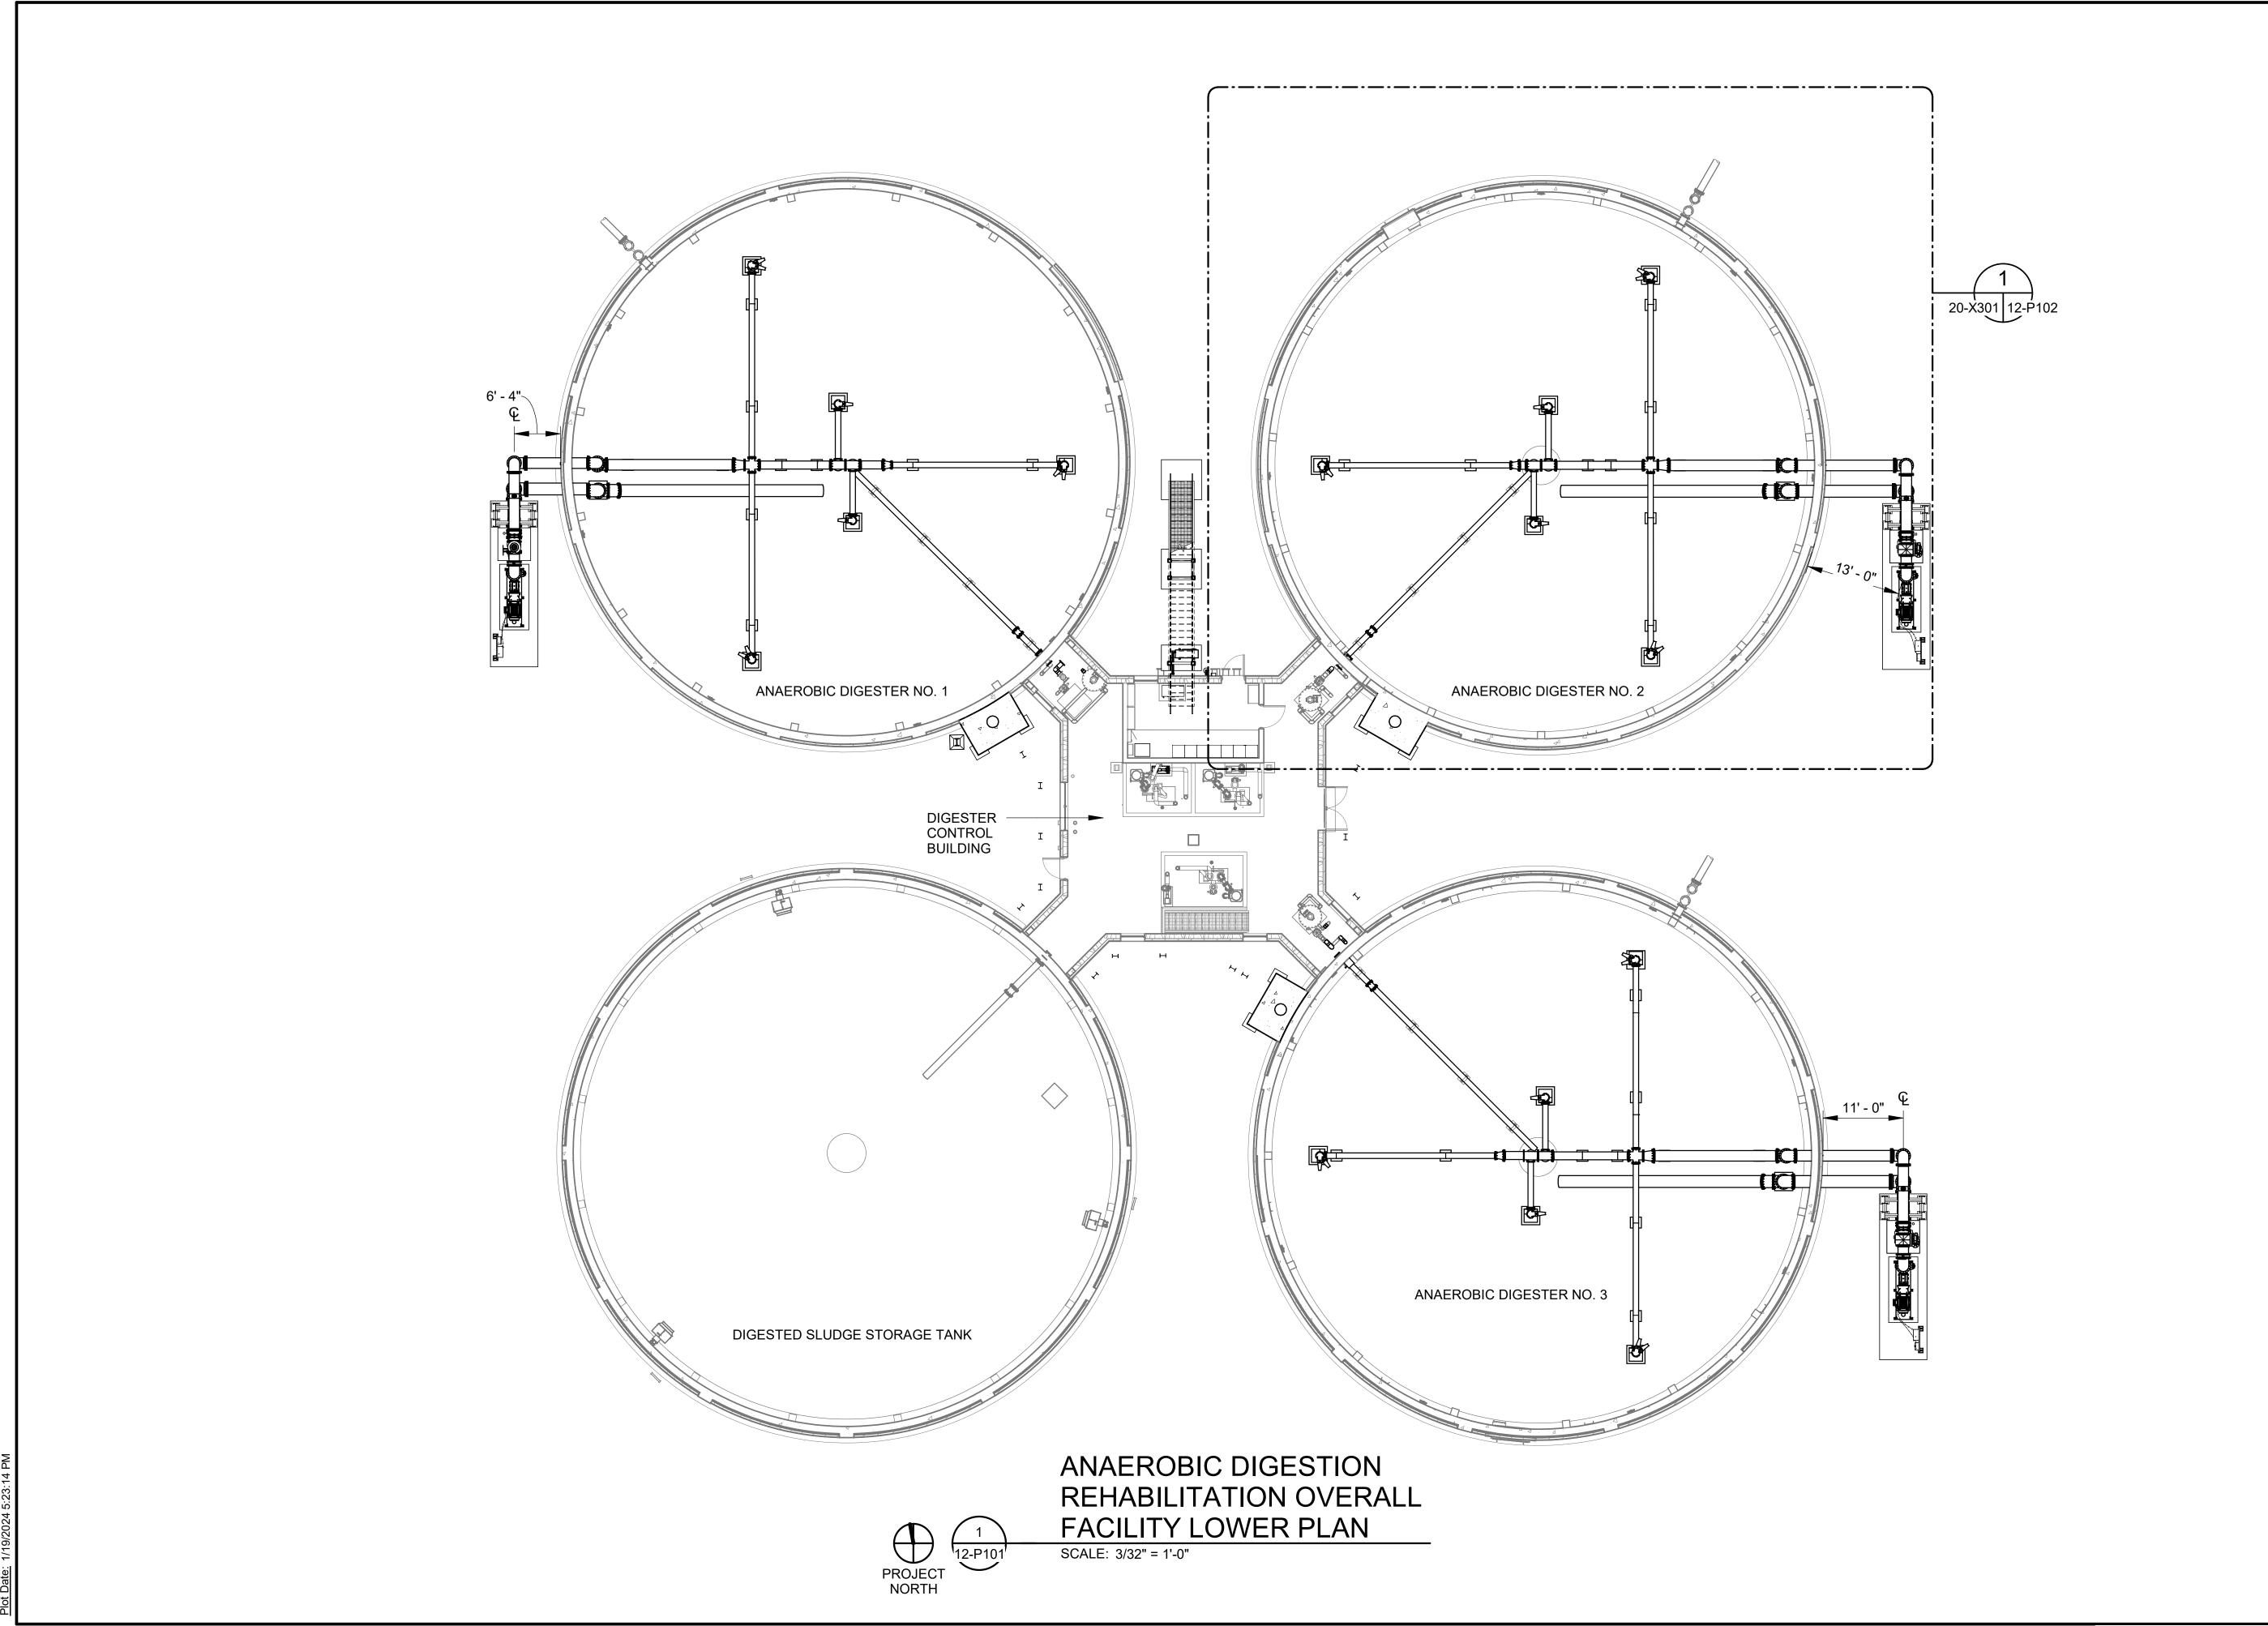
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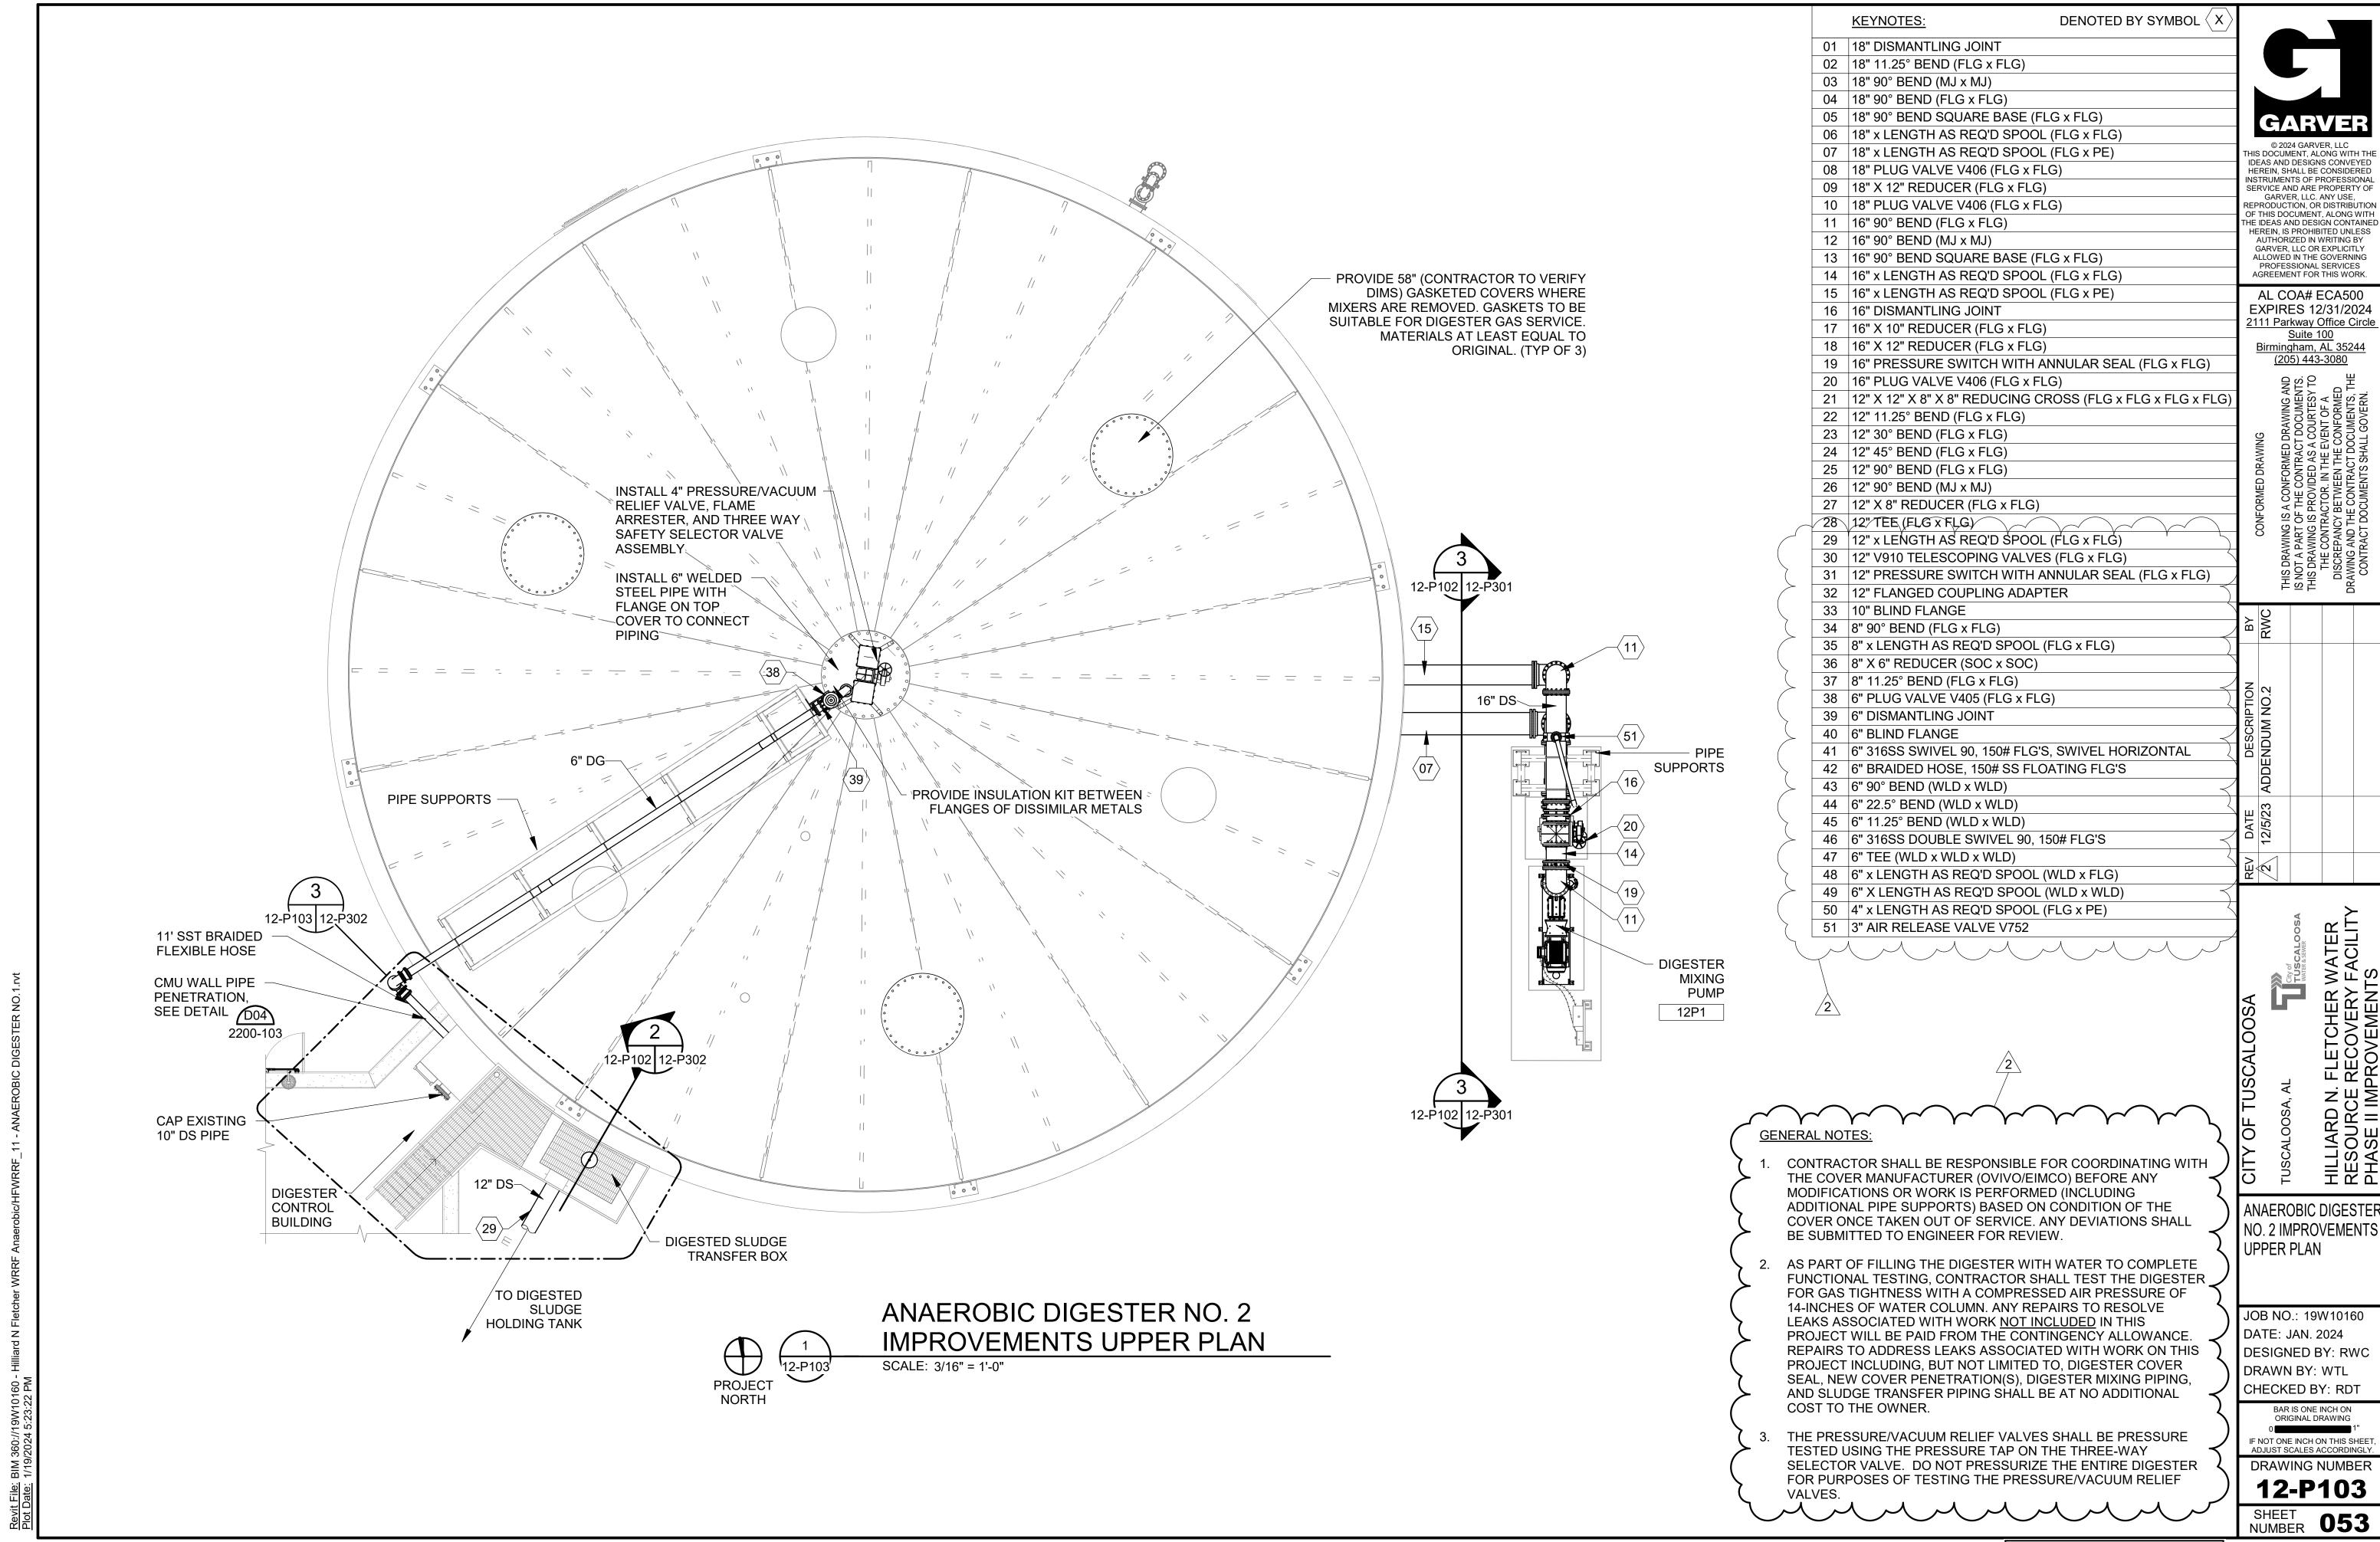
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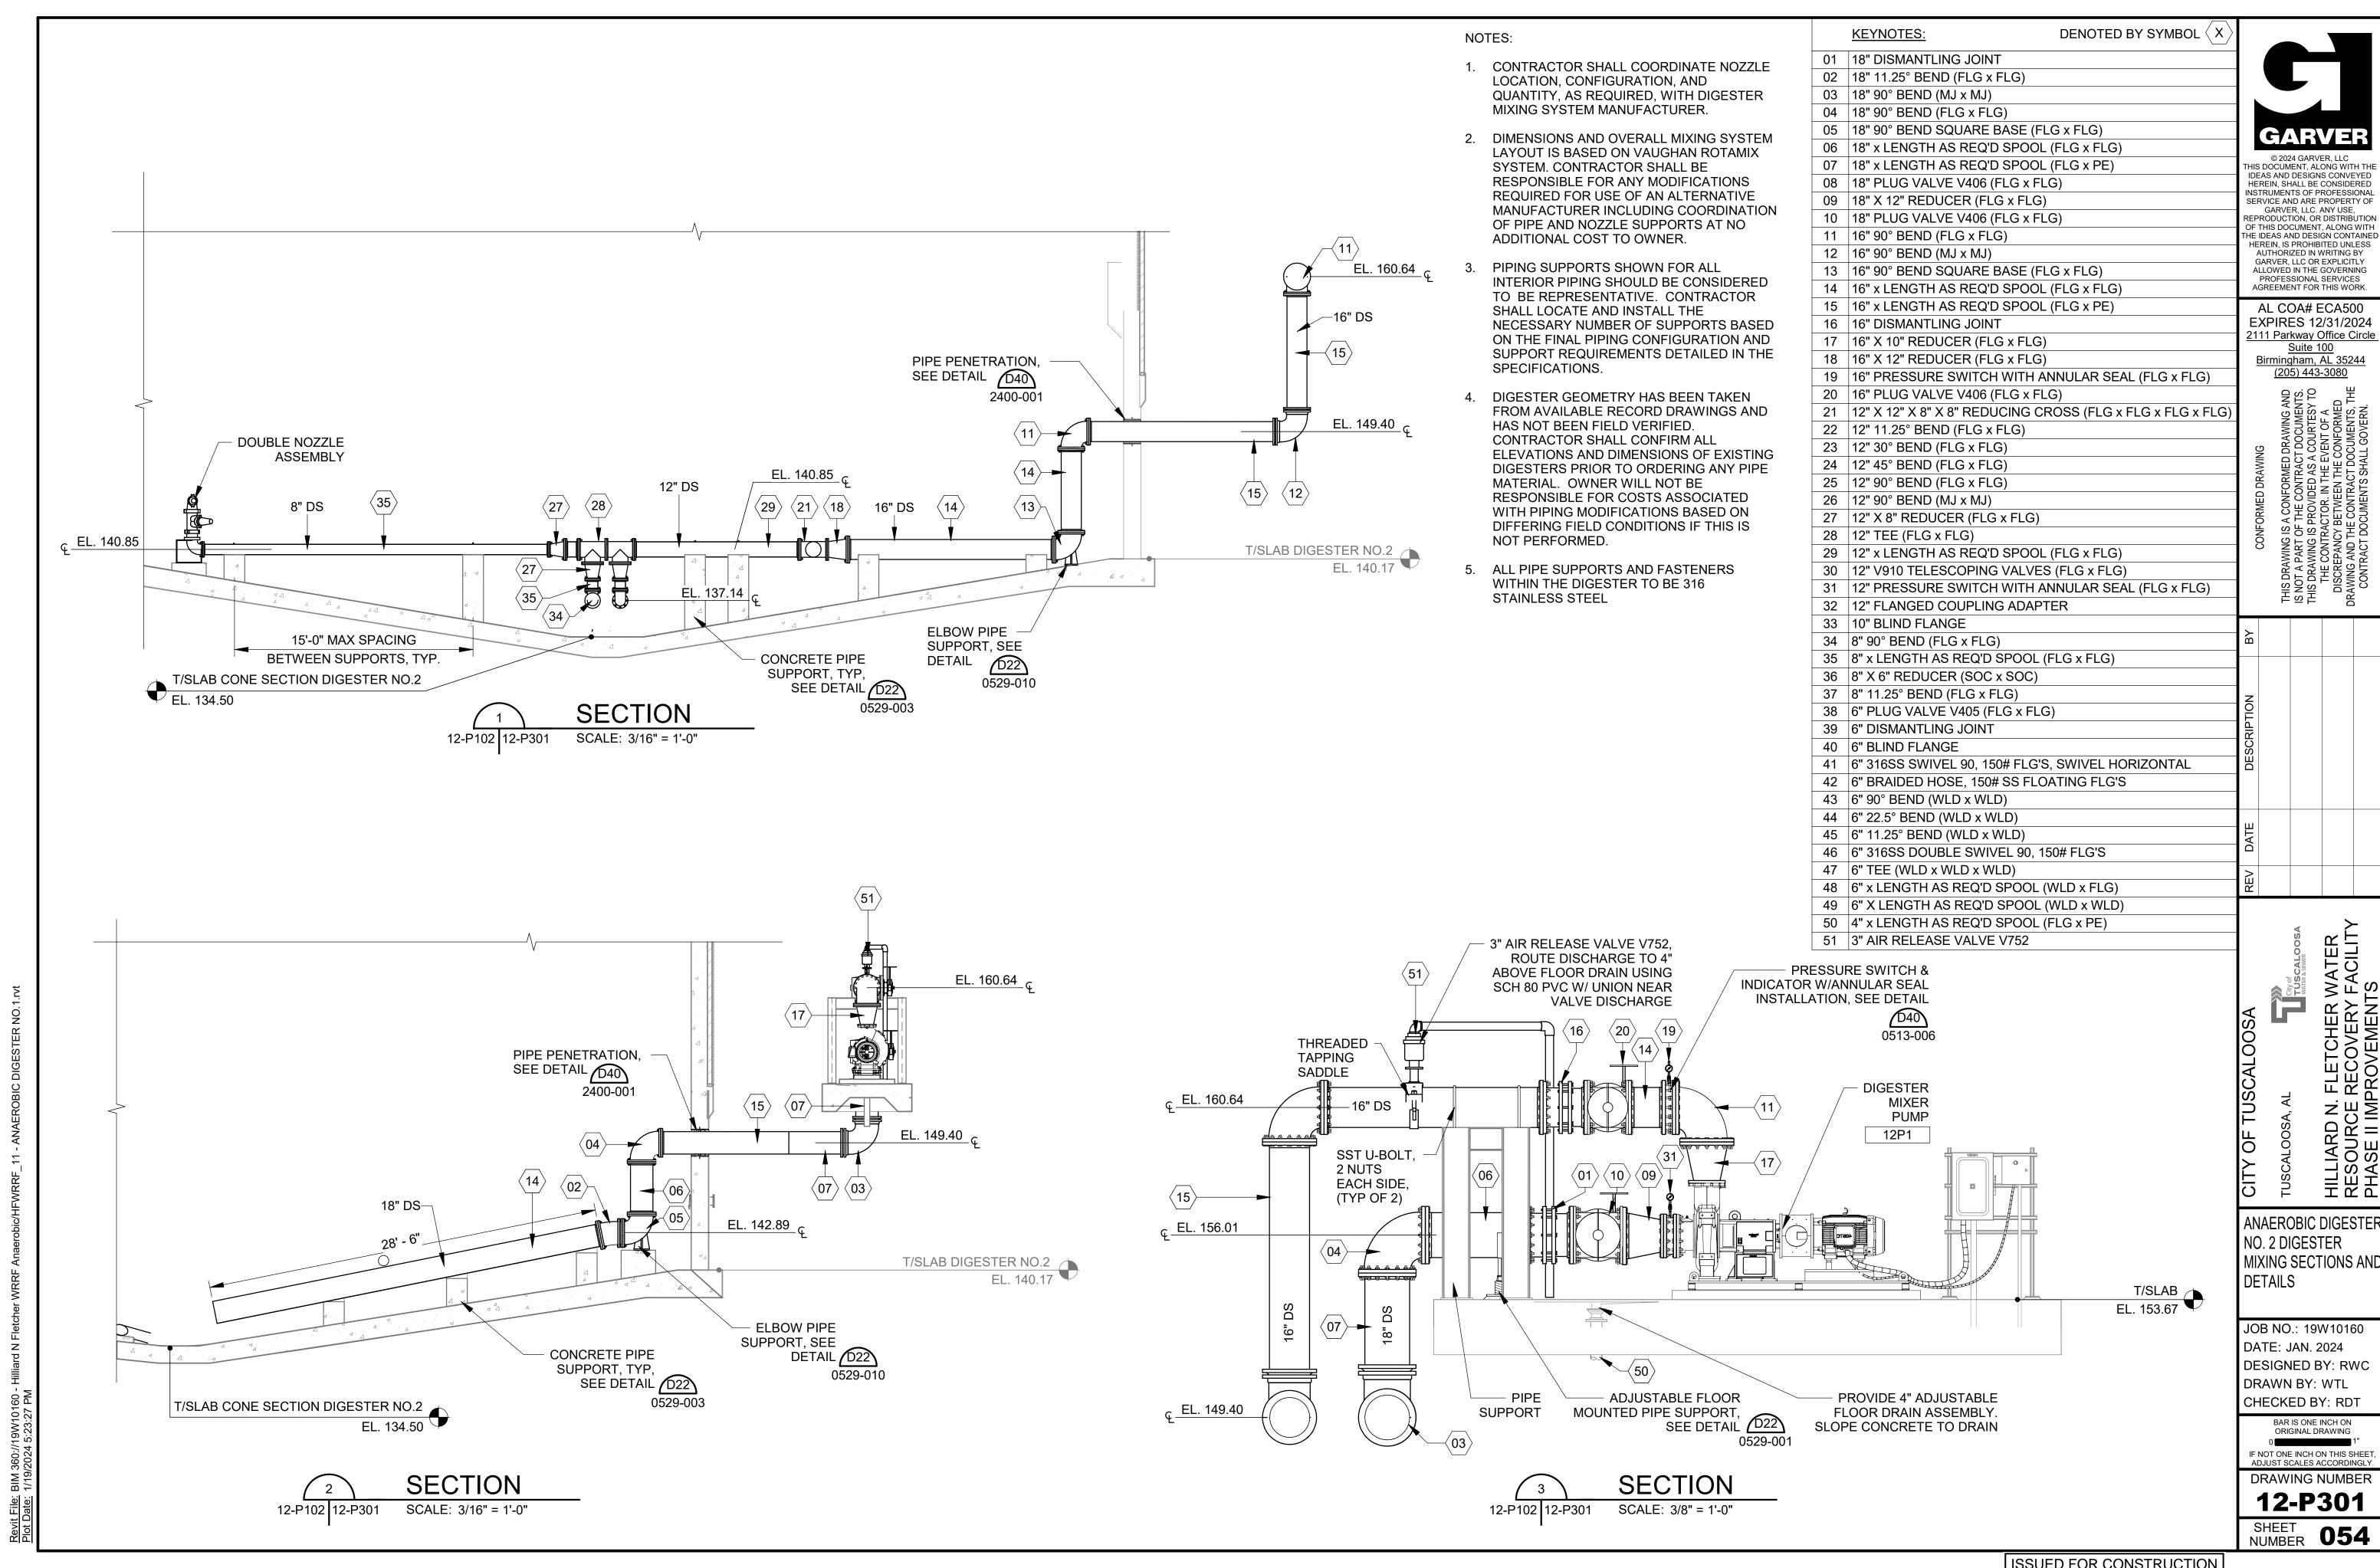
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SHEET NUMBER 051





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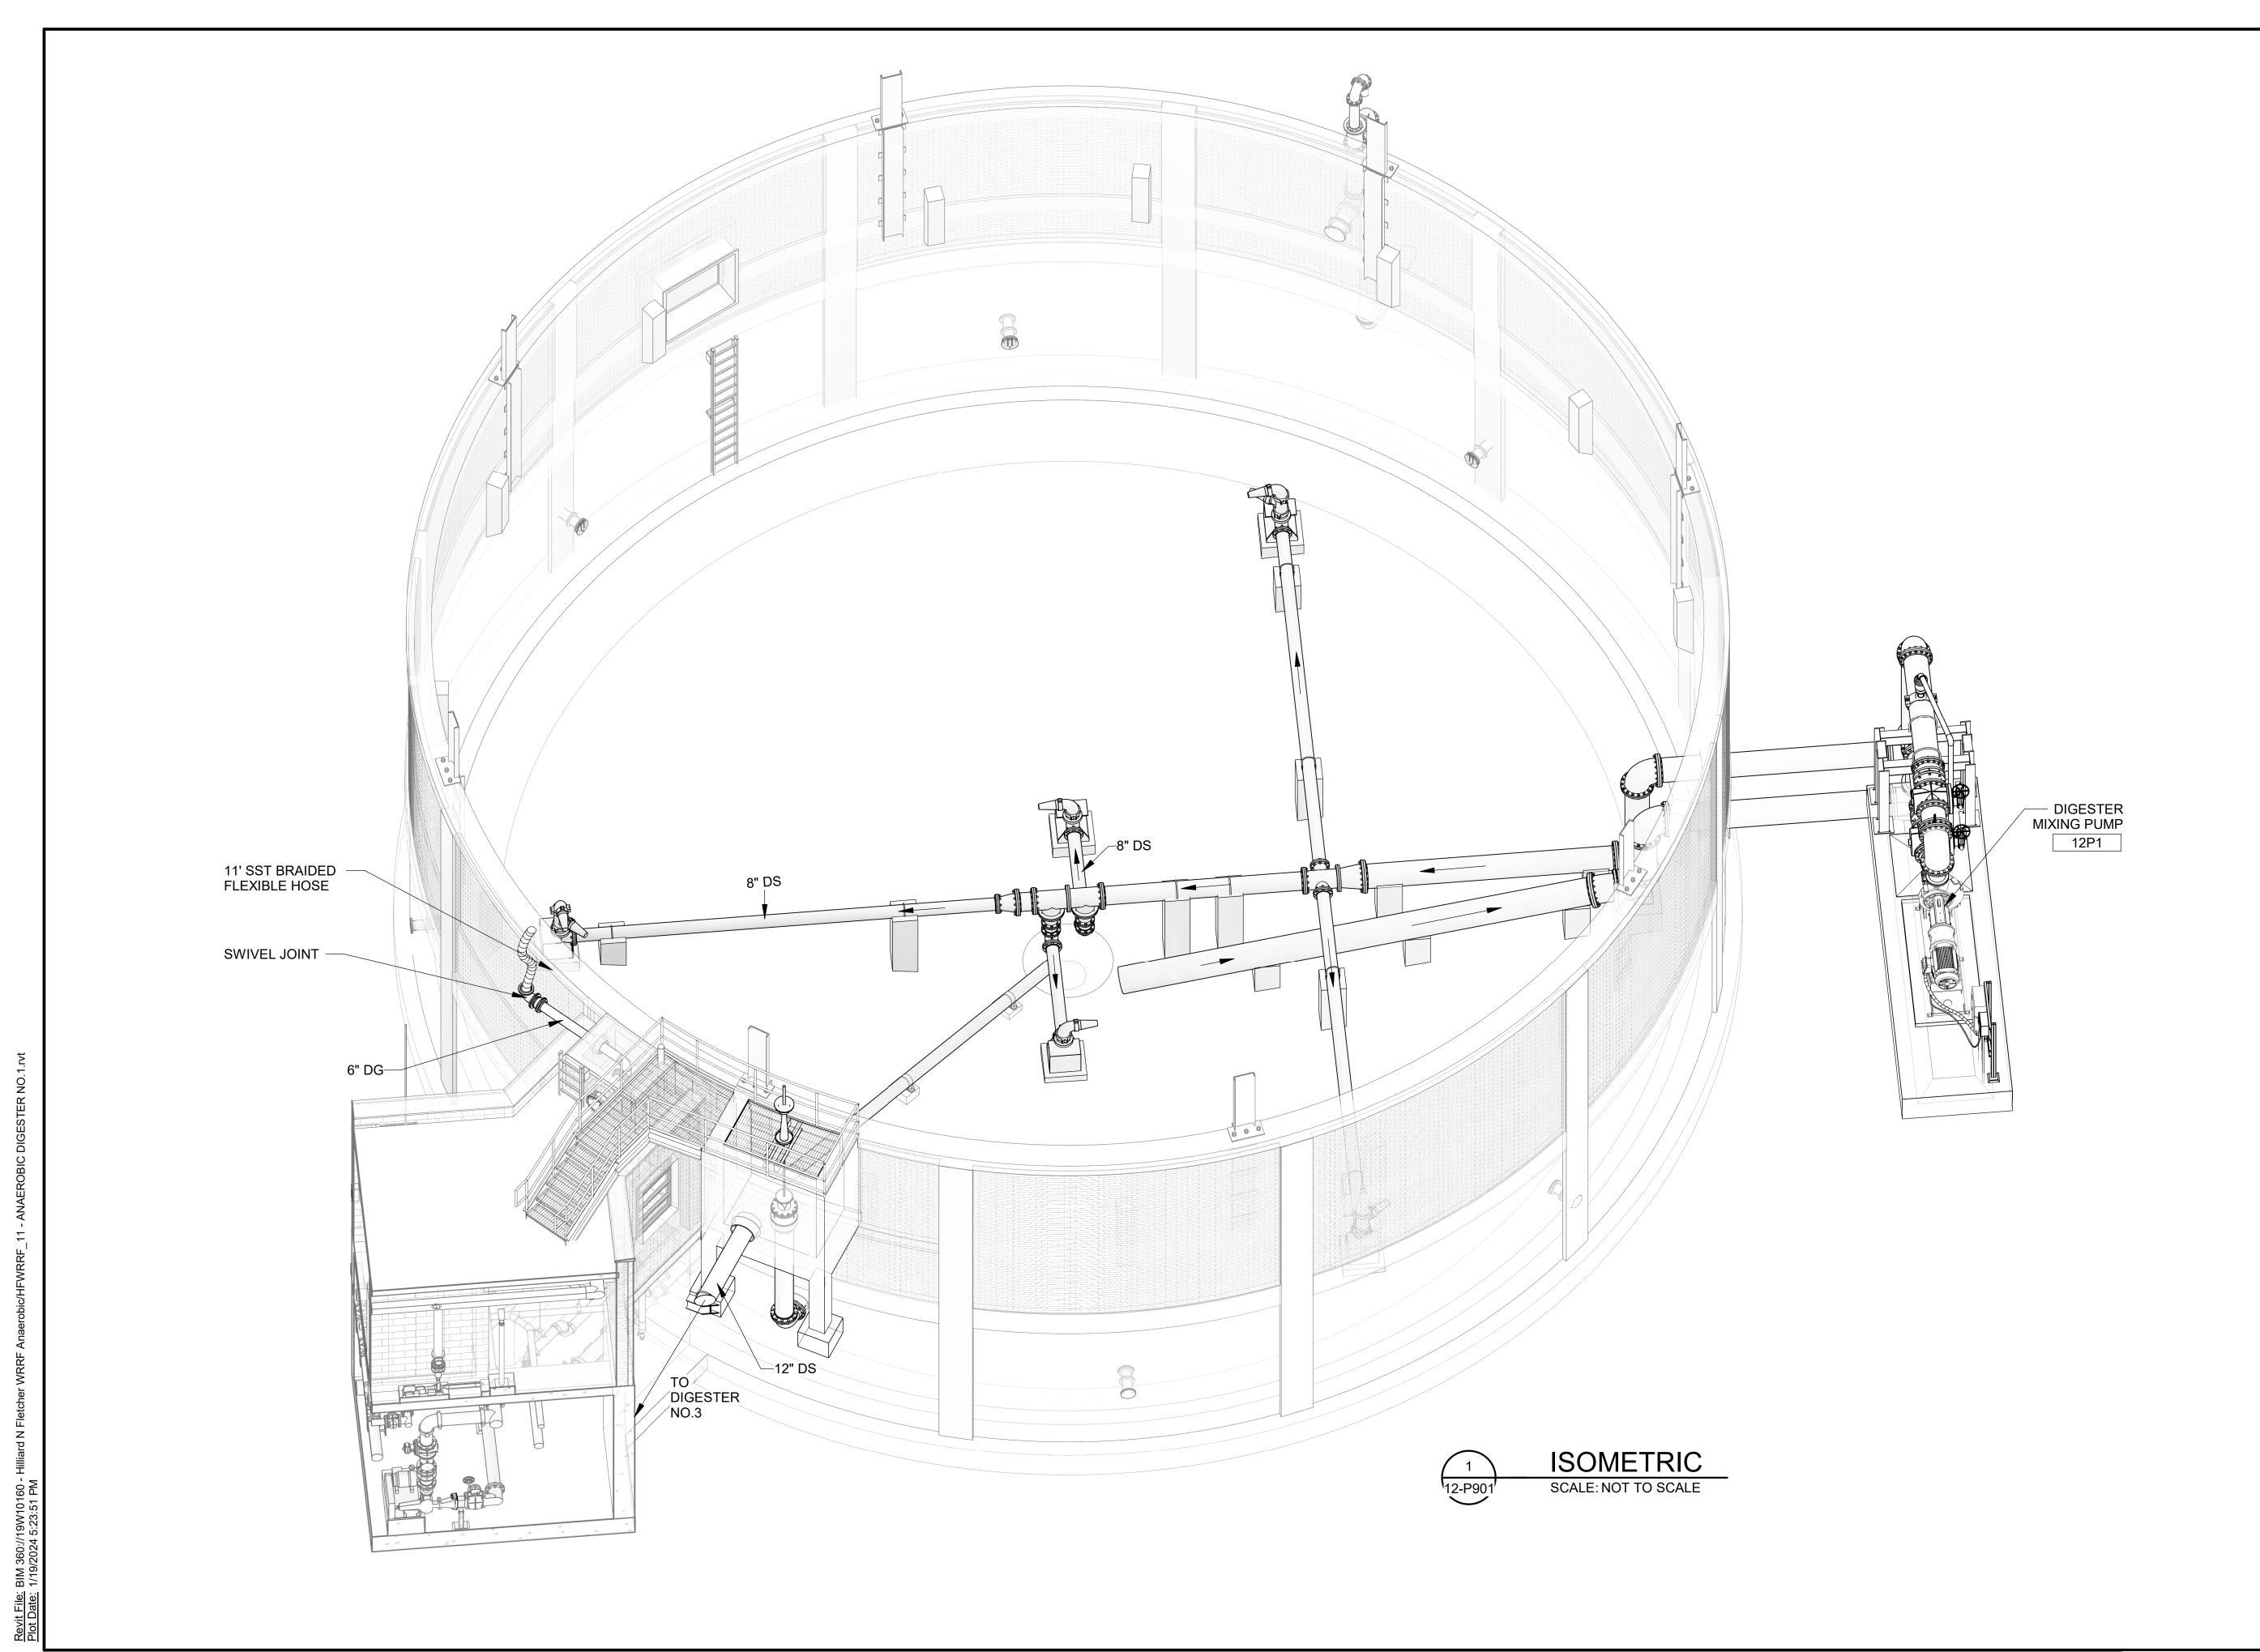




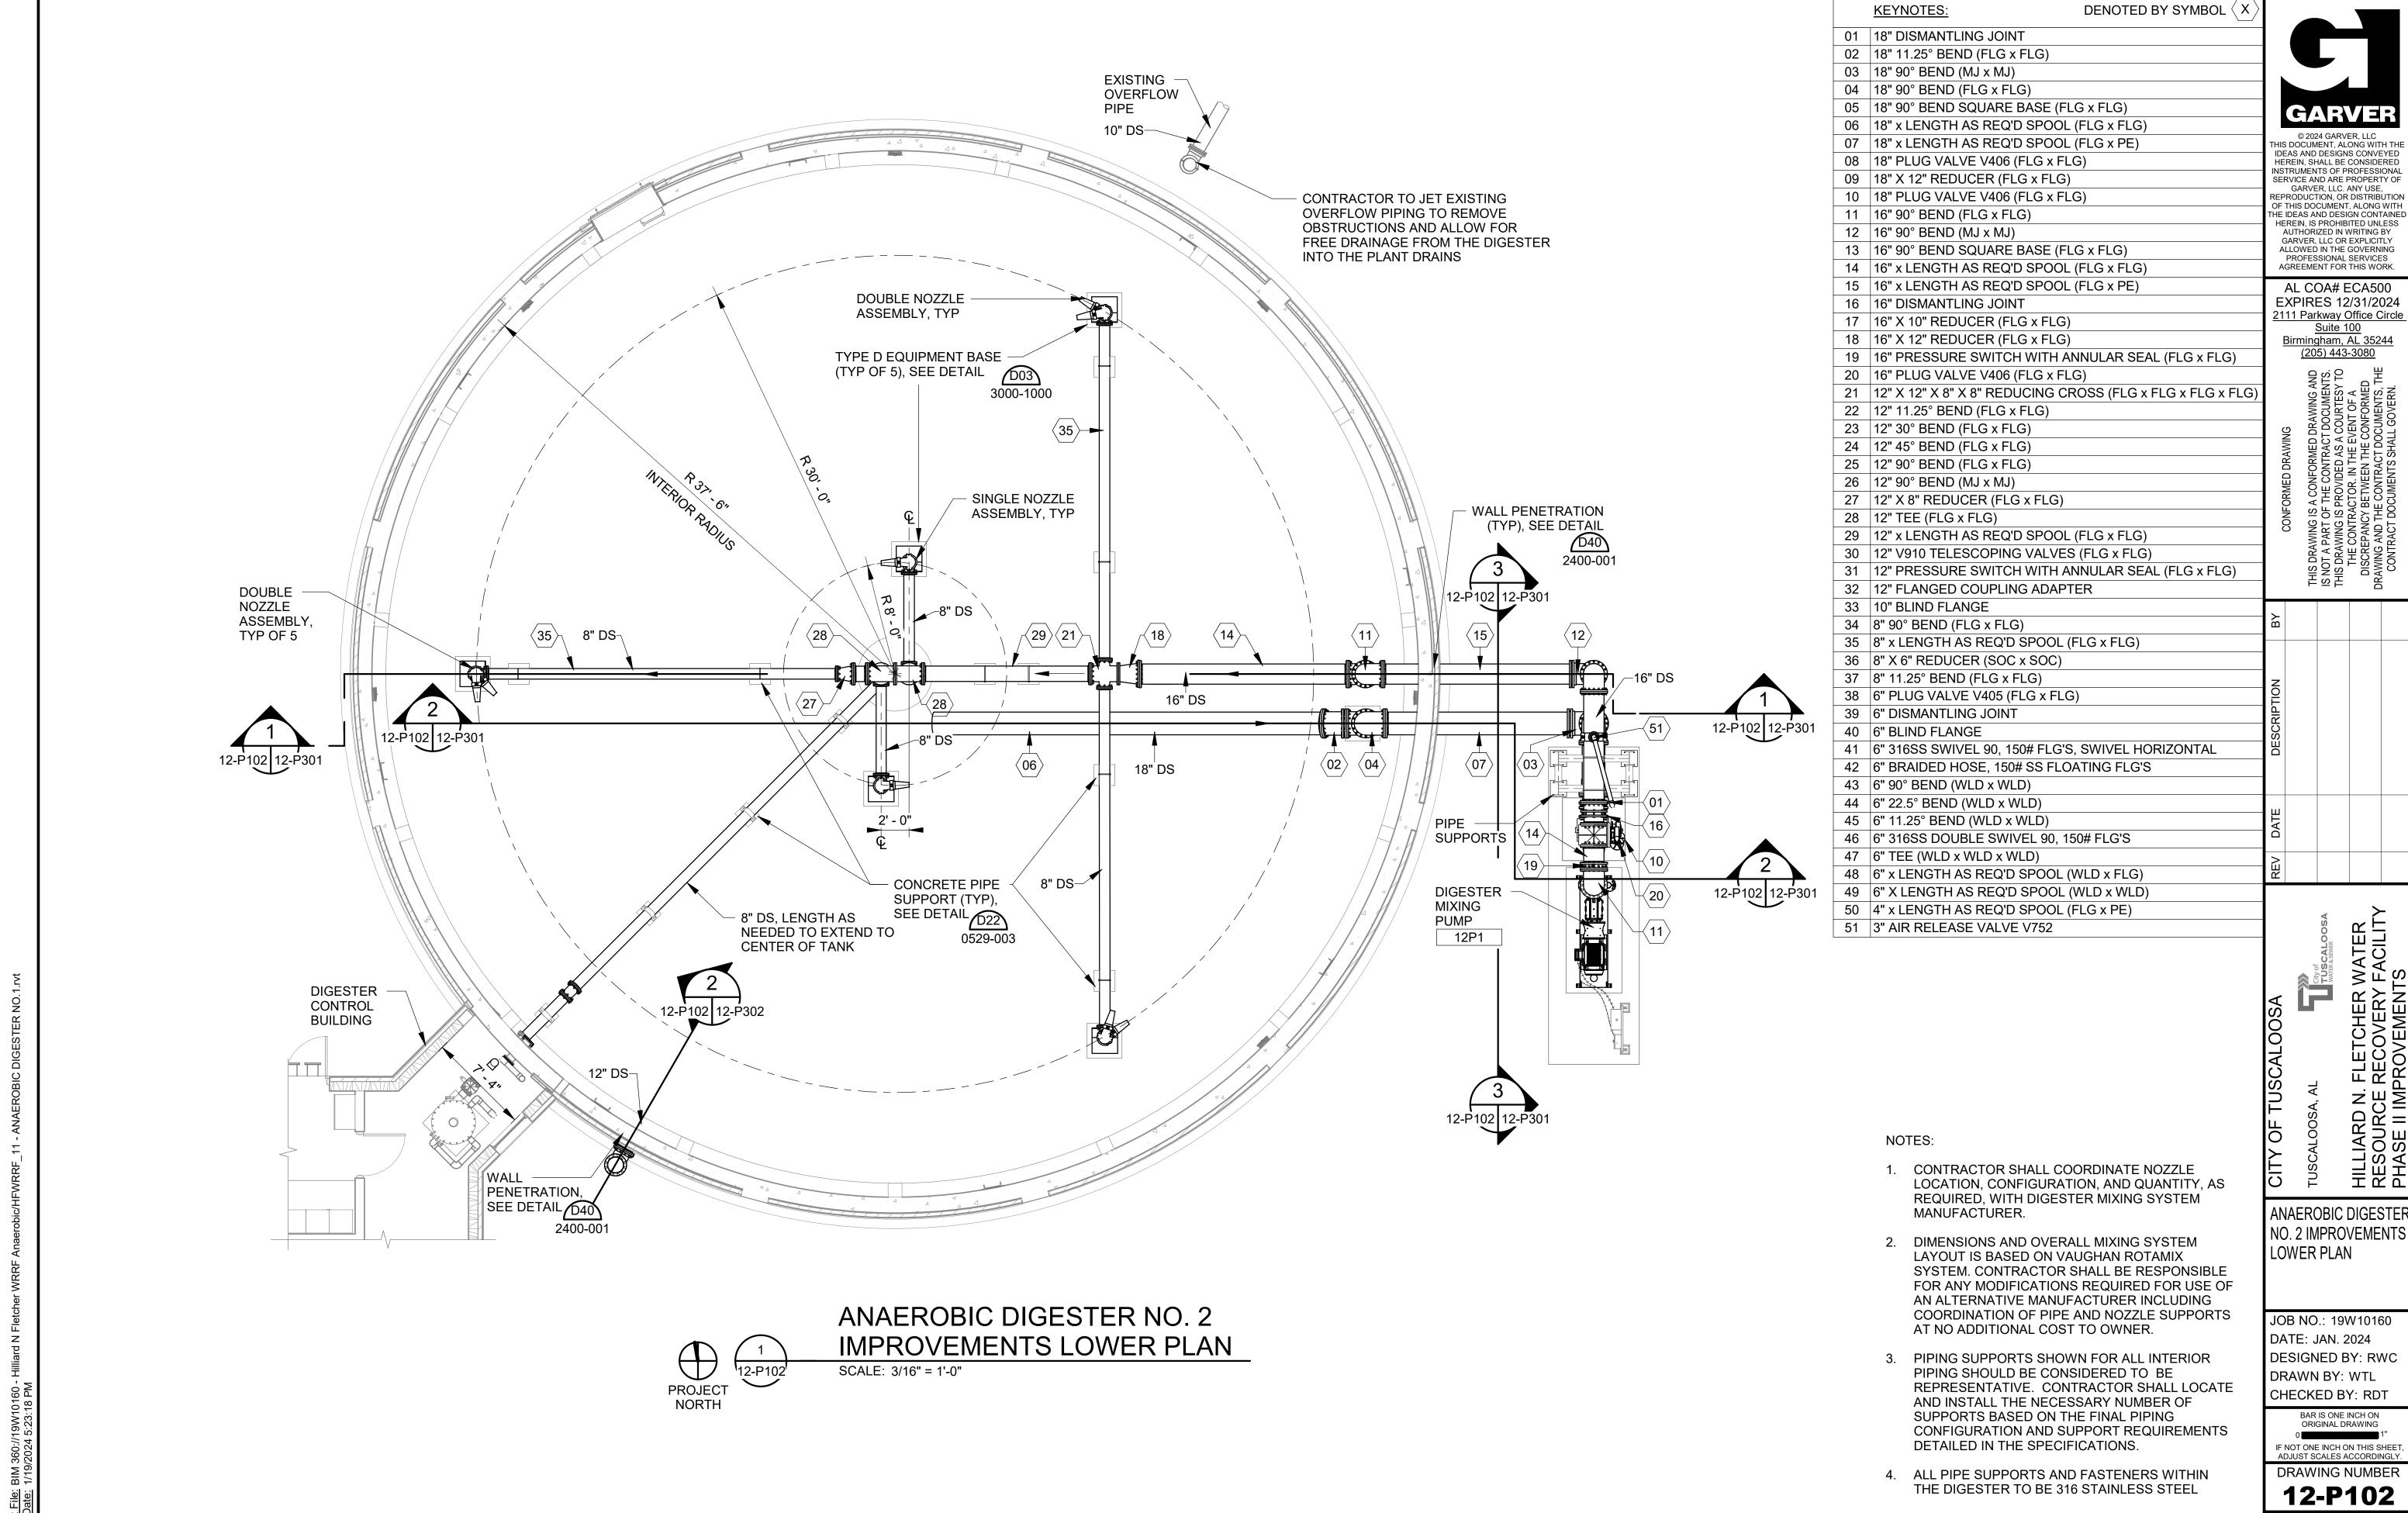

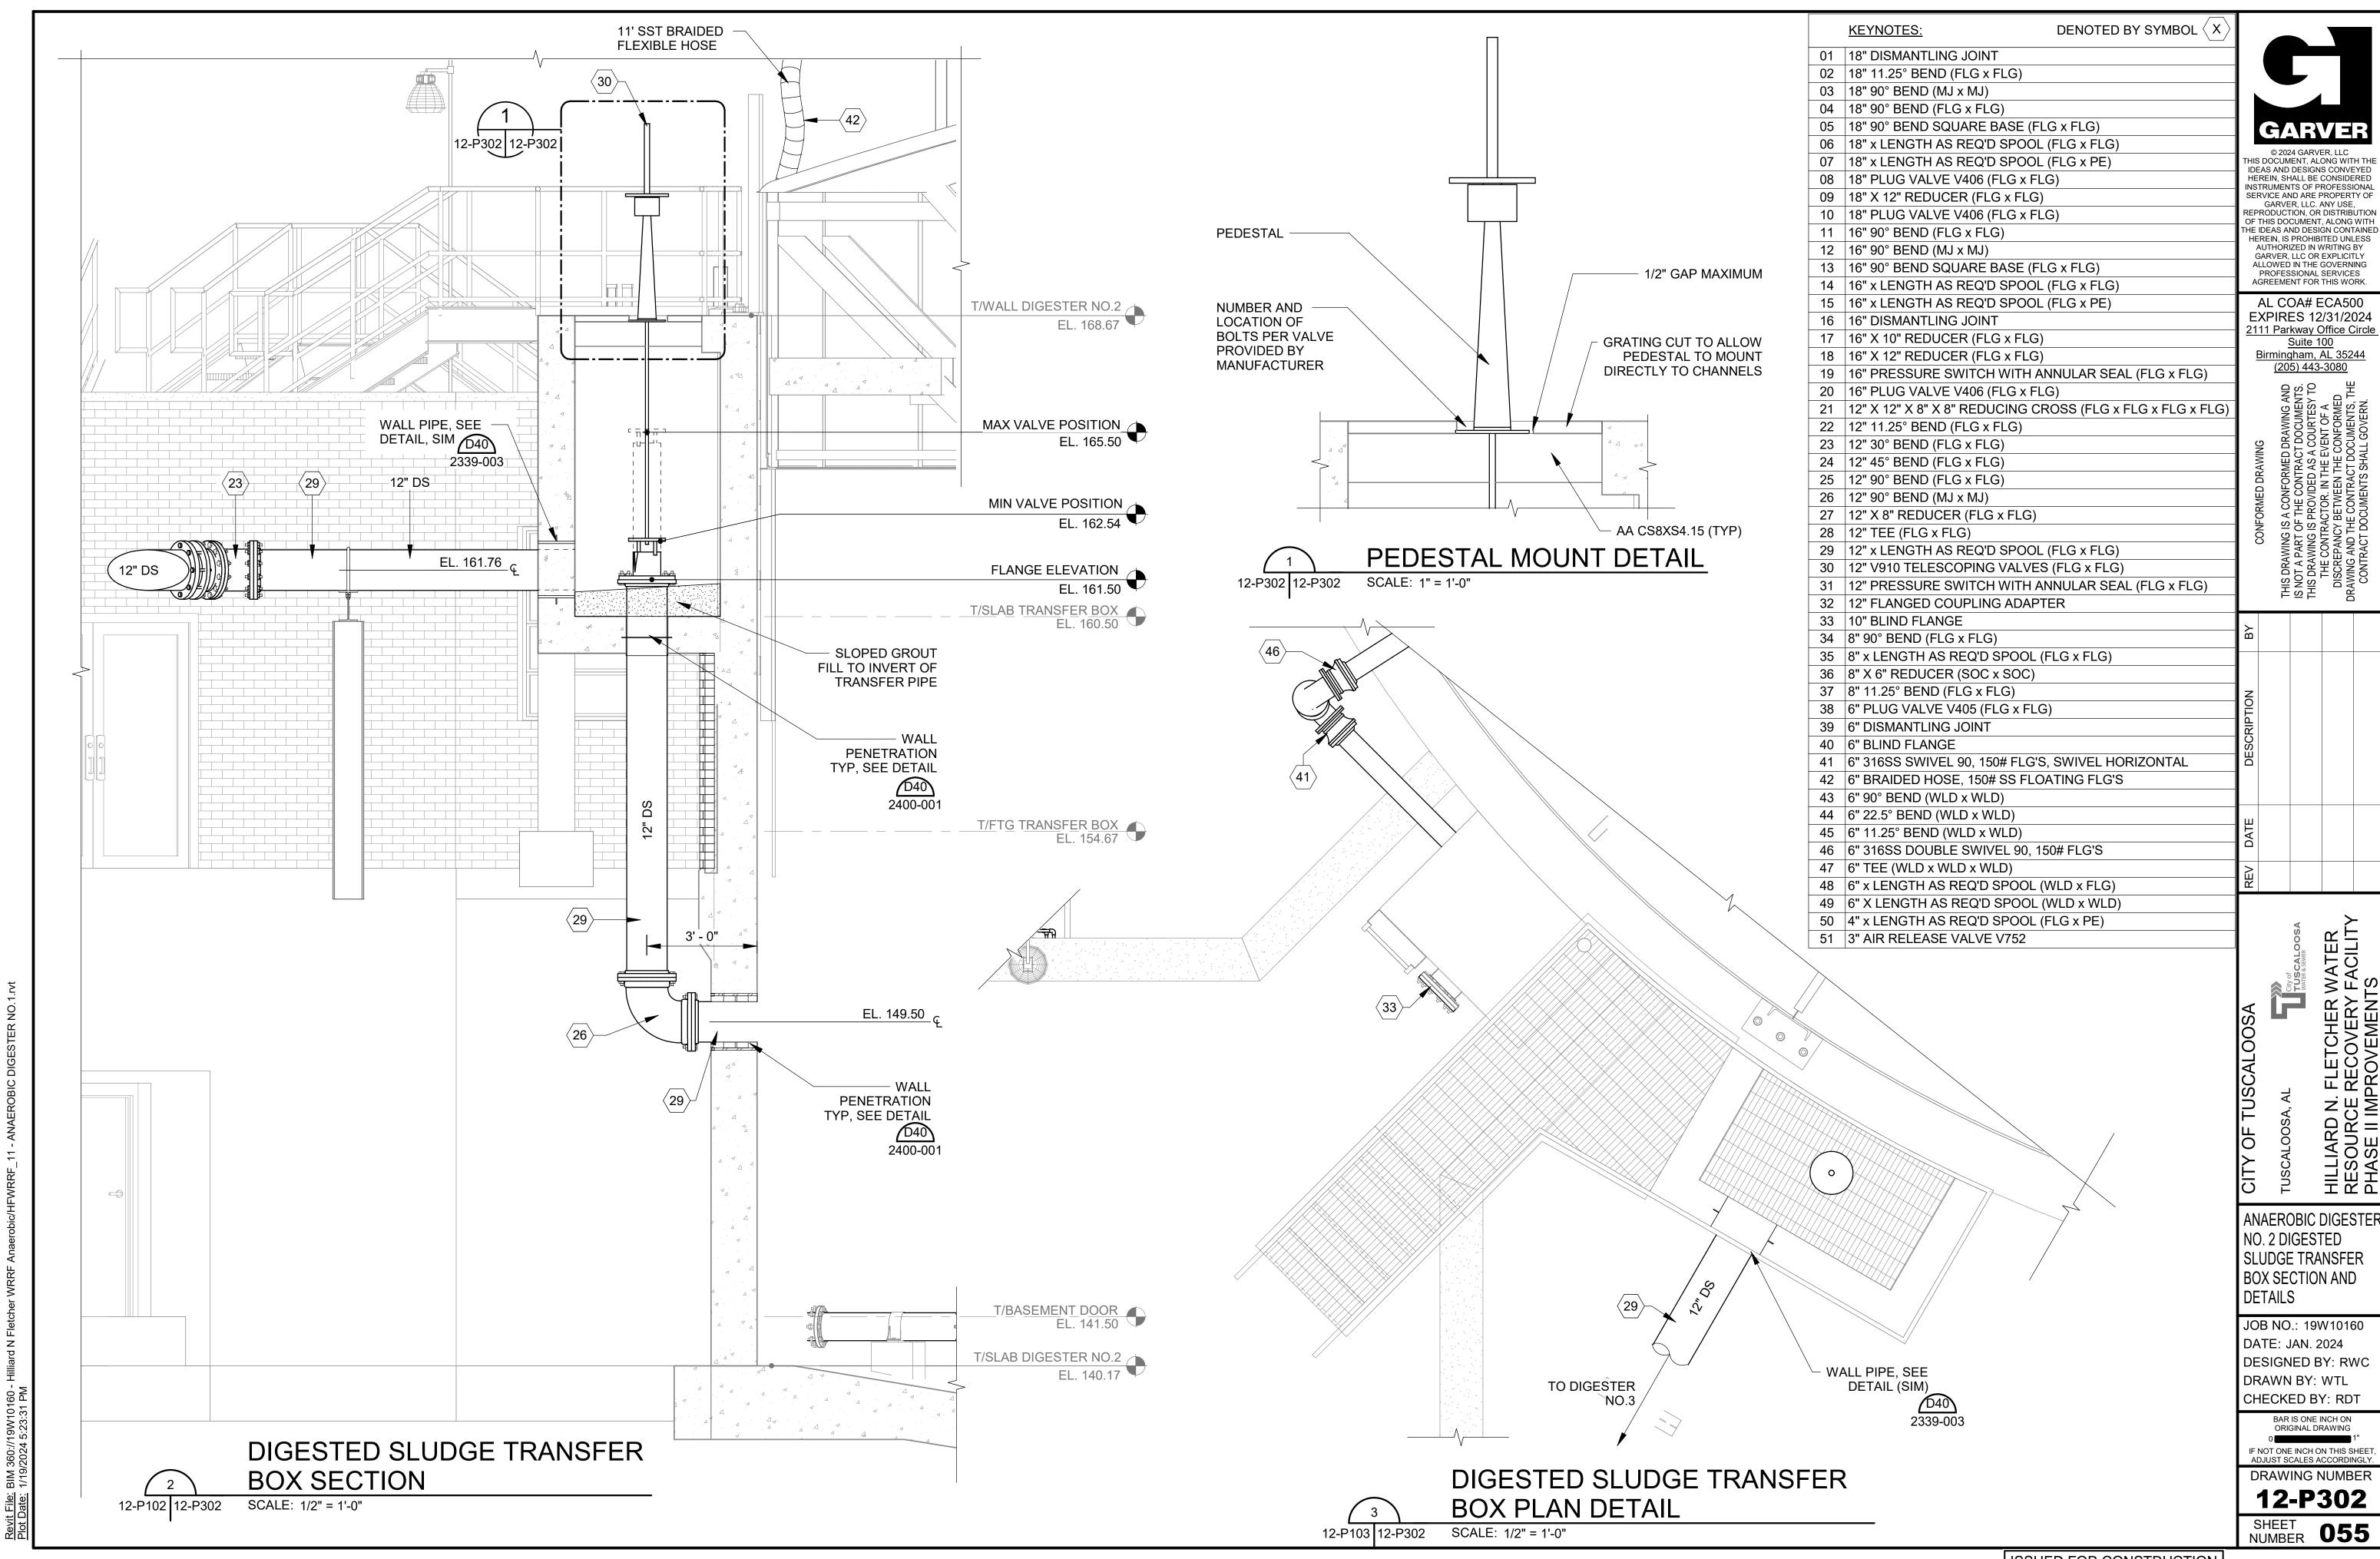

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ANAEROBIC DIGESTER NO. 2 DIGESTER MIXING ISOMETRICS

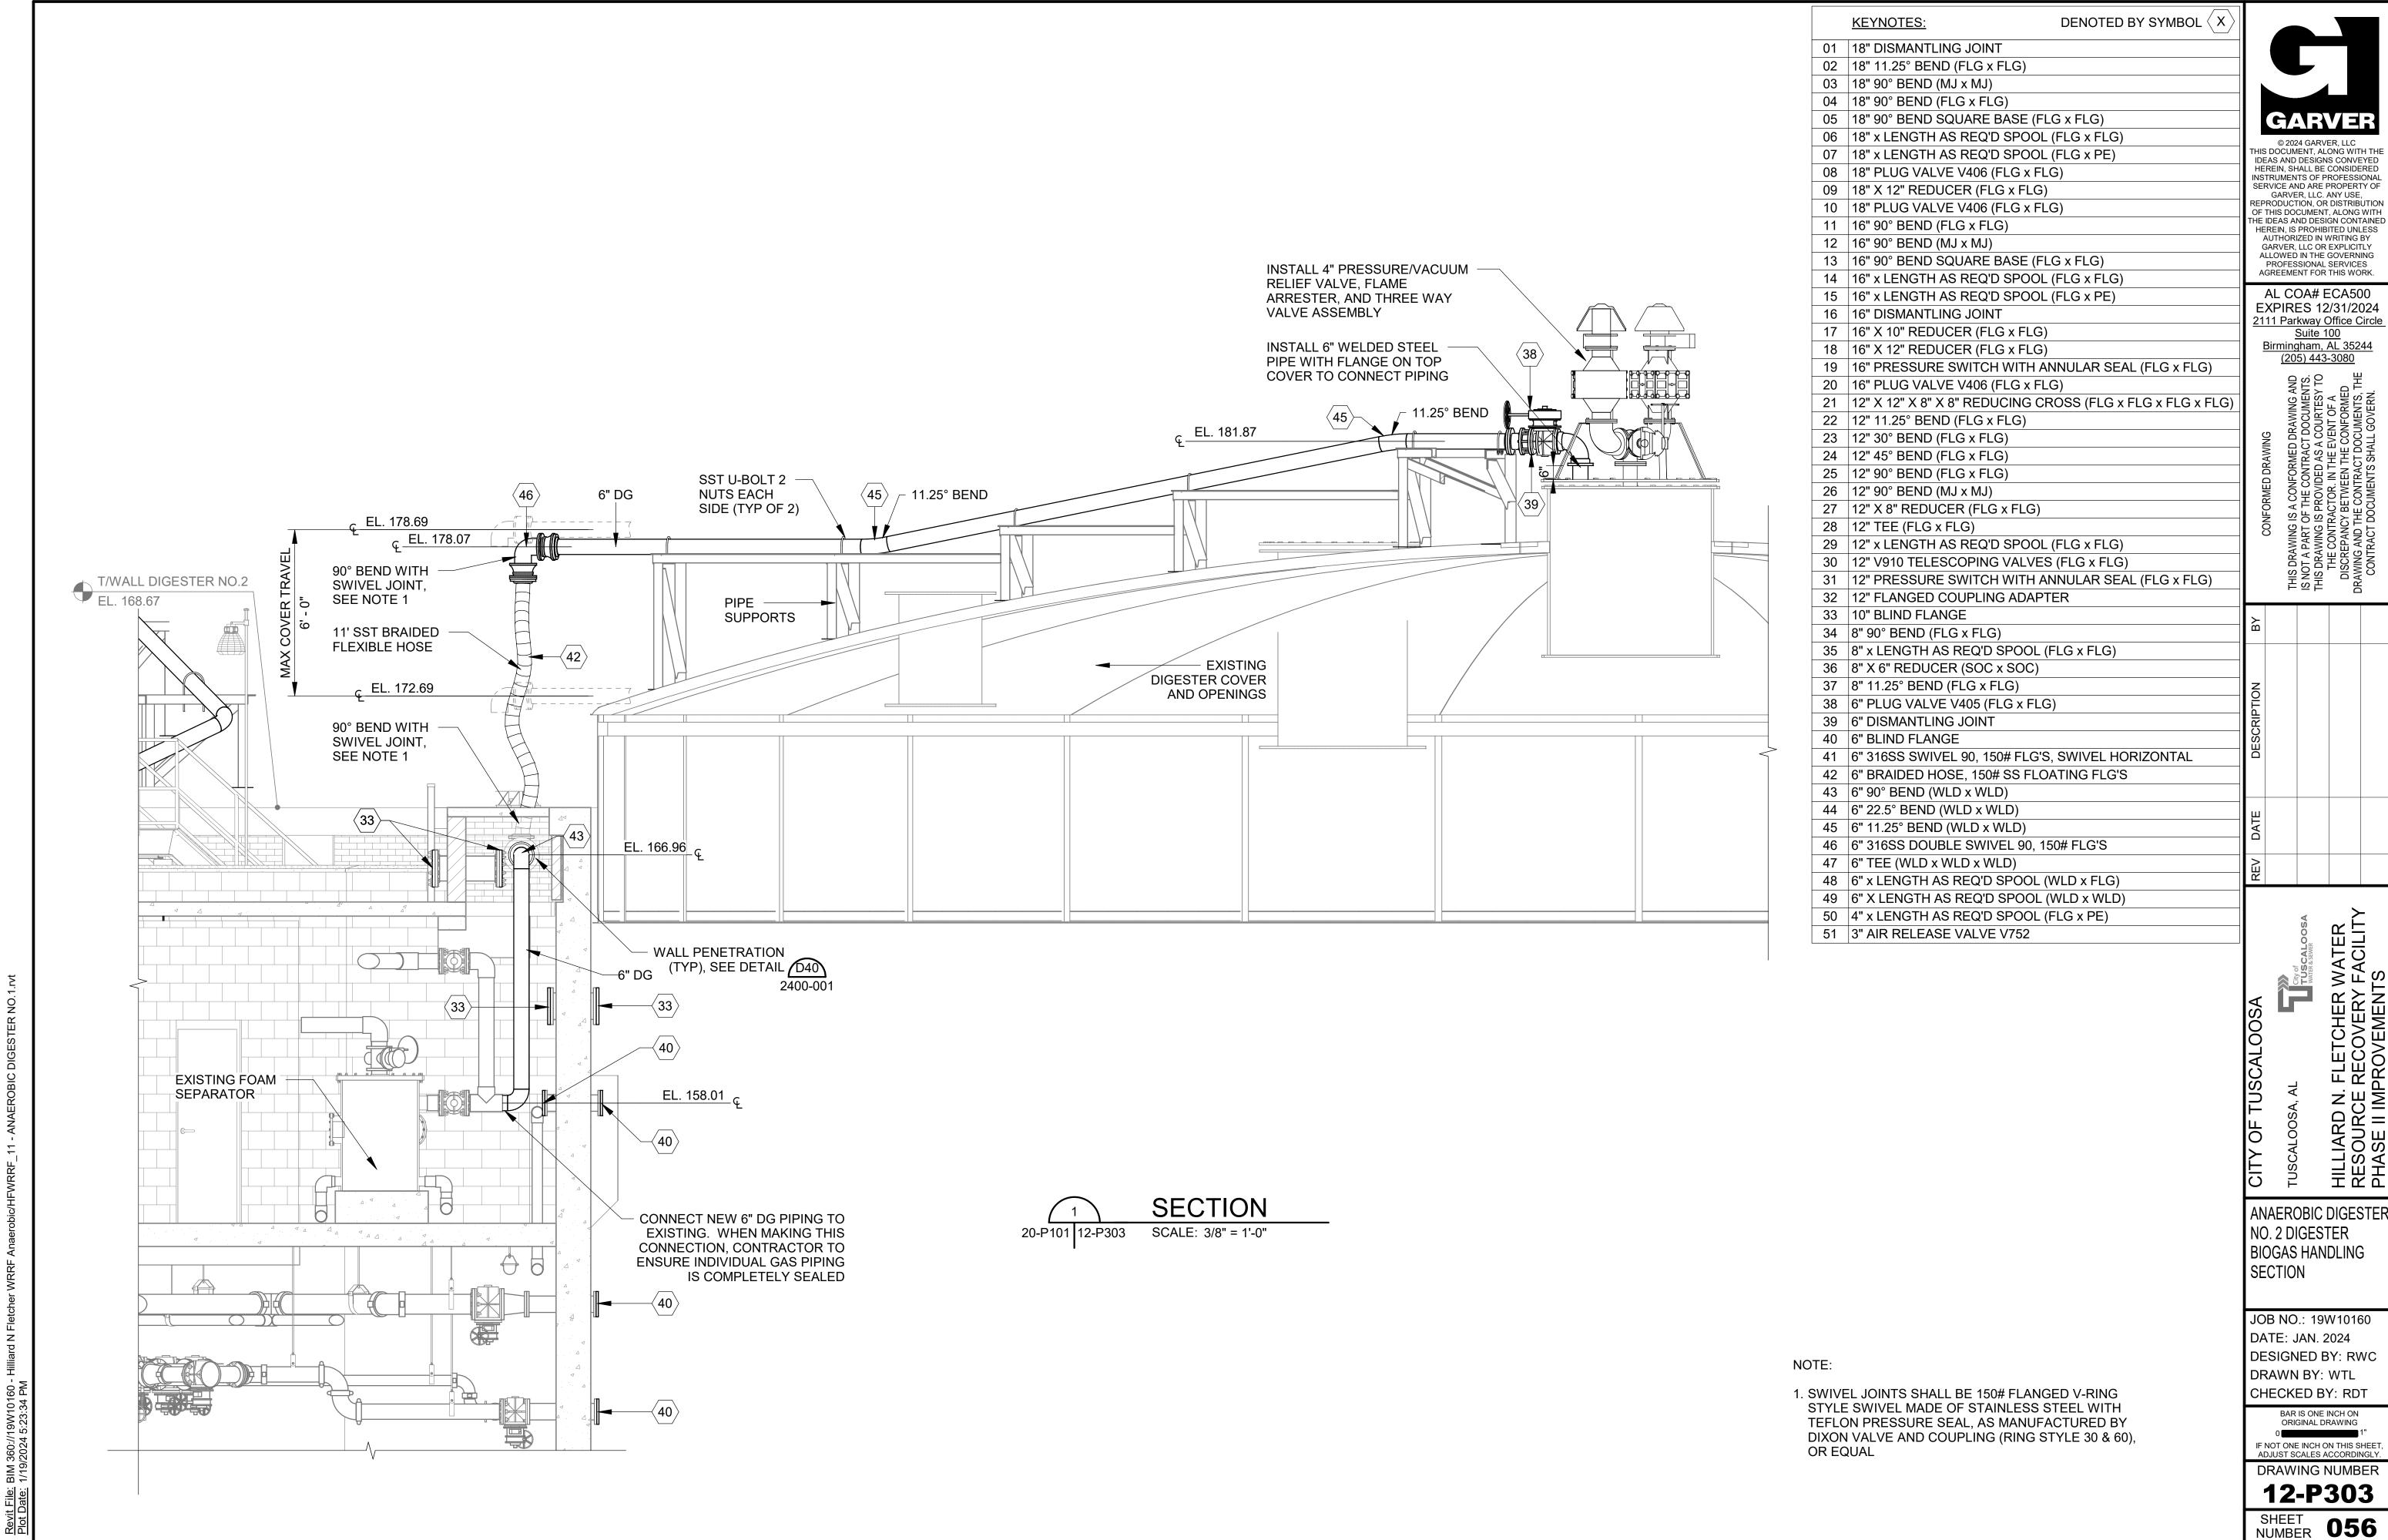
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SHEET NUMBER 057





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DESCRIPTION		
REV DATE		
REV		

ANAEROBIC DIGESTER NO. 2 DIGESTER COVER BIOGAS PIPING ISOMETRIC

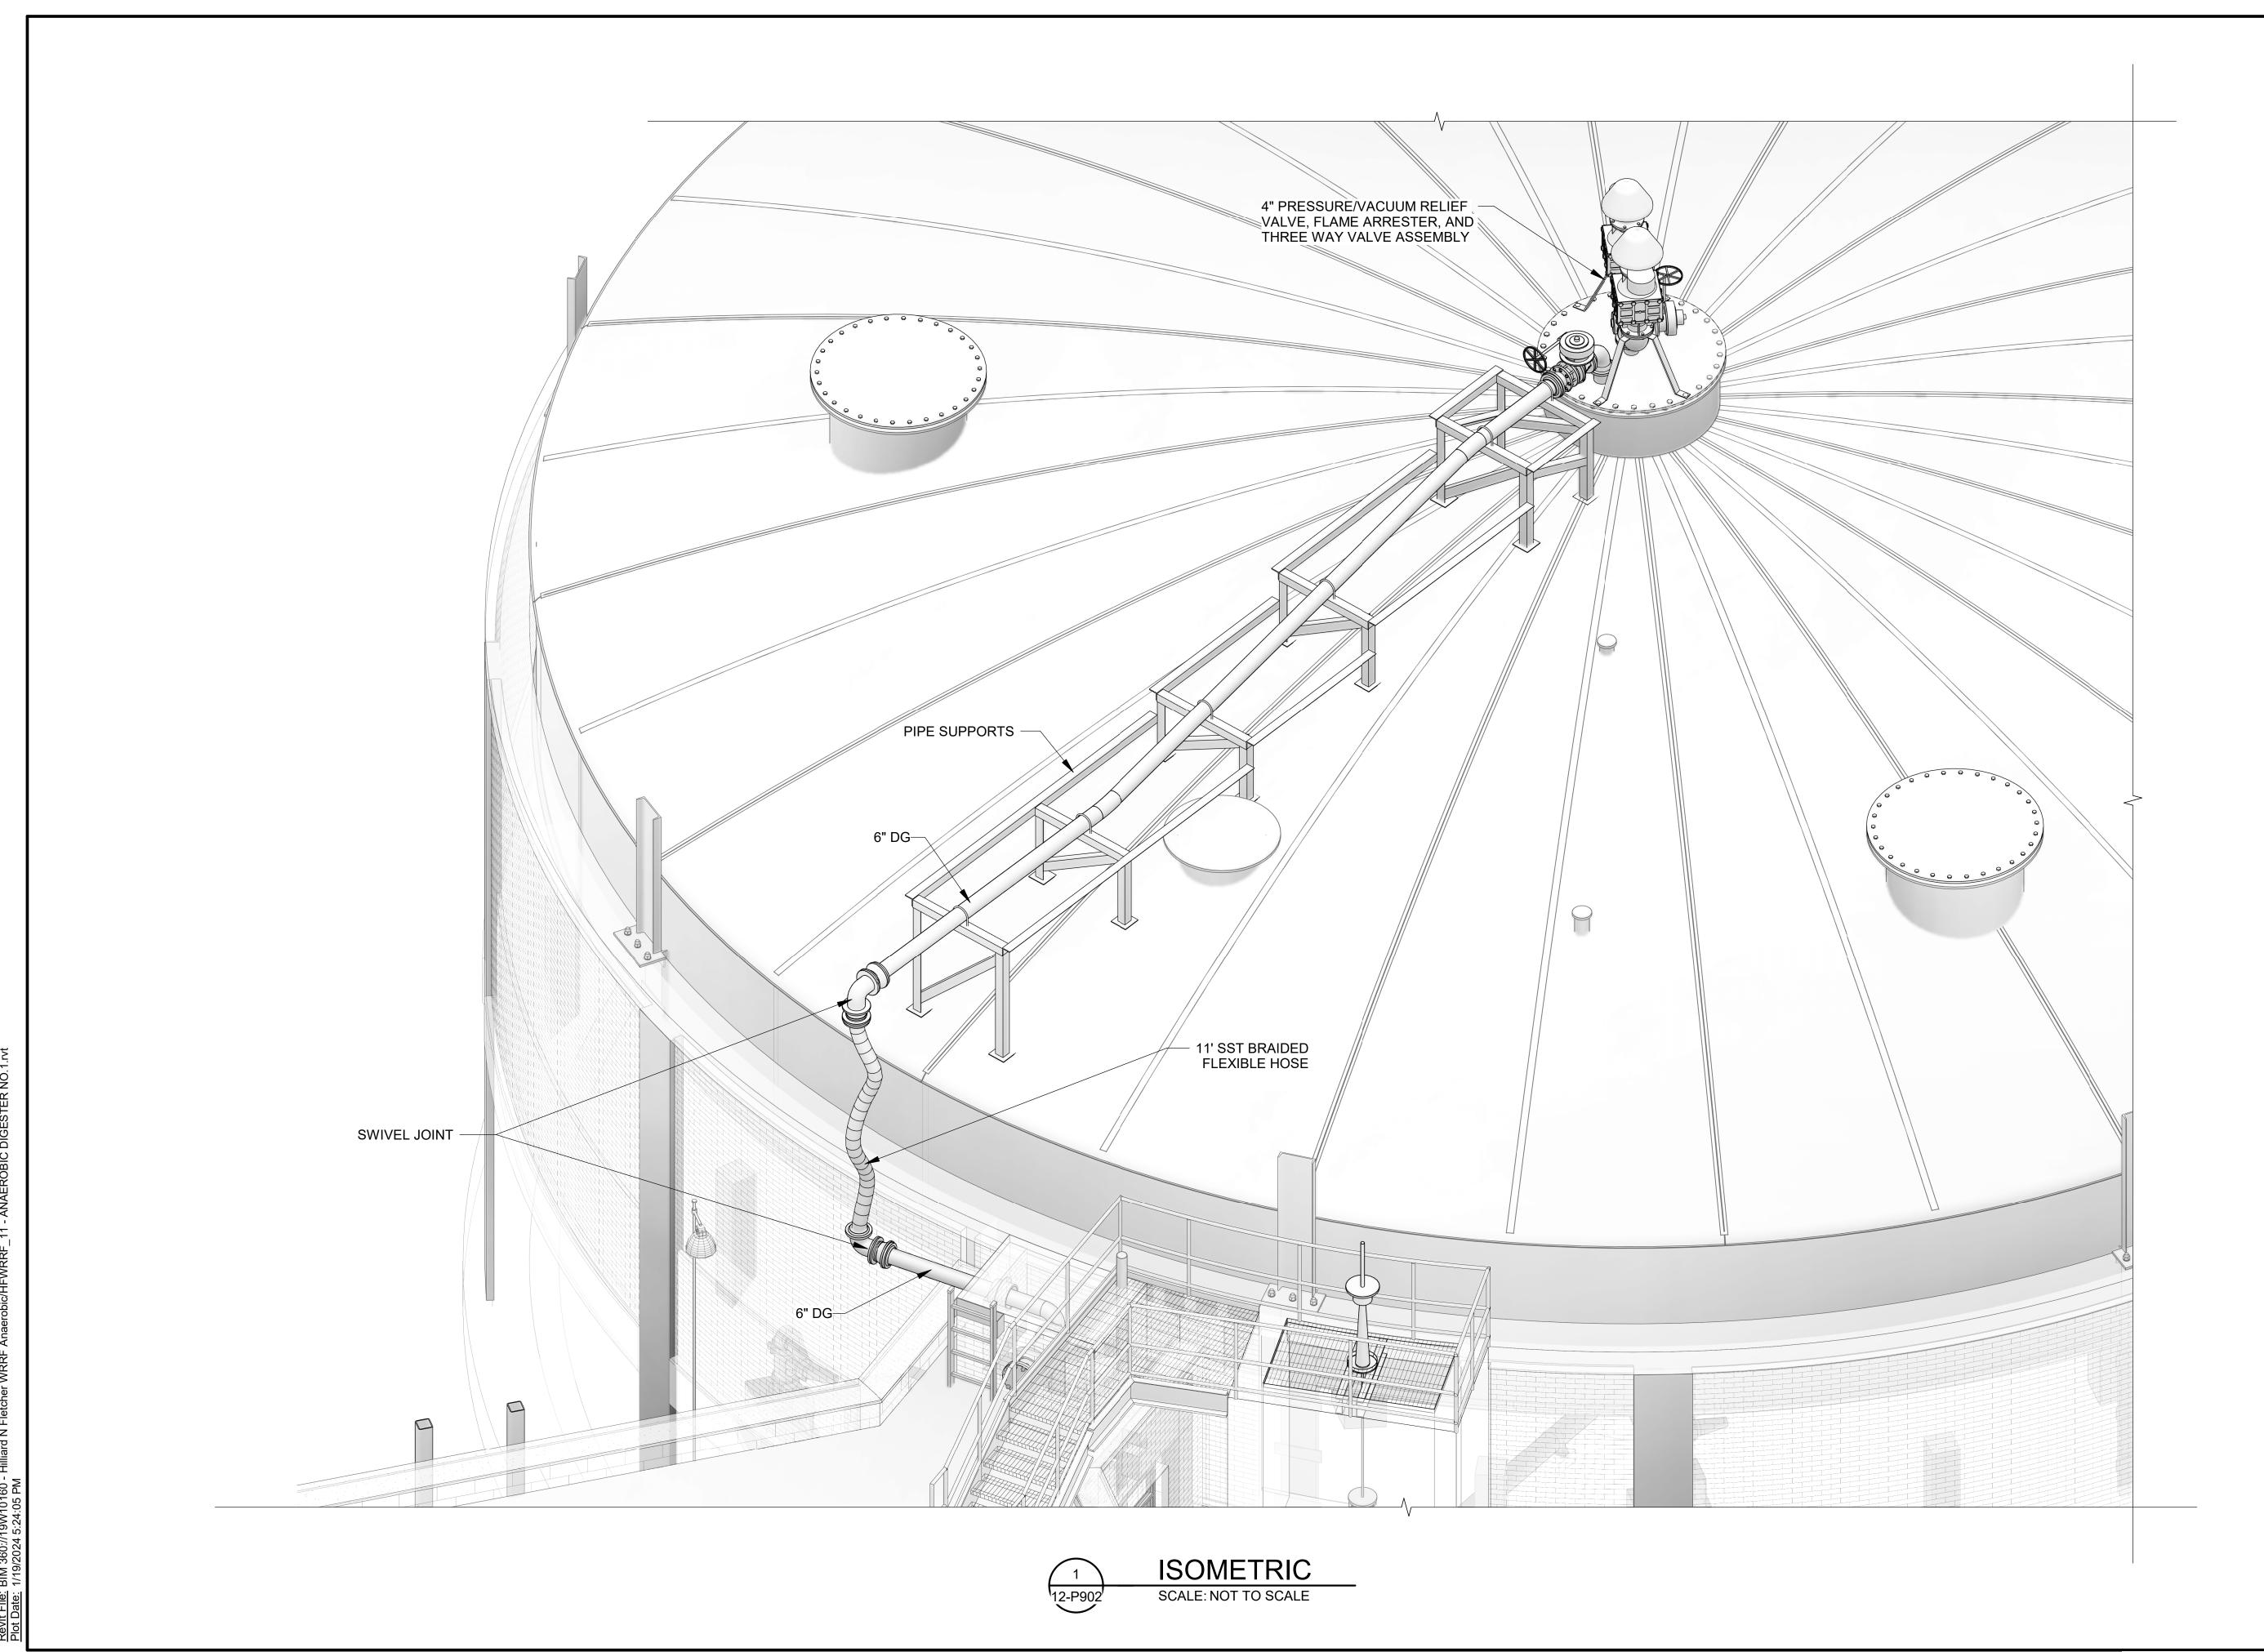
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12-P902 SHEET NUMBER 058



DEMOLITION LEGEND

TO BE DEMOLISHED

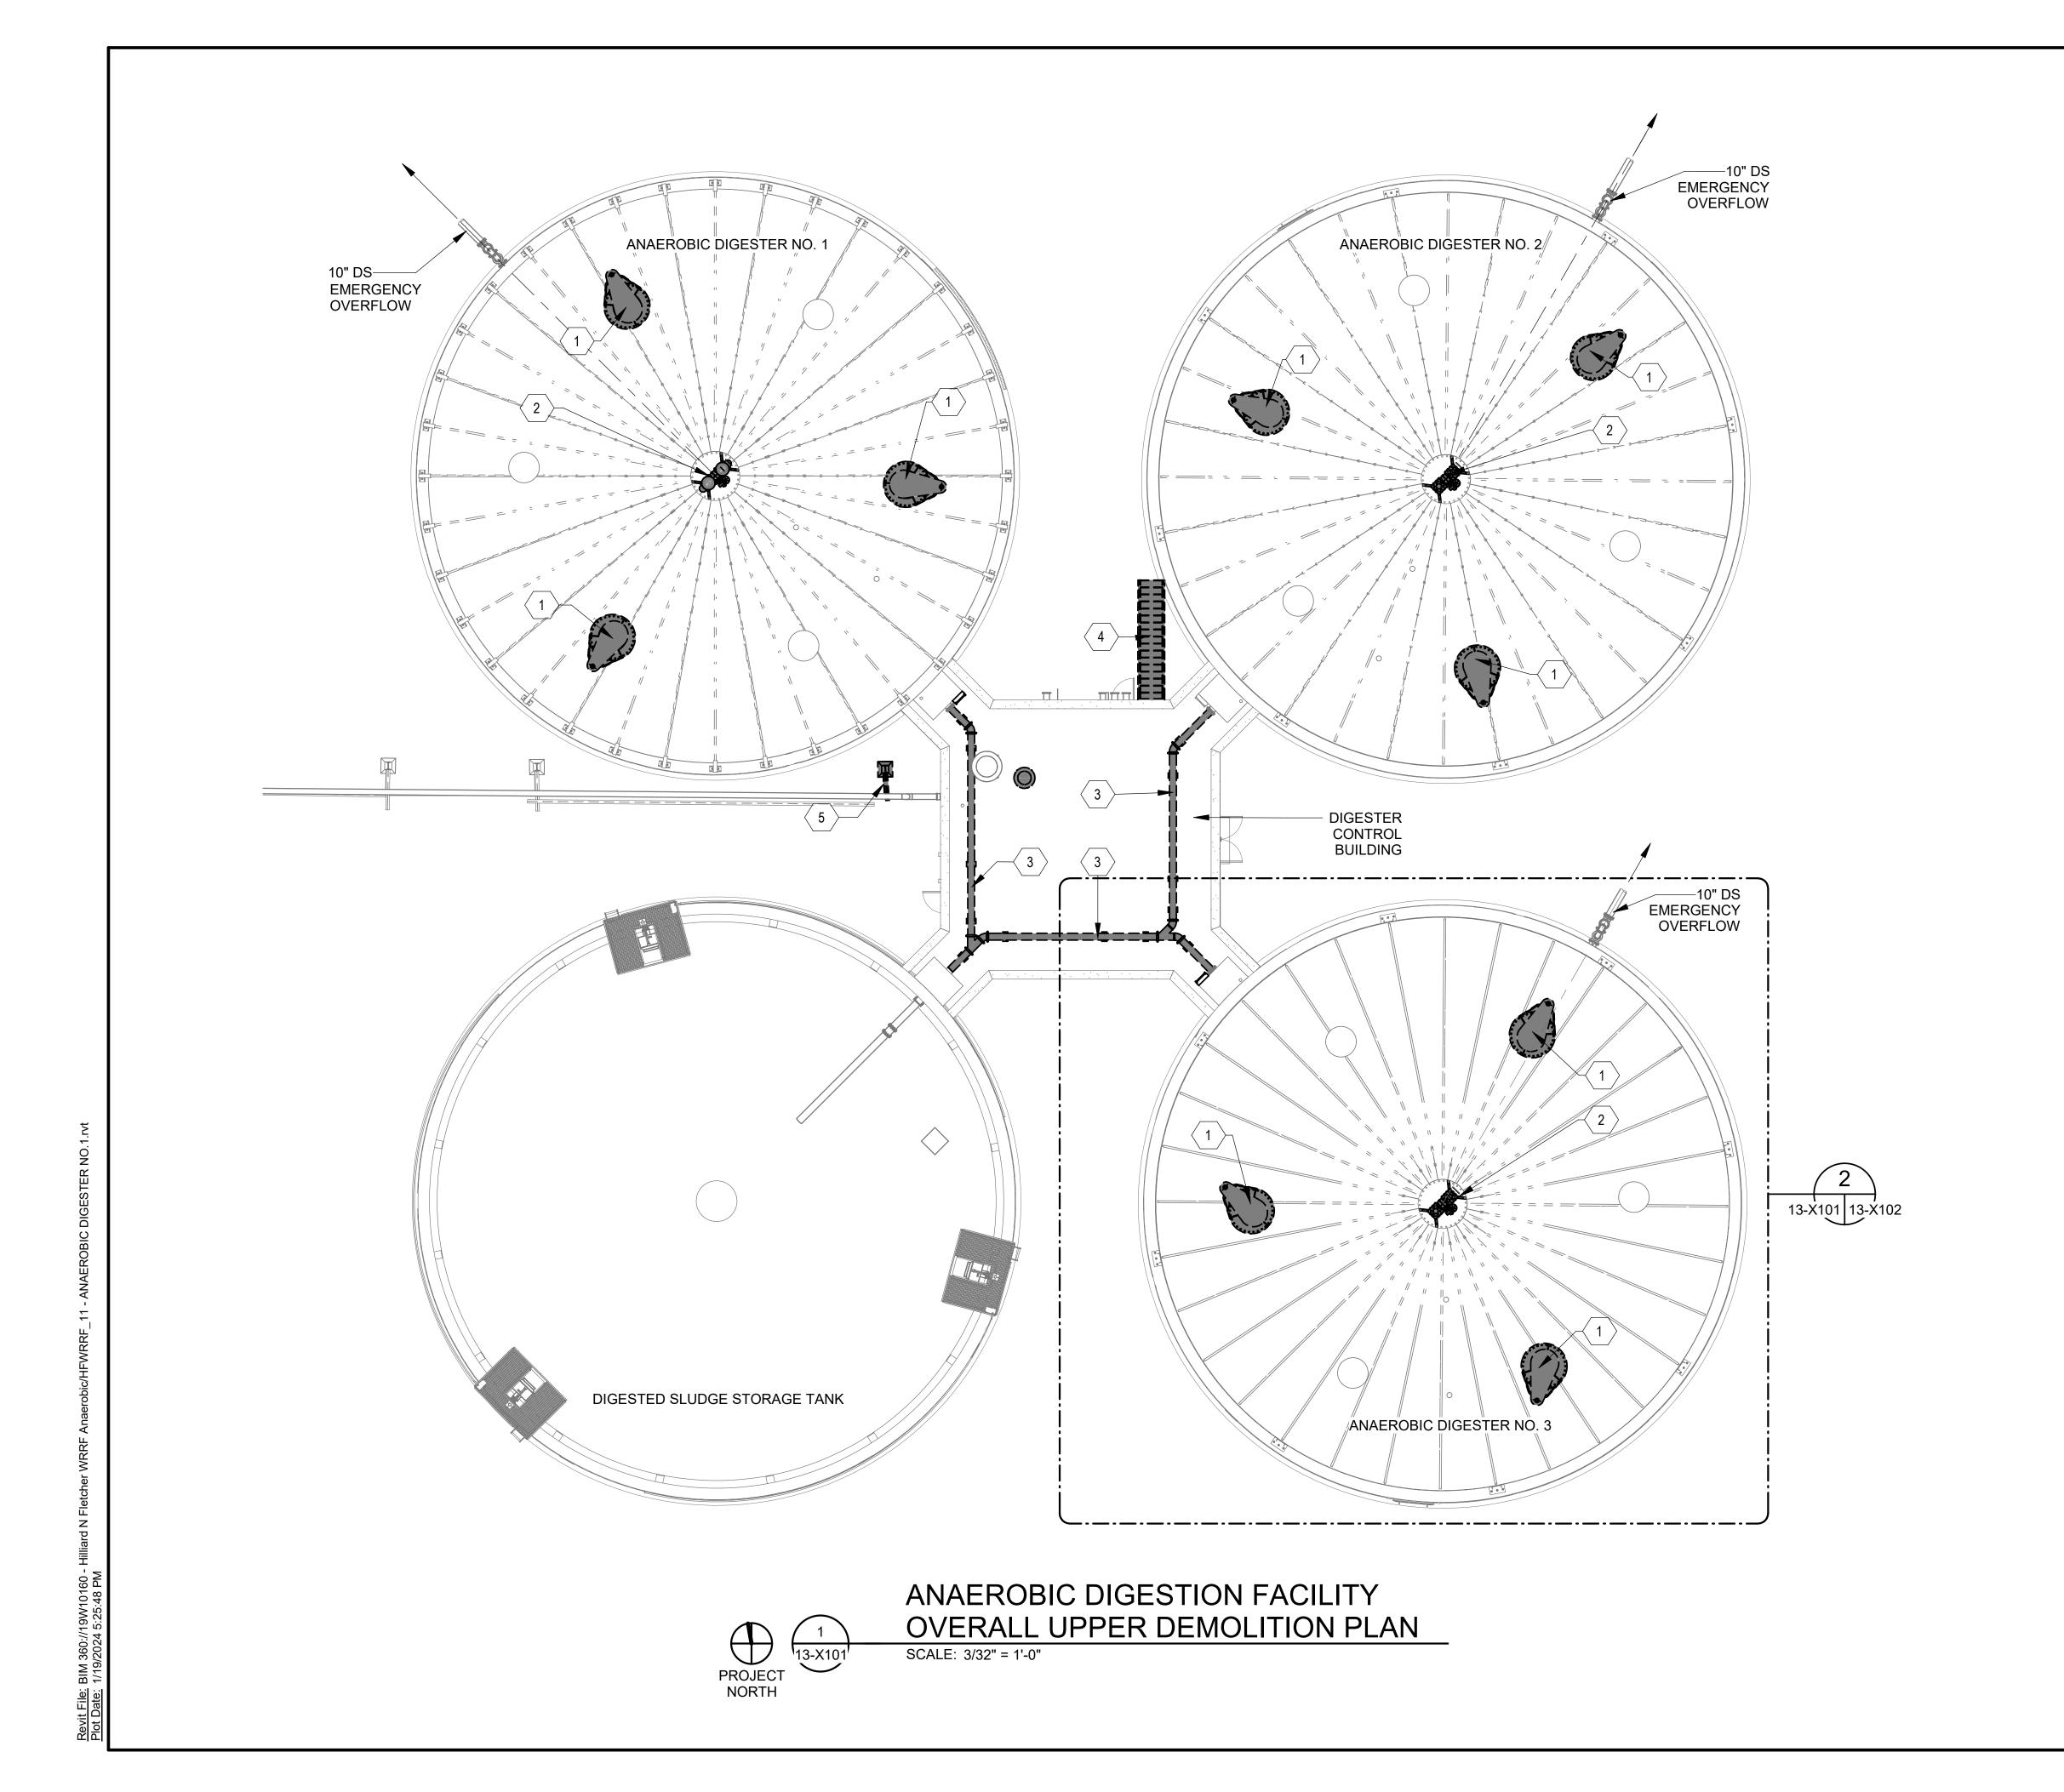

KEYNOTES:

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- 1 DEMOLISH ALL EXISTING DIGESTER MIXING
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 PROVIDE BOLT-ON COVER OVER COVER OPENING
 WITH APPROPRIATE GASKET SYSTEM FOR SEALING.
- 2 REMOVE FLAME ARRESTORS, PRESSURE/VACUUM RELIEF VALVES AND THREE WAY VALVE.
- 3 DEMOLISH AND DISPOSE EXISTING 10" DIGESTED SLUDGE TRANSFER PIPE AND ASSOCIATED SUPPORTS ON ROOF.
- 4 DEMOLISH AND DISPOSE EXISTING STAIRS.
- 5 RELOCATE EXISTING PIPE SUPPORT. PROVIDE TEMPORARY PIPE SUPPORT DURING CONSTRUCTION PHASE.

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TUSCALOOSA, AL

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RESOURCE REC

ANAEROBIC DIGESTION FACILITY UPPER DEMOLITION PLAN

JOB NO.: 19W10160 DATE: JAN. 2024 DESIGNED BY: RWC DRAWN BY: WTL CHECKED BY: RDT

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DRAWING NUMBER

13-X101

SHEET 059

UPPER DEMOLITION PLAN

SCALE: 3/16" = 1'-0"

KEYNOTES:

- 1 DEMOLISH ALL EXISTING DIGESTER MIXING **EQUIPMENT, TUBE SECTIONS, AND CONCRETE MIXER** SUPPORTS. DRILL OUT EXPOSED REINFORCEMENT AS NEEDED AND PATCH SURFACE OF DIGESTER SLAB, PROVIDE BOLT-ON COVER OVER COVER OPENING WITH APPROPRIATE GASKET SYSTEM FOR SEALING.
- REMOVE FLAME ARRESTORS, PRESSURE/VACUUM RELIEF VALVES AND THREE WAY VALVE.
- 3 DEMOLISH AND DISPOSE EXISTING 10" DIGESTED SLUDGE TRANSFER PIPE AND ASSOCIATED SUPPORTS ON ROOF.

DEMOLITION LEGEND

TO BE DEMOLISHED



DENOTED BY SYMBOL (X)

GENERAL NOTES:

- 1. OWNER SHALL REMOVE ALL EXISTING SOLIDS TO THE GREATEST EXTENT POSSIBLE. ALL REMAINING SOLIDS SHALL BE REMOVED BY THE CONTRACTOR AS DETAILED IN SPECIFICATION SECTION 44 10 00.
- 2. IT IS THE CONTRACTOR'S SOLE RESPONSIBILITY TO DETERMINE PROCEDURE AND SEQUENCE TO ENSURE THE SAFETY OF THE TANK AND ITS COMPONENT PARTS DURING REHABILITATION AND TO PROVIDE ANY REQUIRED TEMPORARY BRACING, GUYS, OR TIE-DOWNS AS NECESSARY FOR COMPLETION OF THE WORK. SUCH MATERIAL SHALL BE REMOVED FROM THE SITE AND REMAIN THE CONTRACTOR'S PROPERTY AFTER COMPLETION OF THE WORK.
- 3. CONTRACTOR SHALL EXERCISE EXTREME CARE WHEN DRAINING AND/OR FILLING THE DIGESTER TANK. ALL PRESSURE RELIEF AND VACUUM RELIEF VALVES SHALL BE IN WORKING CONDITION UNLESS OTHER MEANS ARE PROVIDED TO PREVENT PRESSURIZED OR VACUUM CONDITIONS WITHIN THE DIGESTER, WHICH MAY CAUSE DAMAGE TO THE COVER.
- 4. EXISTING DOME FRAMING SUPPORT MEMBERS SHALL NOT BE DAMAGED DURING SAWCUTTING OR OTHER MEANS USED FOR REMOVAL OF THE PLATE SECTIONS.
- CONTRACTOR SHALL REMOVE ALL EXISTING EXPOSED CONDUIT TO COVER MOUNTED EQUIPMENT INSTRUMENTATION, AND OTHER DEVICES THAT IS/WILL BE NO LONGER IN SERVICE. SEAL/PATCH ANY HOLES, AS REQUIRED.
- CONTRACTOR SHALL ASSESS THE STRUCTURAL STABILITY OF ALL EXPOSED BRICK SECTIONS/FACADES ON EXTERIOR OF DIGESTER TANK. ANY ADDITIONAL REPAIRS AND/OR DEMOLITION NECESSARY TO ADDRESS THESE AREAS SHALL BE PAID FROM USING THE CONTINGENCY ALLOWANCE BASED ON EXTENT OF REPAIRS OR ADDITIONAL DEMOLITION.

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ANAEROBIC DIGESTER NO. 3 UPPER DEMOLITION PLAN

JOB NO.: 19W10160 DATE: JAN. 2024 **DESIGNED BY: RWC** DRAWN BY: WTL CHECKED BY: RDT

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13-X102 SHEET 060

KEYNOTES:

1 DEMOLISH ALL EXISTING DIGESTER MIXING EQUIPMENT, TUBE SECTIONS, AND CONCRETE MIXER SUPPORTS. DRILL OUT EXPOSED REINFORCEMENT AS NEEDED AND PATCH SURFACE OF DIGESTER SLAB, PROVIDE BOLT-ON COVER OVER COVER OPENING WITH APPROPRIATE GASKET SYSTEM FOR SEALING.

DENOTED BY SYMBOL (X)

2 DEMOLISH AND REMOVE EXISTING DIGESTER RECIRCULATION PIPING AND SUPPORT STRUCTURE. EXISTING PIPING TO BE DEMO'D UP TO THE FIRST FLANGE FROM THE WALL. DRILL OUT EXPOSED REINFORCEMENT AS NEEDED AND PATCH SURFACE OF DIGESTER SLAB.

3 DEMOLISH EXISTING BRICK FACADE TO EXTENT NECESSARY TO INSTALL NEW DIGESTER TRANSFER BOX. REPLACE BRICK FACADE UP TO THE EDGE OF THE TRANSFER BOXES WITH MATCHING BRICK.

DEMOLITION LEGEND

TO BE DEMOLISHED

GENERAL NOTES:

- 1. OWNER SHALL REMOVE ALL EXISTING SOLIDS TO THE GREATEST EXTENT POSSIBLE. ALL REMAINING SOLIDS SHALL BE REMOVED BY THE CONTRACTOR AS DETAILED IN SPECIFICATION SECTION 44 10 00.
- 2. IT IS THE CONTRACTOR'S SOLE RESPONSIBILITY TO DETERMINE PROCEDURE AND SEQUENCE TO ENSURE THE SAFETY OF THE TANK AND ITS COMPONENT PARTS DURING REHABILITATION AND TO PROVIDE ANY REQUIRED TEMPORARY BRACING, GUYS, OR TIE-DOWNS AS NECESSARY FOR COMPLETION OF THE WORK. SUCH MATERIAL SHALL BE REMOVED FROM THE SITE AND REMAIN THE CONTRACTOR'S PROPERTY AFTER COMPLETION OF THE WORK.
- 3. CONTRACTOR SHALL EXERCISE EXTREME CARE WHEN DRAINING AND/OR FILLING THE DIGESTER TANK. ALL PRESSURE RELIEF AND VACUUM RELIEF VALVES SHALL BE IN WORKING CONDITION UNLESS OTHER MEANS ARE PROVIDED TO PREVENT PRESSURIZED OR VACUUM CONDITIONS WITHIN THE DIGESTER, WHICH MAY CAUSE DAMAGE TO THE COVER.

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ANAEROBIC DIGESTER NO. 3 LOWER DEMOLITION PLAN

JOB NO.: 19W10160 DATE: JAN. 2024 DESIGNED BY: RWC DRAWN BY: WTL CHECKED BY: RDT

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13-X103 SHEET 061

ISSUED FOR CONSTRUCTION



LOWER DEMOLITION PLAN

13-X103

PROJECT NORTH


KEYNOTES:

DENOTED BY SYMBOL (X)

- 1 DEMOLISH AND REMOVE EXISTING DIGESTER RECIRCULATION PIPING AND SUPPORT STRUCTURE. EXISTING PIPING TO BE DEMO'D UP TO THE FIRST FLANGE FROM THE WALL. DRILL OUT EXPOSED REINFORCEMENT AS NEEDED AND PATCH SURFACE OF DIGESTER SLAB.
- 2 REMOVE FLAME ARRESTORS, PRESSURE/VACUUM RELIEF VALVES AND THREE WAY VALVE.
- 3 REFER TO SPECIFICATION SECTION 44 10 00 FOR DIGESTER CLEANOUT REQUIREMENTS.
- 4 | CONTRACTOR TO REMOVE AND REPLACE EXISTING DIGESTED SLUDGE TRANSFER PIPING AND PIPE SUPPORT HARDWARE. EXISTING PIPE SUPPORTS TO REMAIN. PIPING TO BE DEMO'D UP TO THE FIRST FLANGE FROM THE WALL.


DEMOLITION LEGEND

TO BE DEMOLISHED

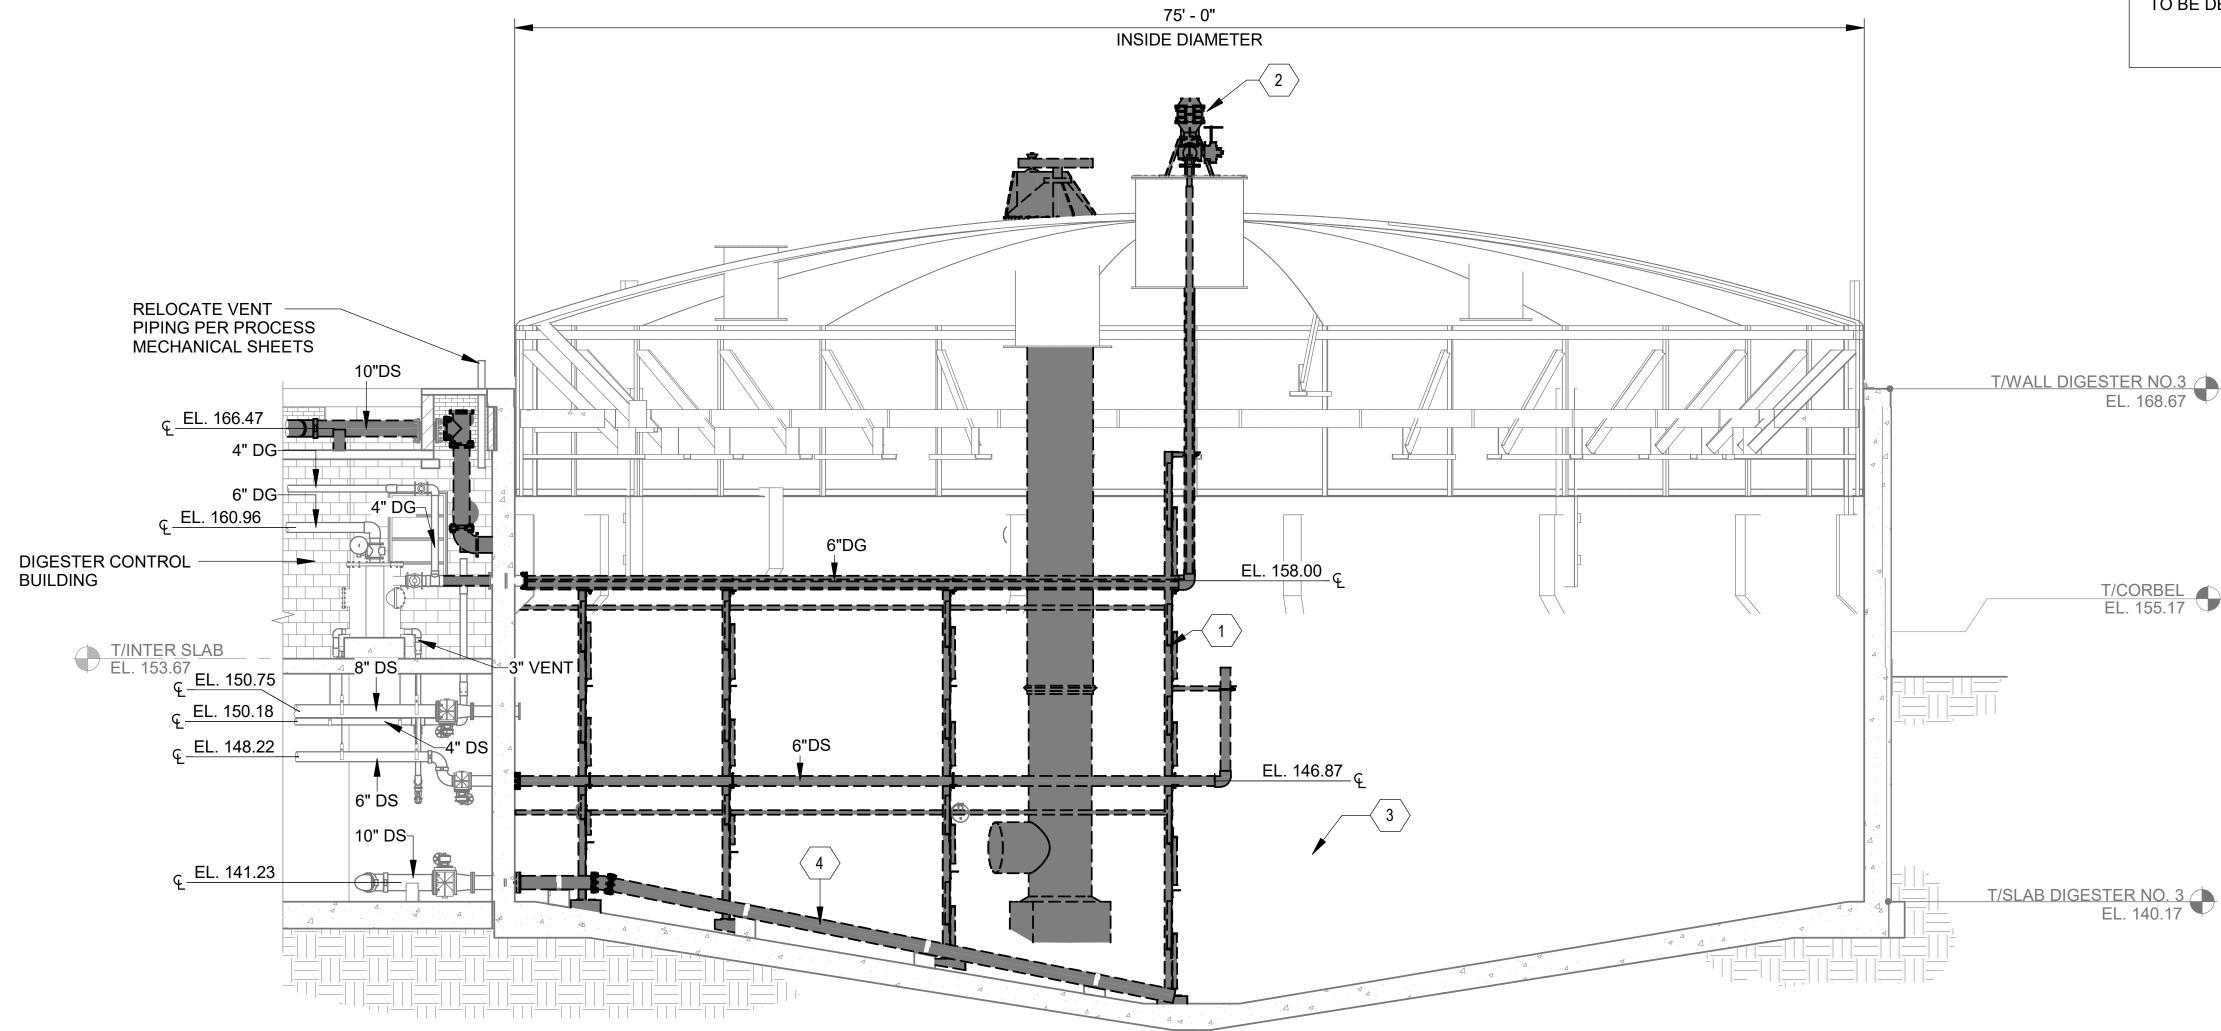

NOTES:

- 1. INTERIOR TANK DETAILS HAVE BEEN PROVIDED BASED ON AVAILABLE RECORD DRAWINGS. DIMENSIONS HAVE NOT BEEN VERIFIED FOR ACCURACY.
- CONTRACTOR IS RESPONSIBLE FOR FIELD VERIFYING ALL EXISTING CONDITIONS INCLUDING LOCATION AND DIMENSIONS OF ALL EXISTING STRUCTURES, EQUIPMENT, AND UTILITIES. CONTRACTOR SHALL NOTIFY ENGINEER IF THERE IS A CONFLICT BETWEEN THE CONTRACT DOCUMENTS AND EXISTING CONDITIONS BEFORE PROCEEDING WITH WORK.

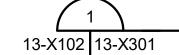


ANAEROBIC DIGESTER NO. 3 DEMOLITION SECTION SCALE: 3/16" = 1'-0"

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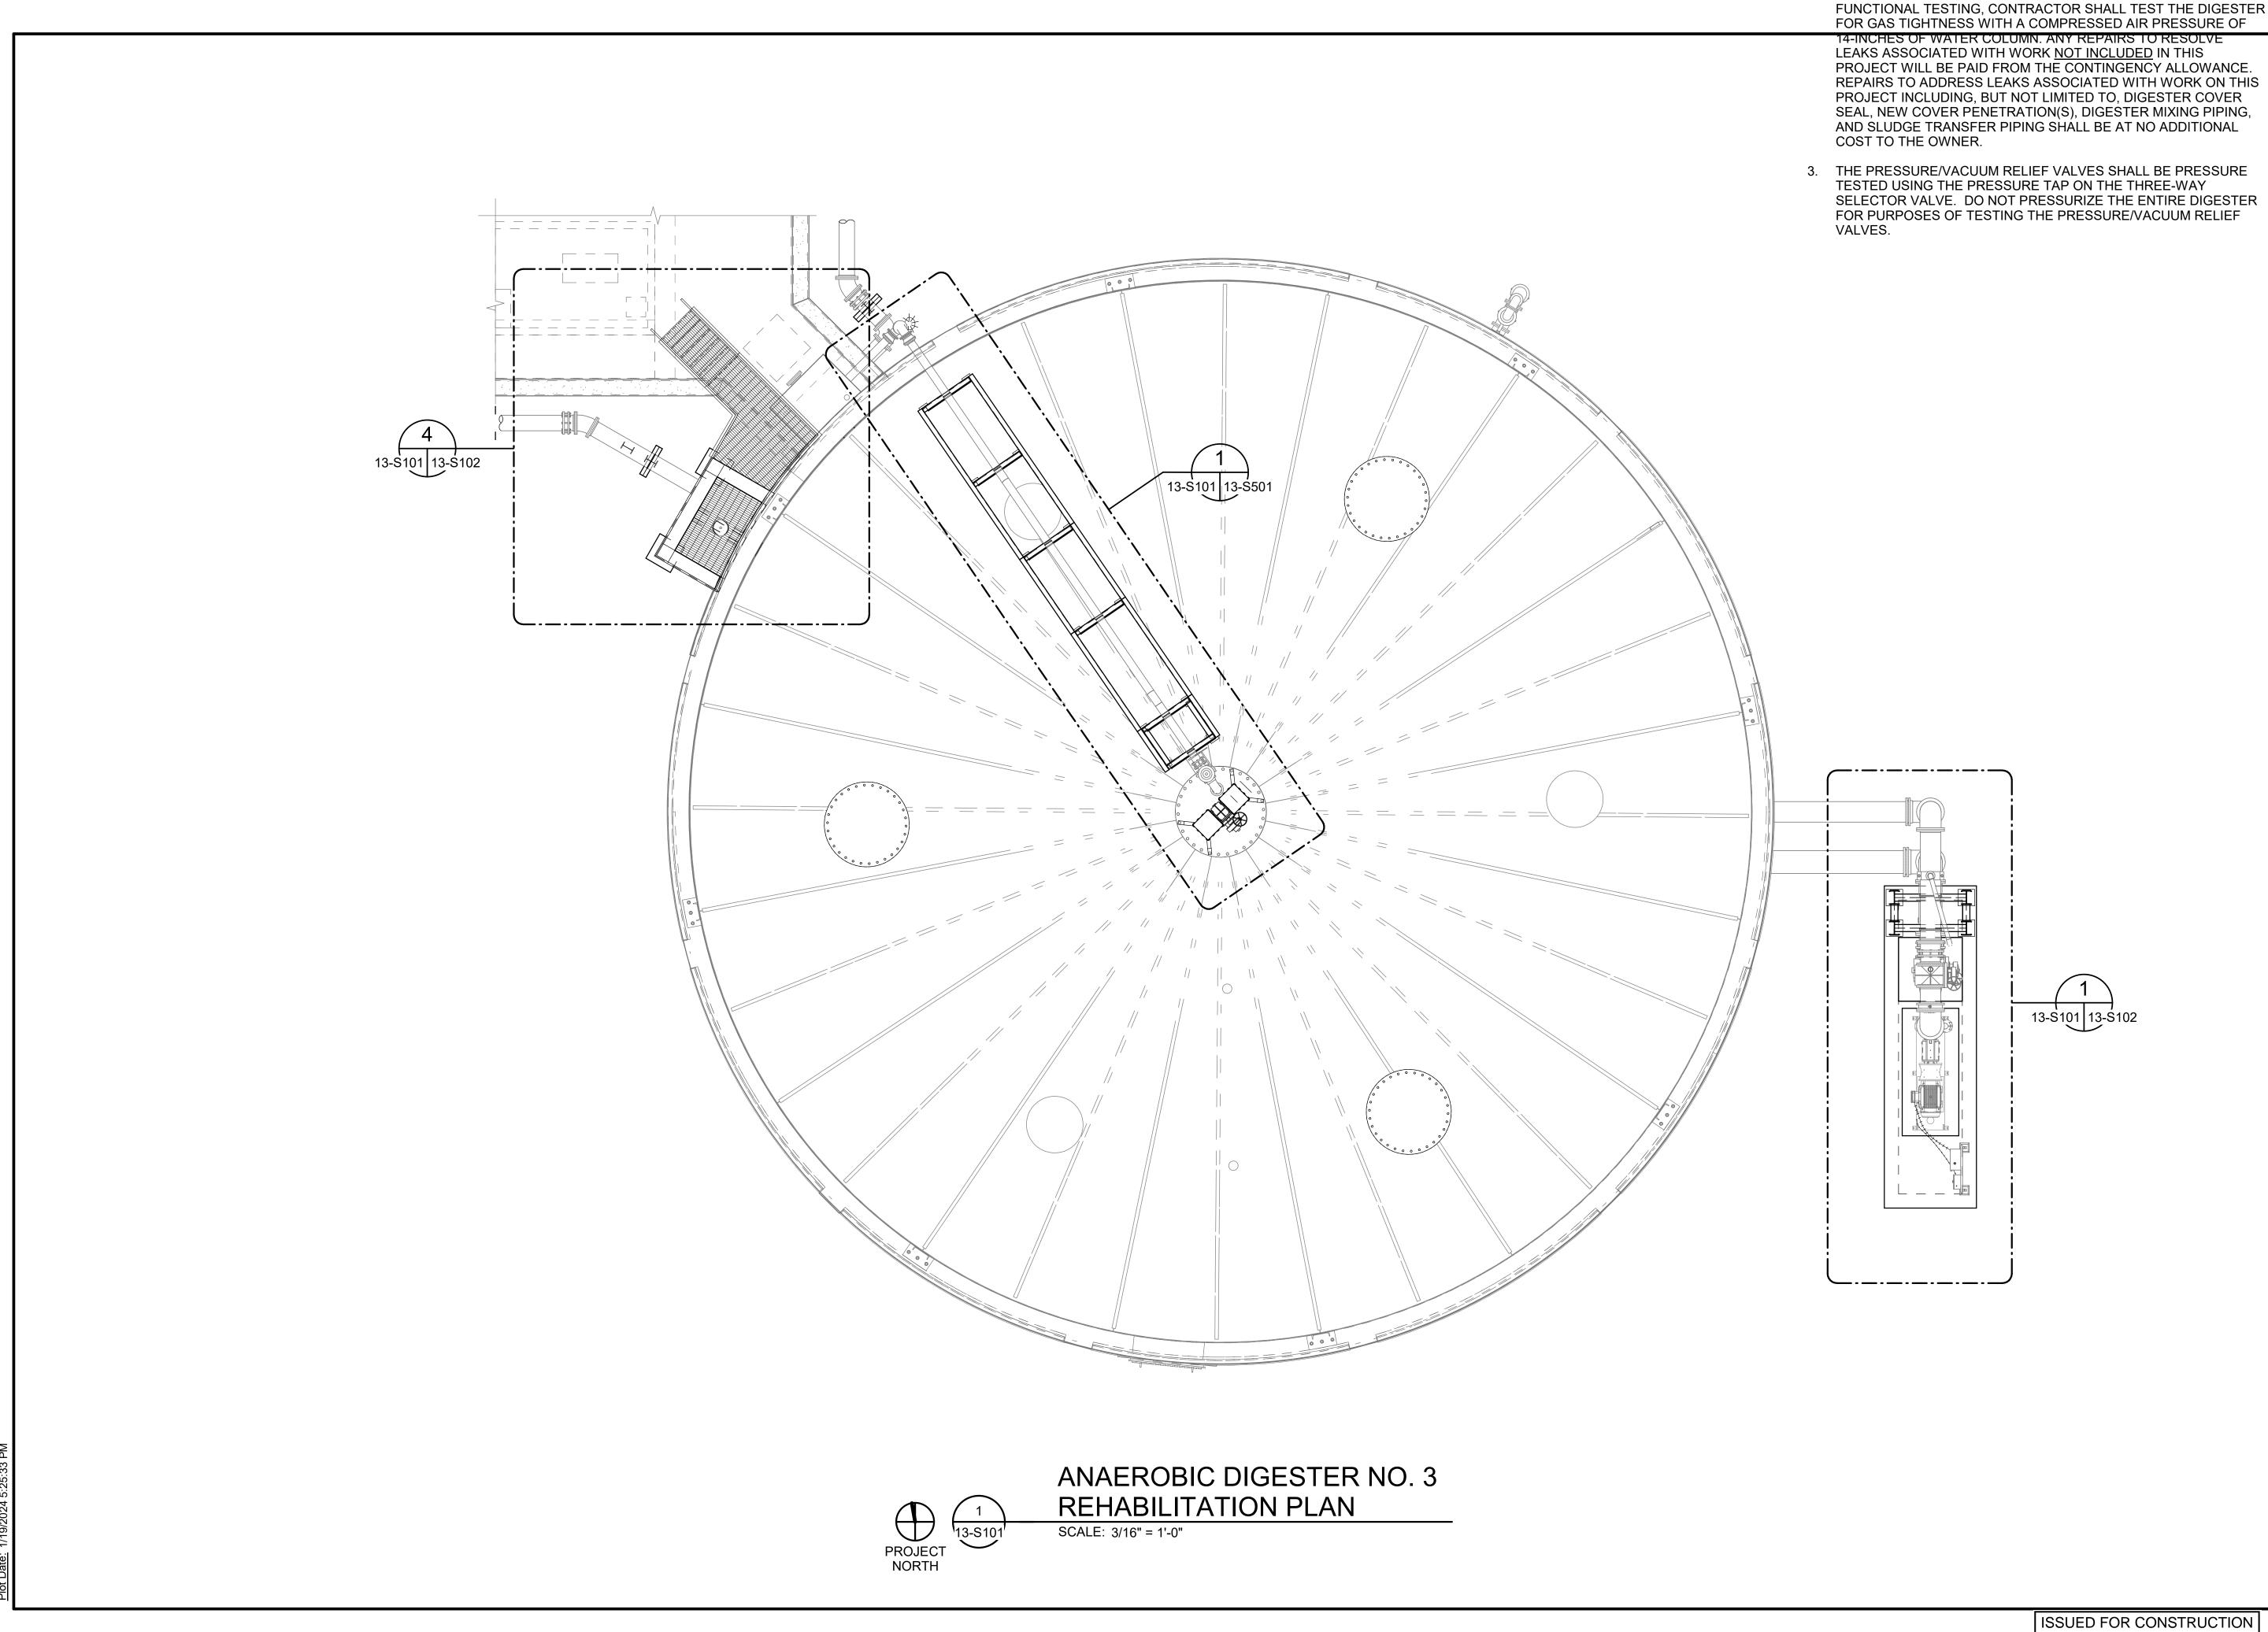
ANAEROBIC DIGESTER NO. 3 DEMOLITION SECTION

JOB NO.: 19W10160 DATE: JAN. 2024 **DESIGNED BY: RWC** DRAWN BY: WTL CHECKED BY: RDT

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13-X301

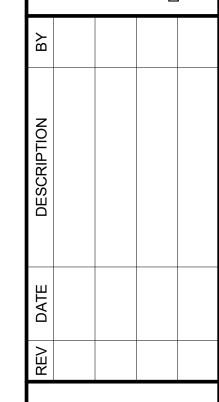

2. AS PART OF FILLING THE DIGESTER WITH WATER TO COMPLETE

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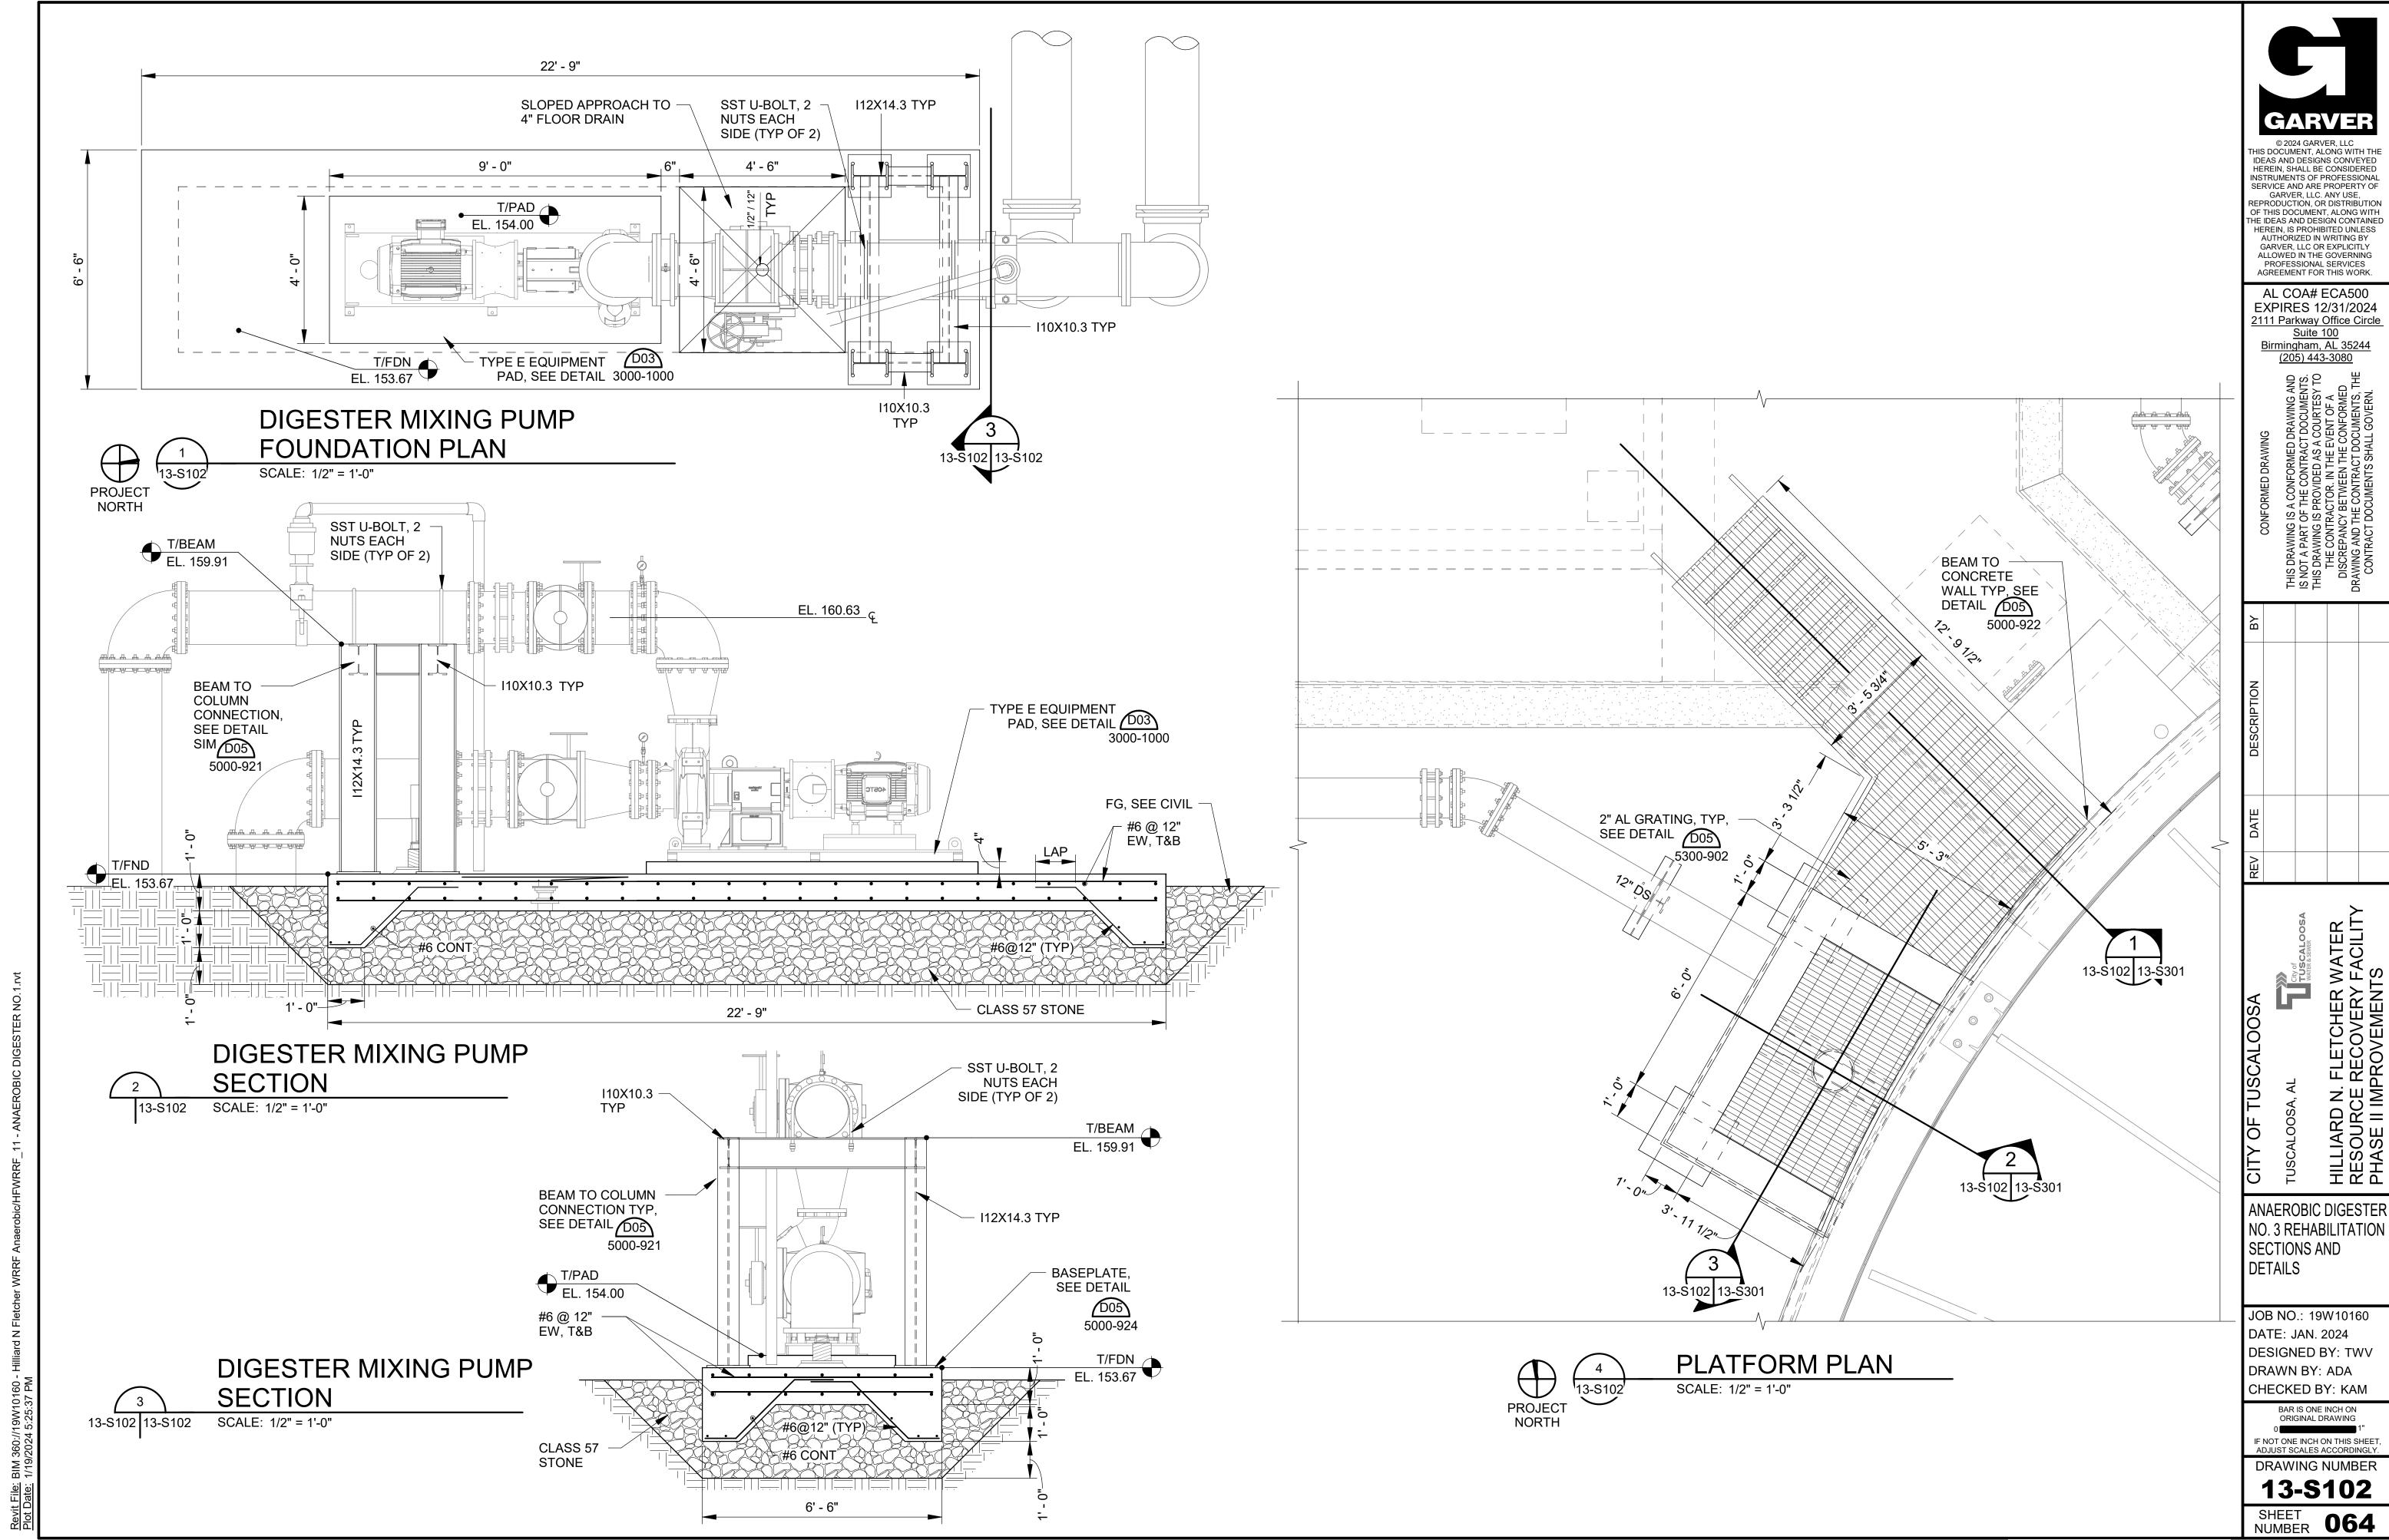
ANAEROBIC DIGESTER NO. 3 REHABILITATION PLAN AND DETAILS


JOB NO.: 19W10160 DATE: JAN. 2024 DESIGNED BY: KAU DRAWN BY: EGB CHECKED BY: KAM

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13-\$101 SHEET 063





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ANAEROBIC DIGESTER NO. 3 REHABILITATION SECTIONS

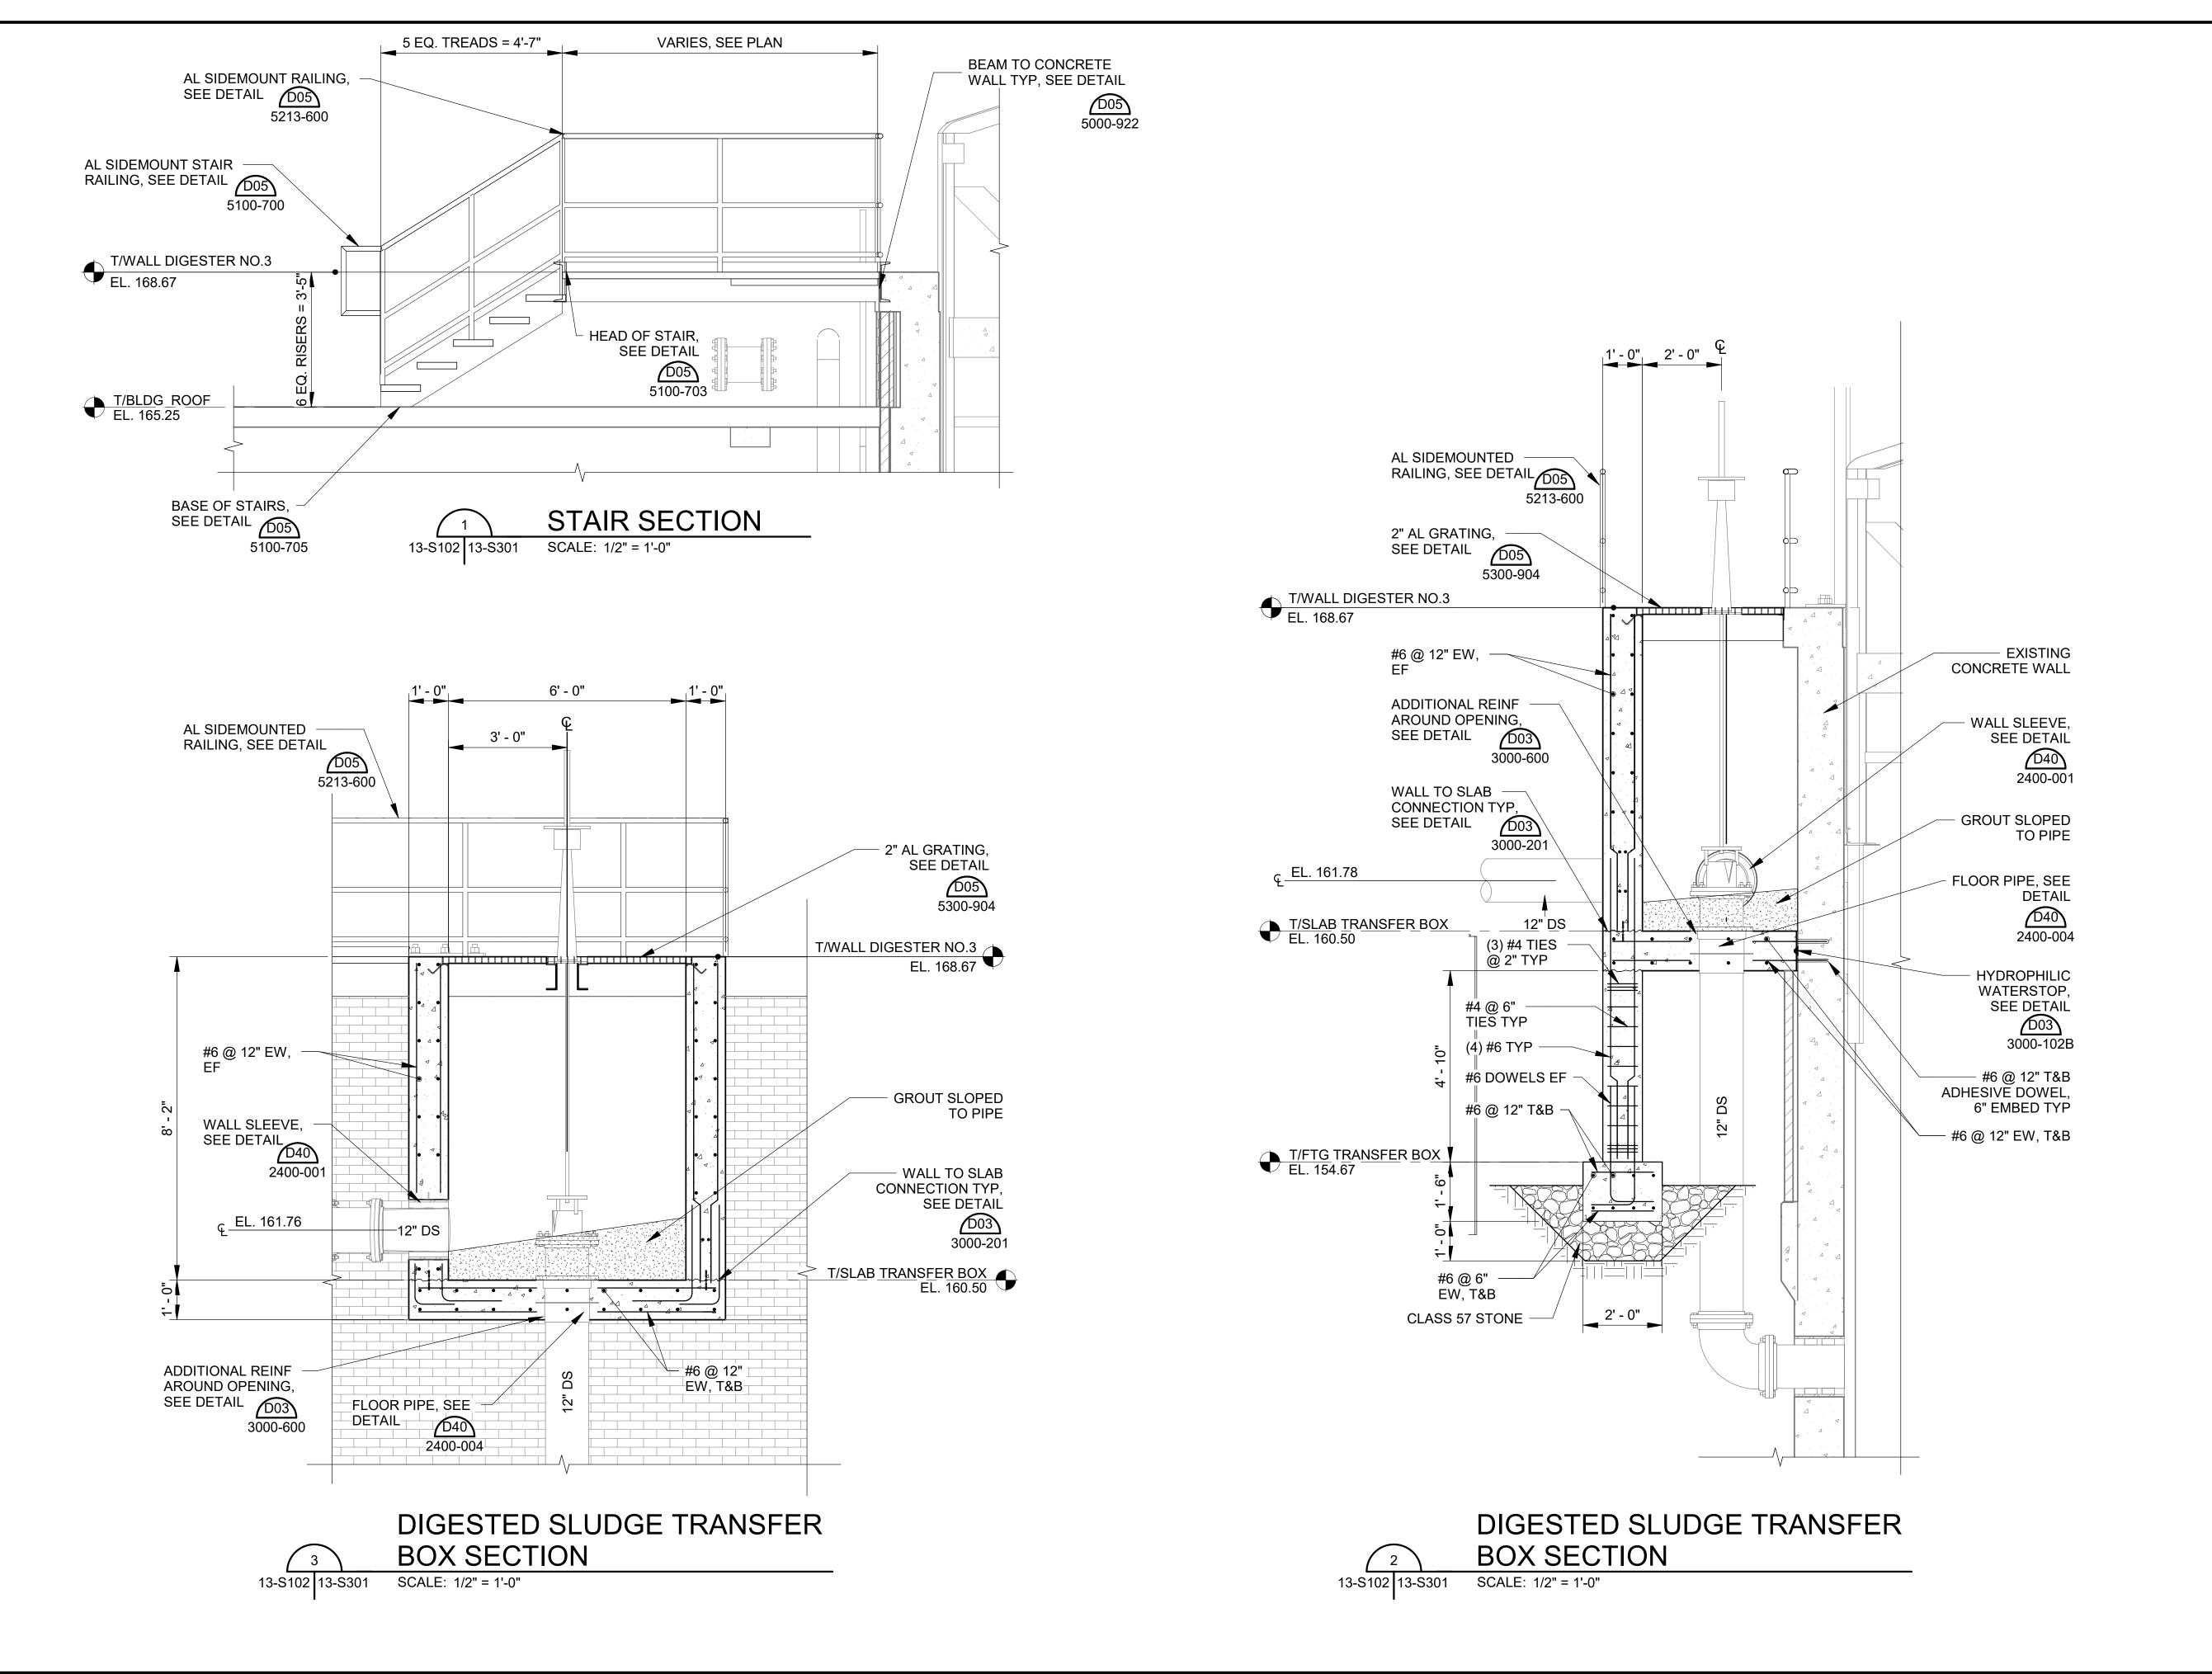JOB NO.: 19W10160
DATE: JAN. 2024
DESIGNED BY: TWF
DRAWN BY: ADA
CHECKED BY: KAM


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13-S301

SHEET NUMBER 065



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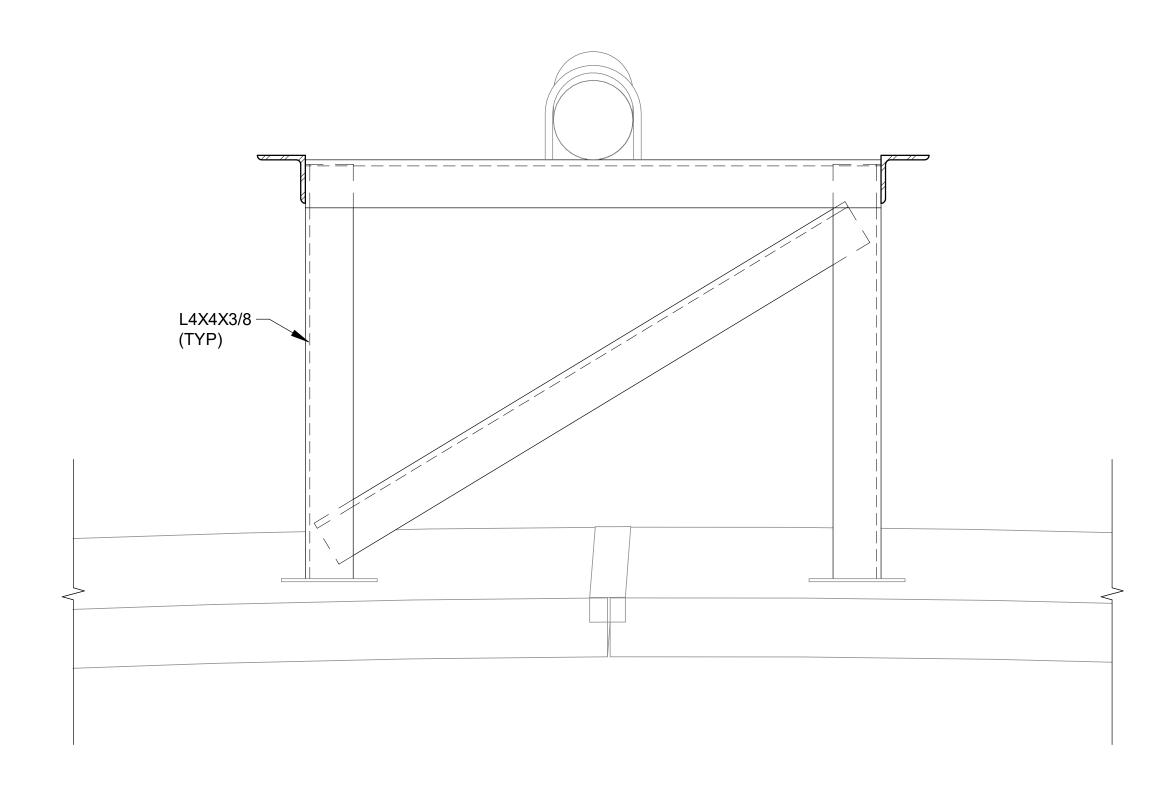
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ANAEROBIC DIGESTER PIPE SUPPORT NO. 3 REHABILITATION DETAIL AND SECTION


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DRAWING NUMBER

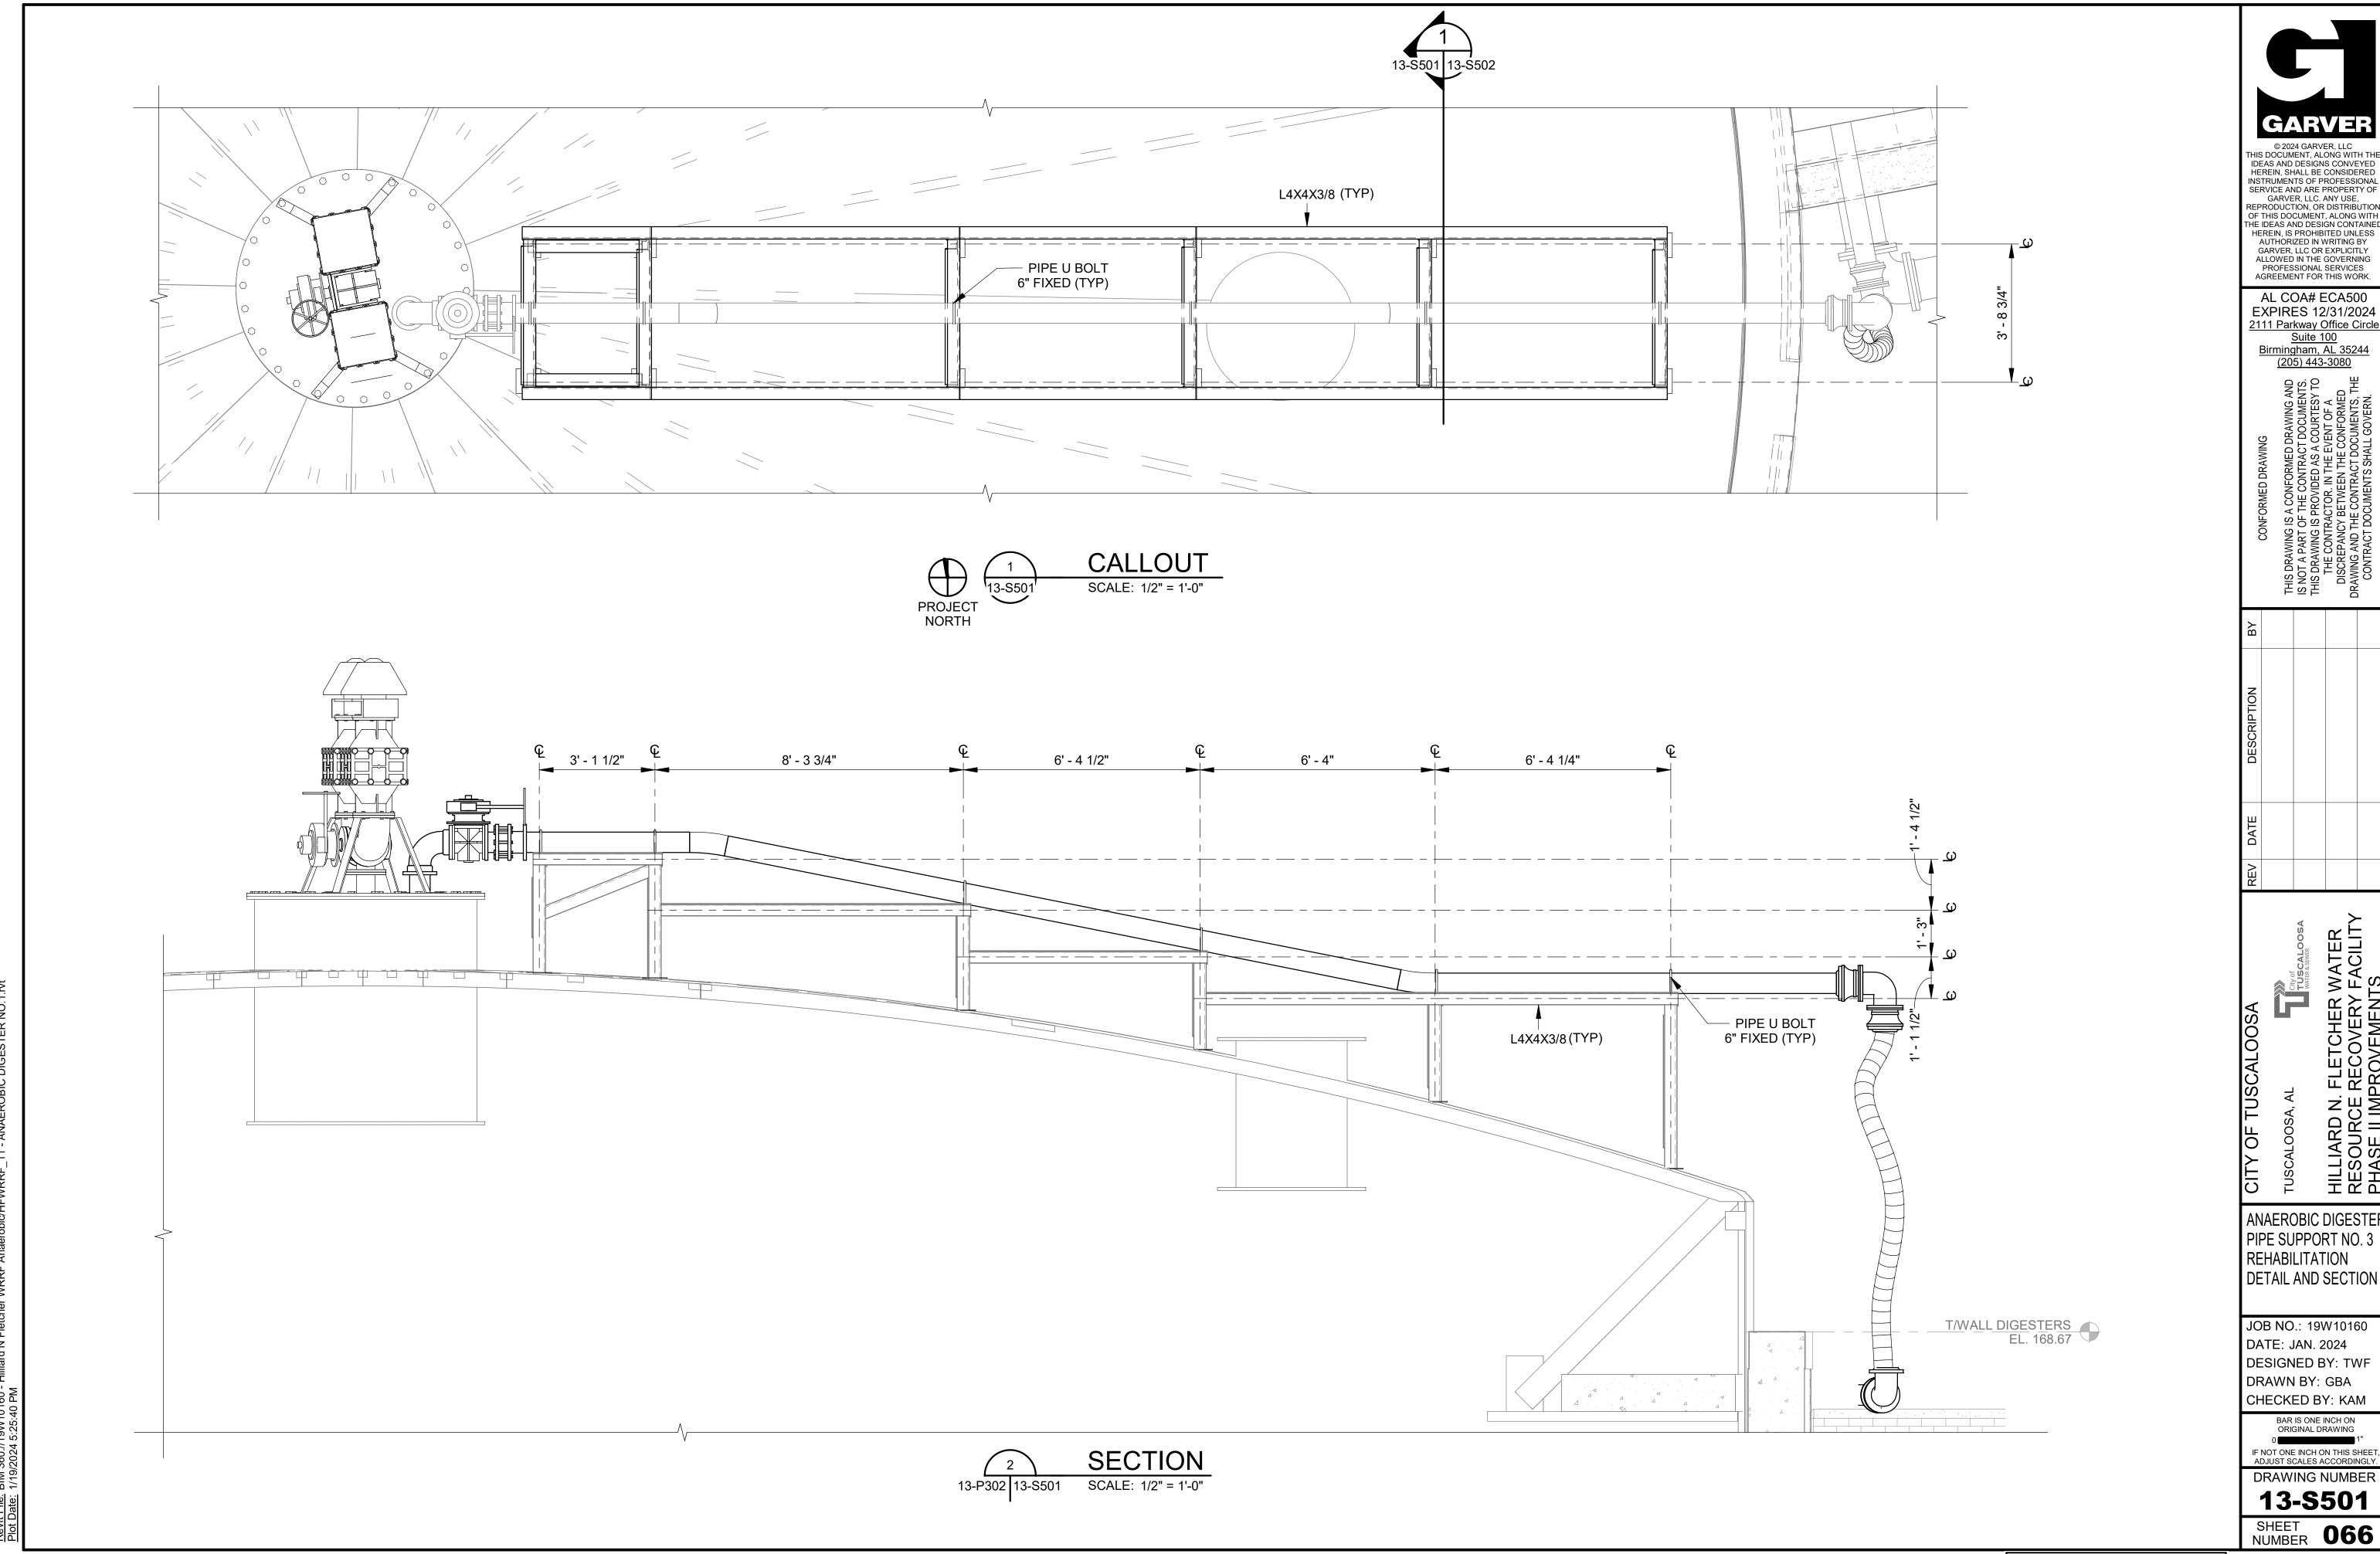SHEET 066






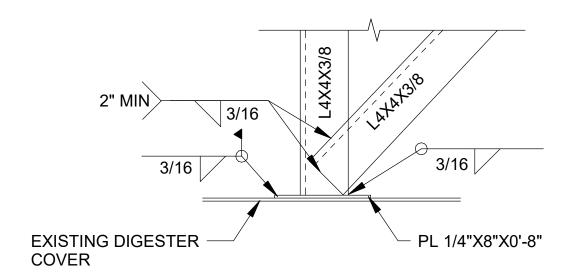

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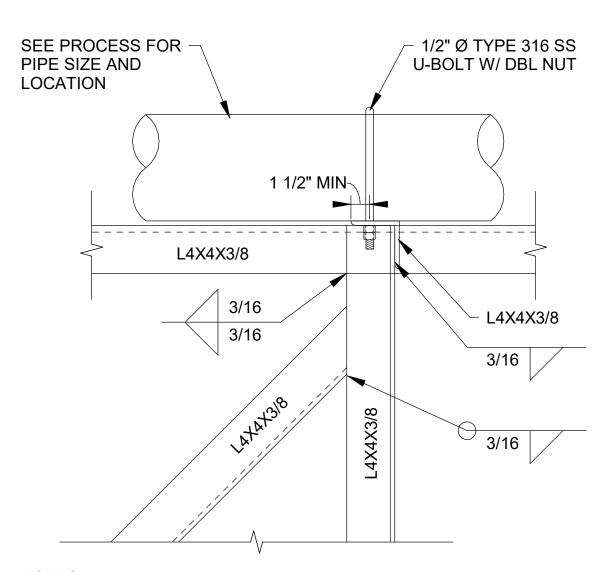
- 1. THOROUGHLY CLEAN EXISTING DIGESTER COVER PRIOR TO WELDING
- 2. AFTER INSTALLATION, APPLY COLD GALVANIZING COMPOUND TO ANY WELDS OR DAMAGED AREAS



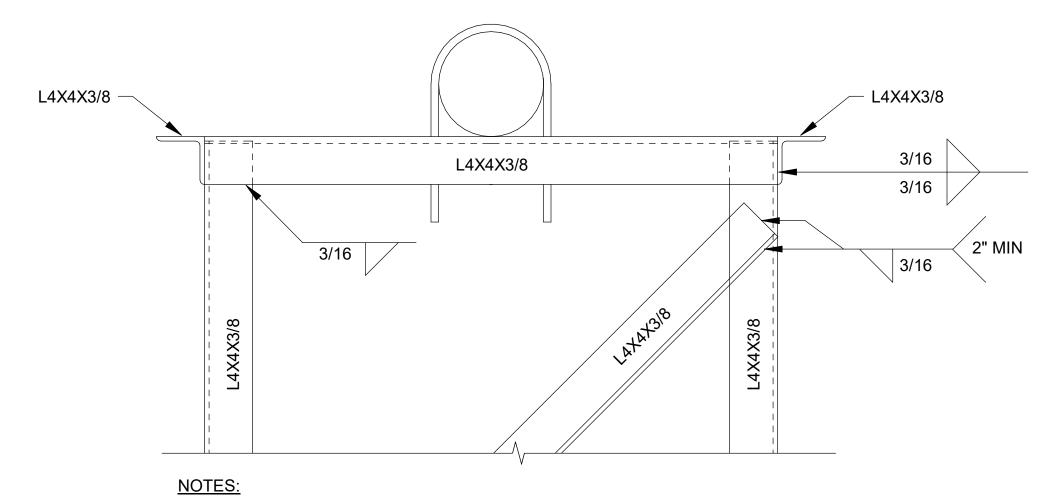

1. AFTER INSTALLATION, APPLY COLD GALVANIZING COMPOUND TO ANY WELDS OR DAMAGED AREAS





NOTES:

1. AFTER INSTALLATION, APPLY COLD GALVANIZING COMPOUND TO ANY WELDS OR DAMAGED AREAS



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ON. FLETCHER WATER

CE RECOVERY FACILITY

ANAEROBIC DIGESTER
PIPE SUPPORT NO.3
REHABILITATION
DETAIL


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OVERALL ANAEROBIC DIGESTION REHABILITATION PLAN


JOB NO.: 19W10160
DATE: JAN. 2024
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DRAWN BY: WTL
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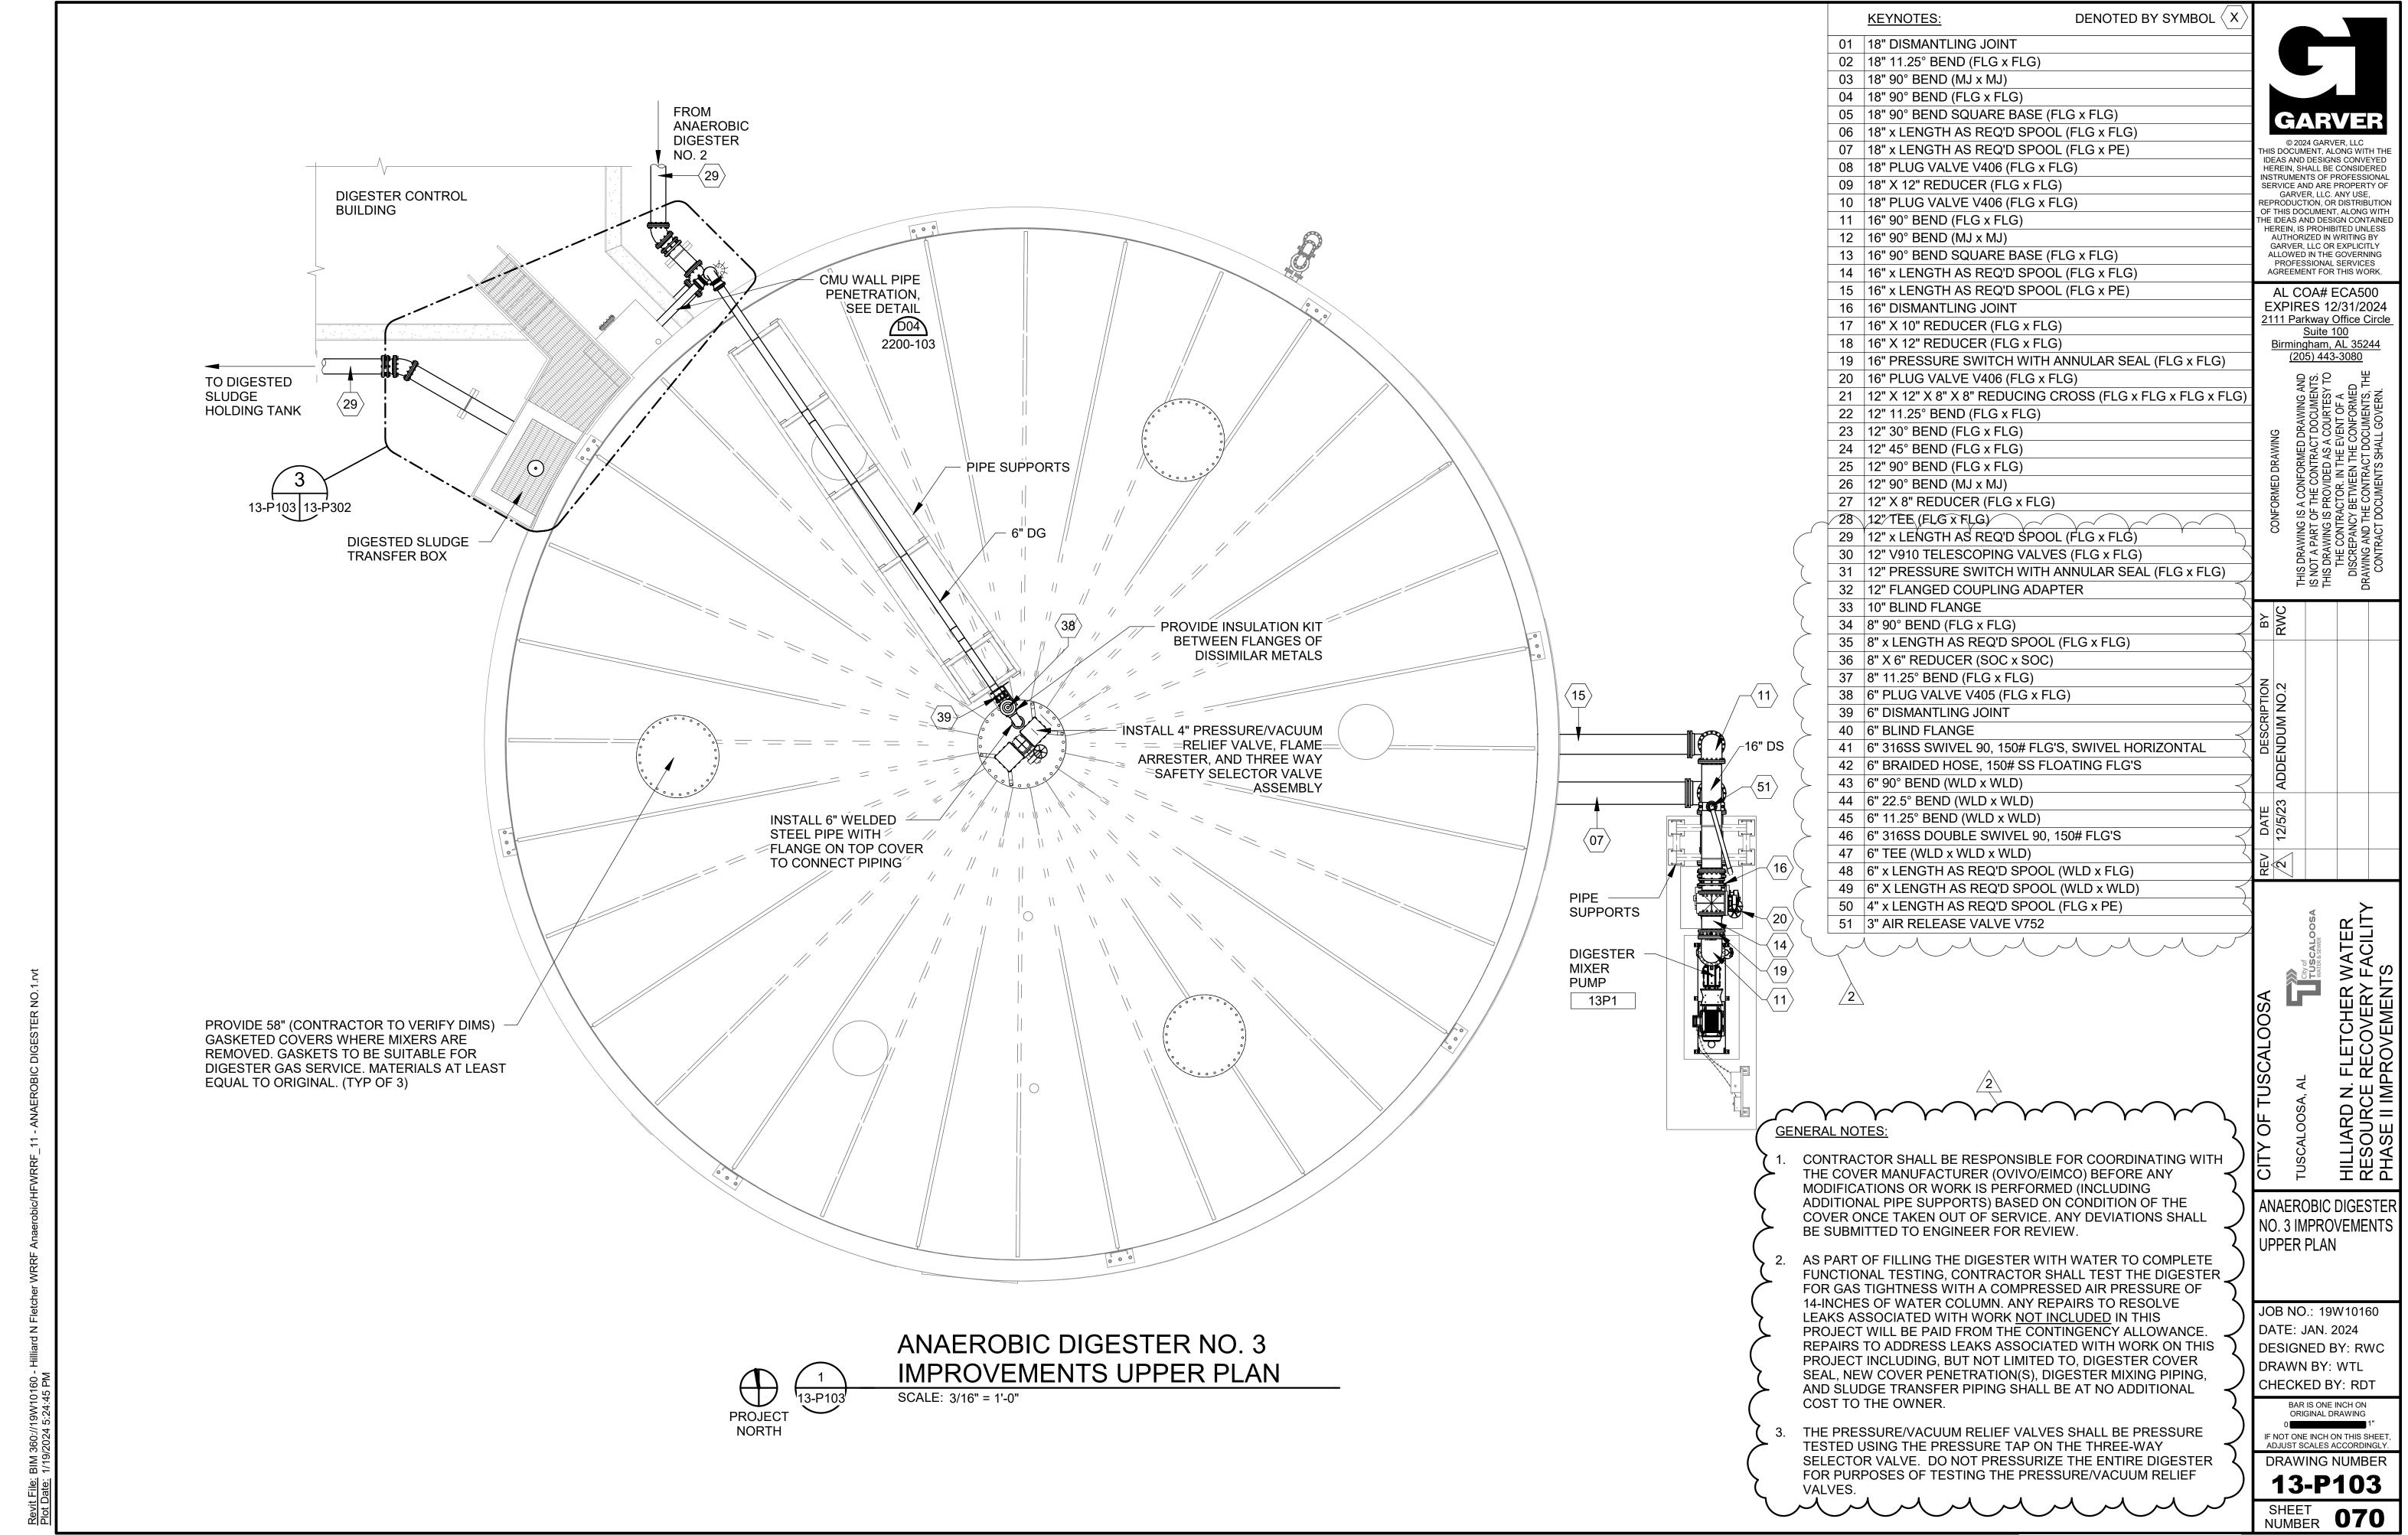
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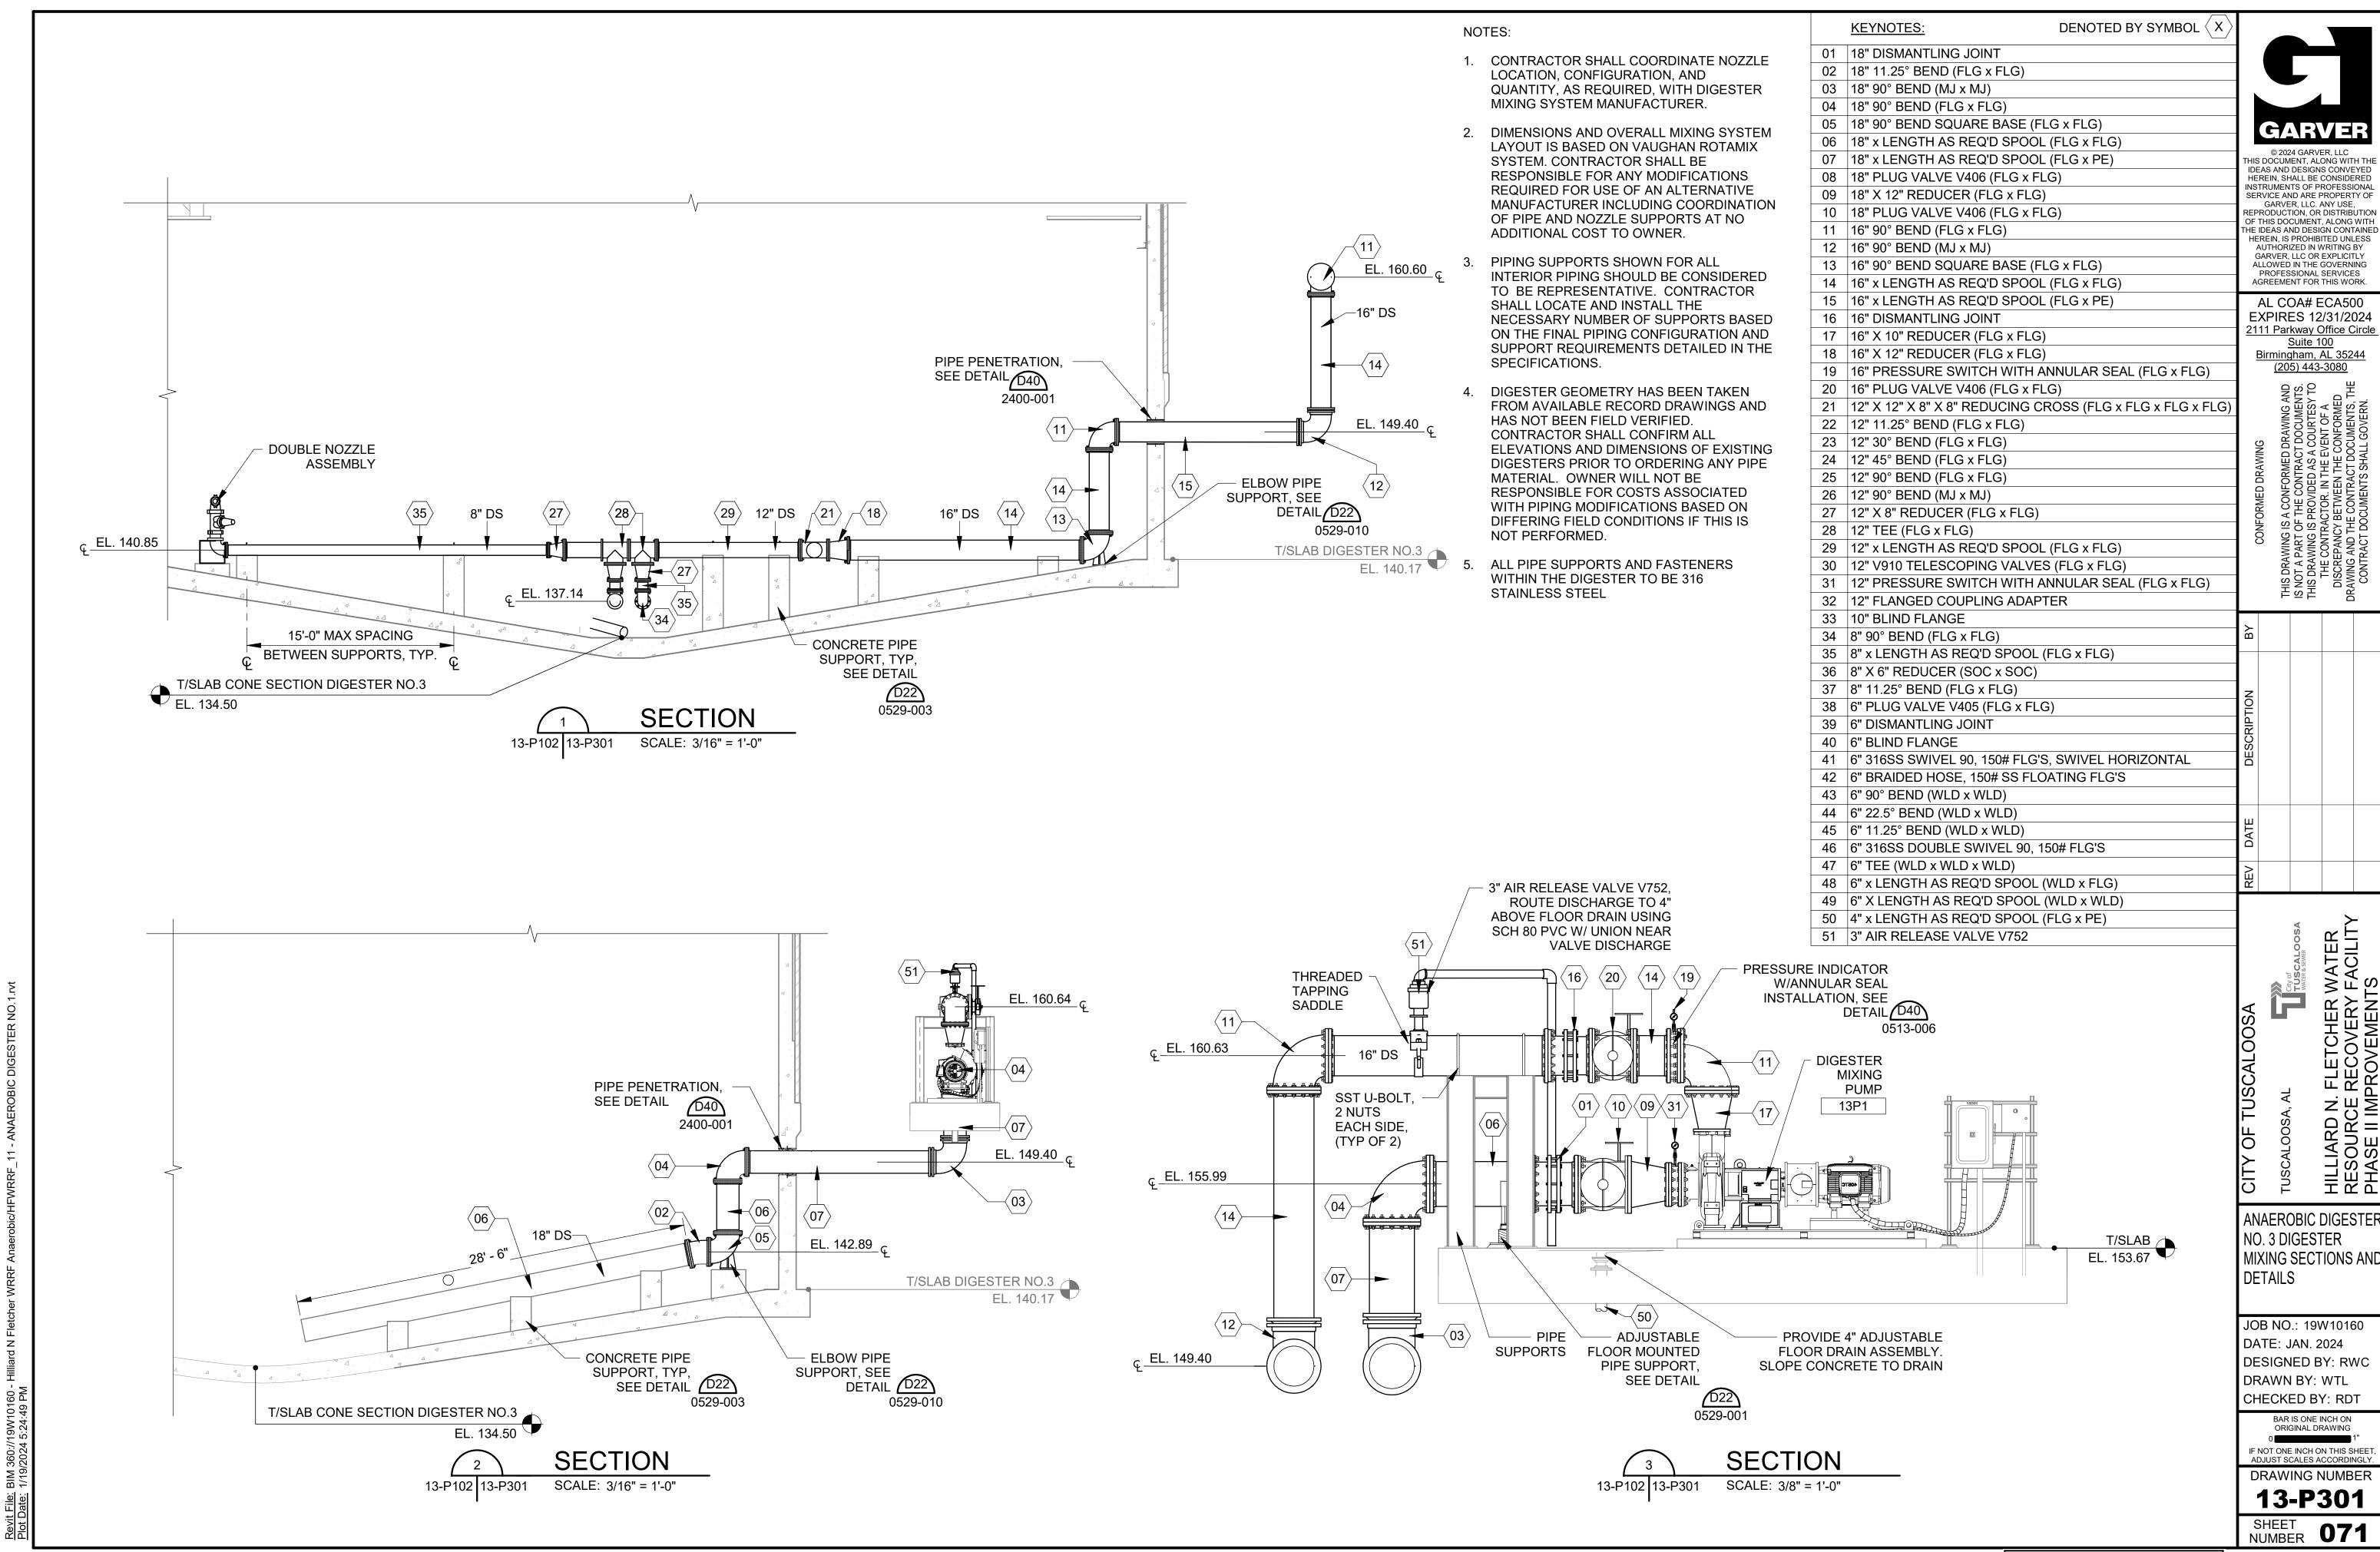
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SHEET 068





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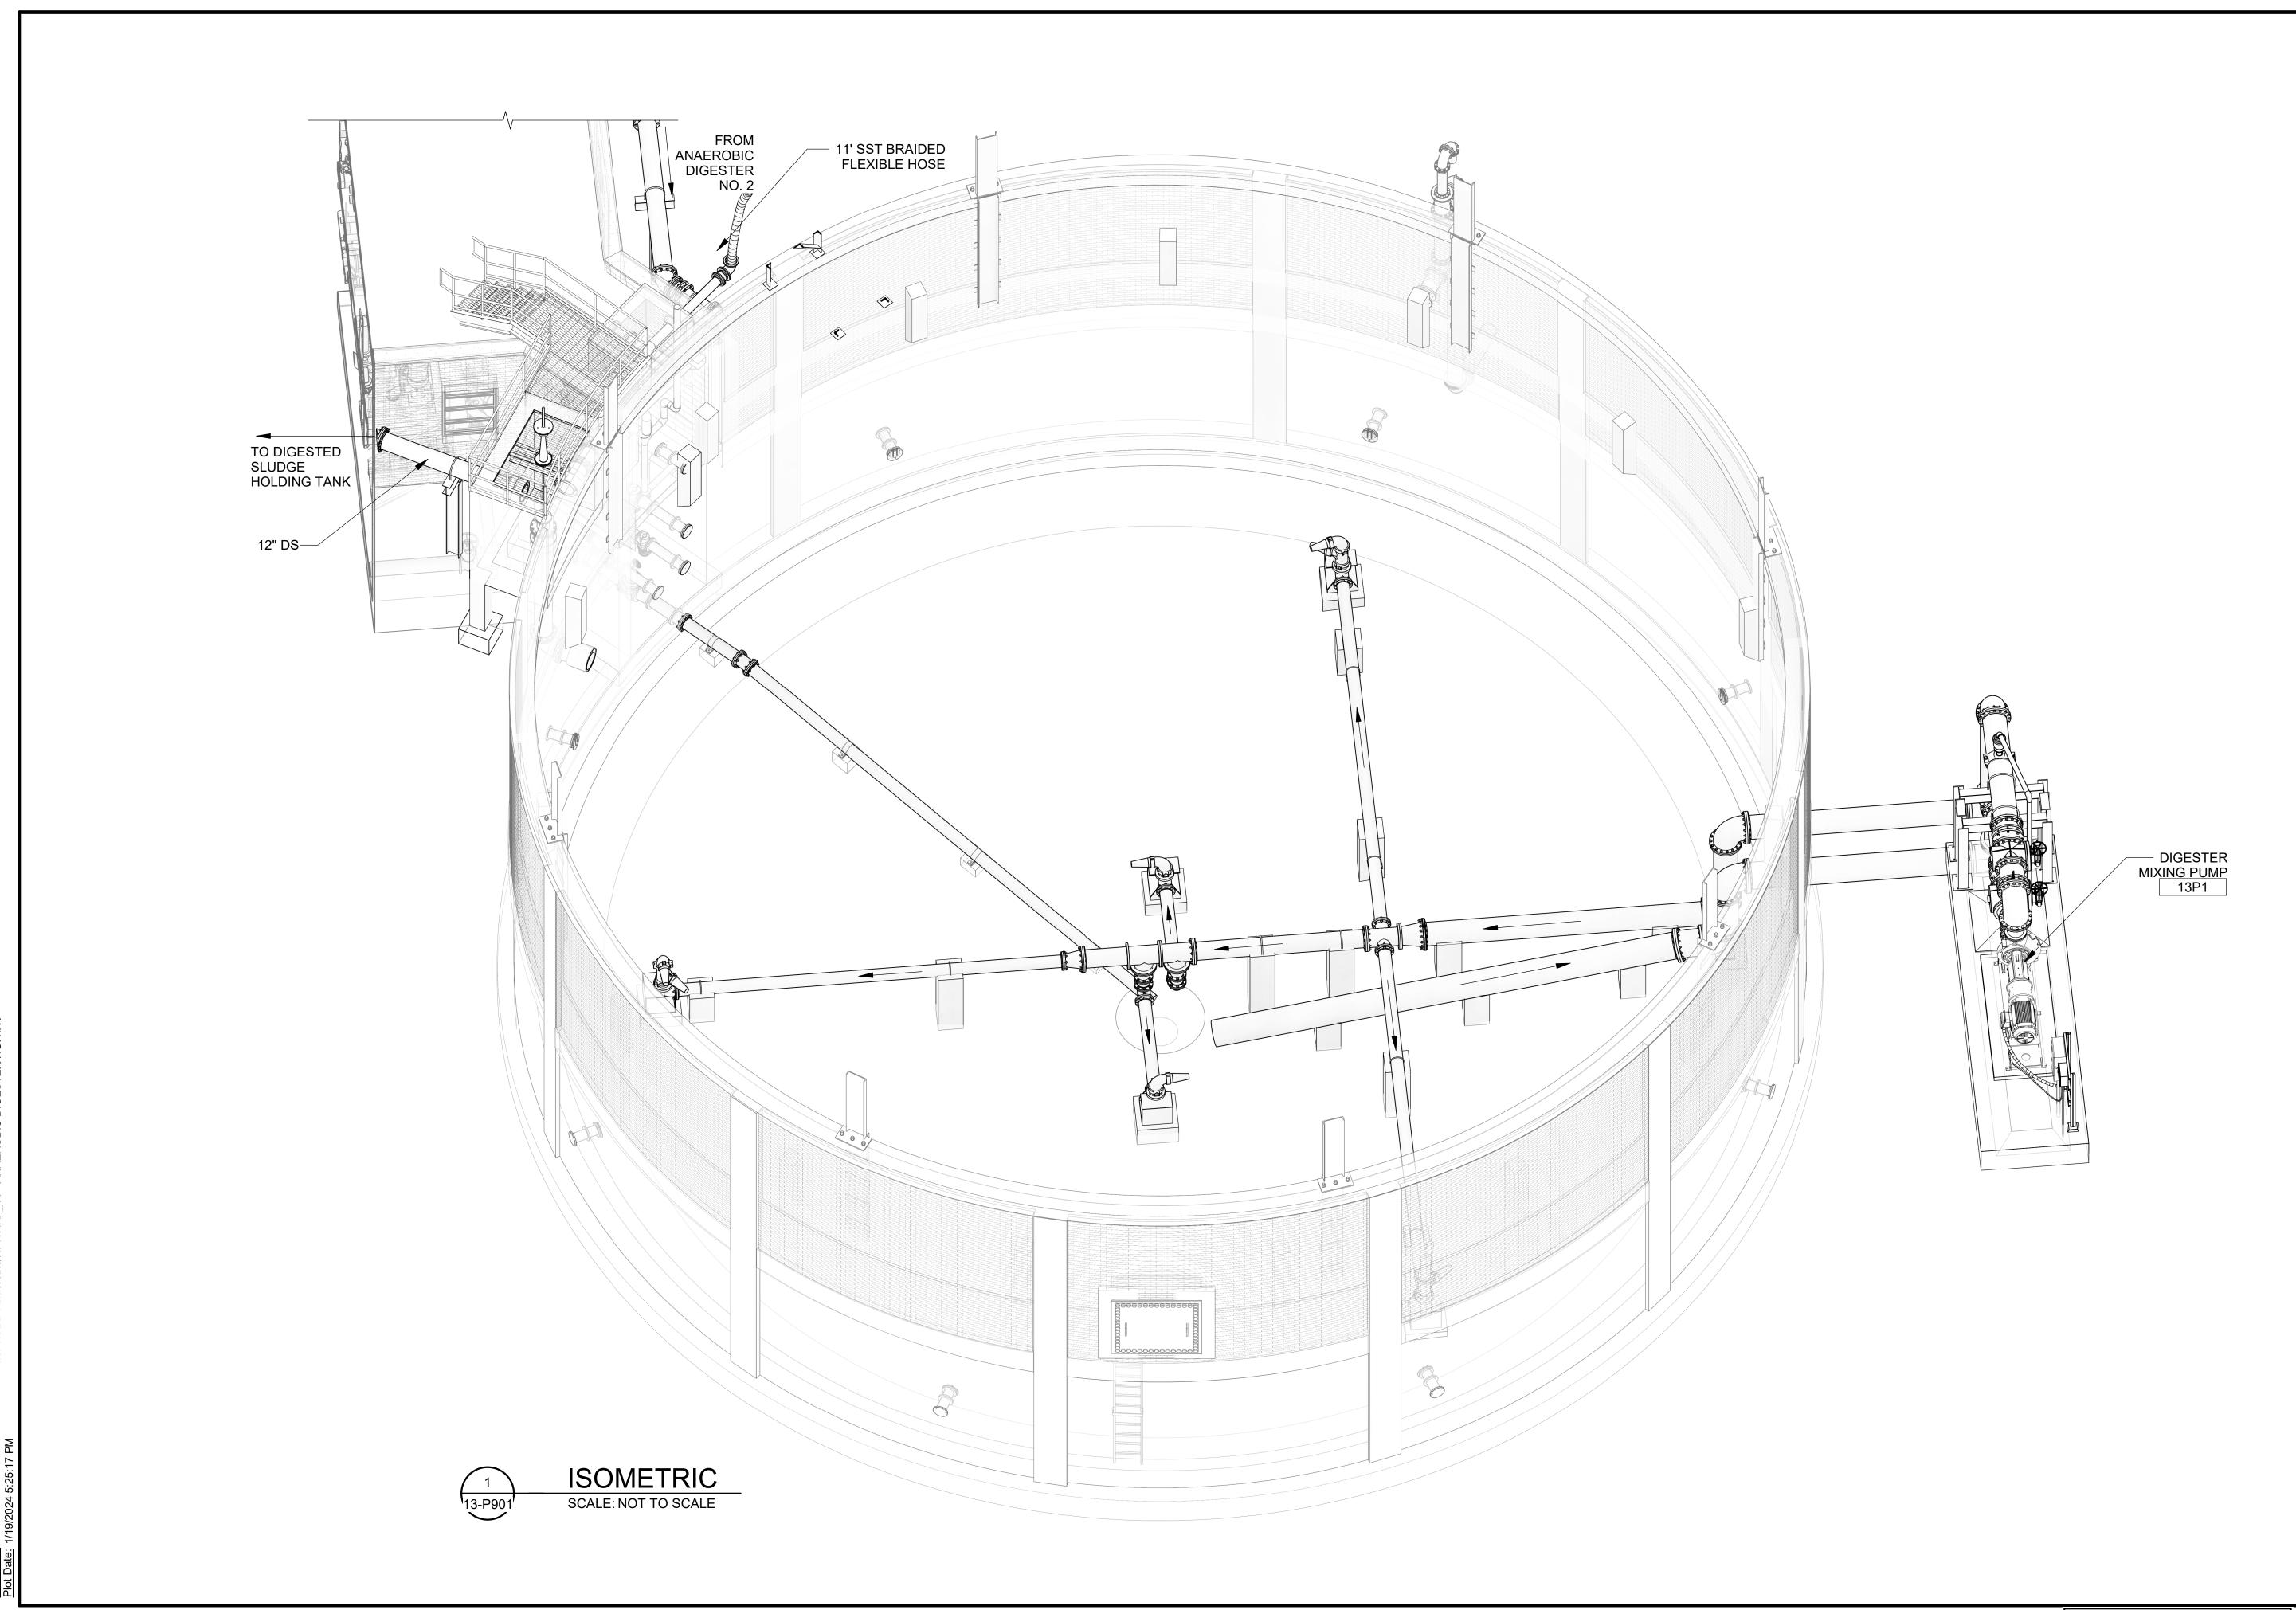


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ANAEROBIC DIGESTER NO. 3 DIGESTER MIXING ISOMETRICS

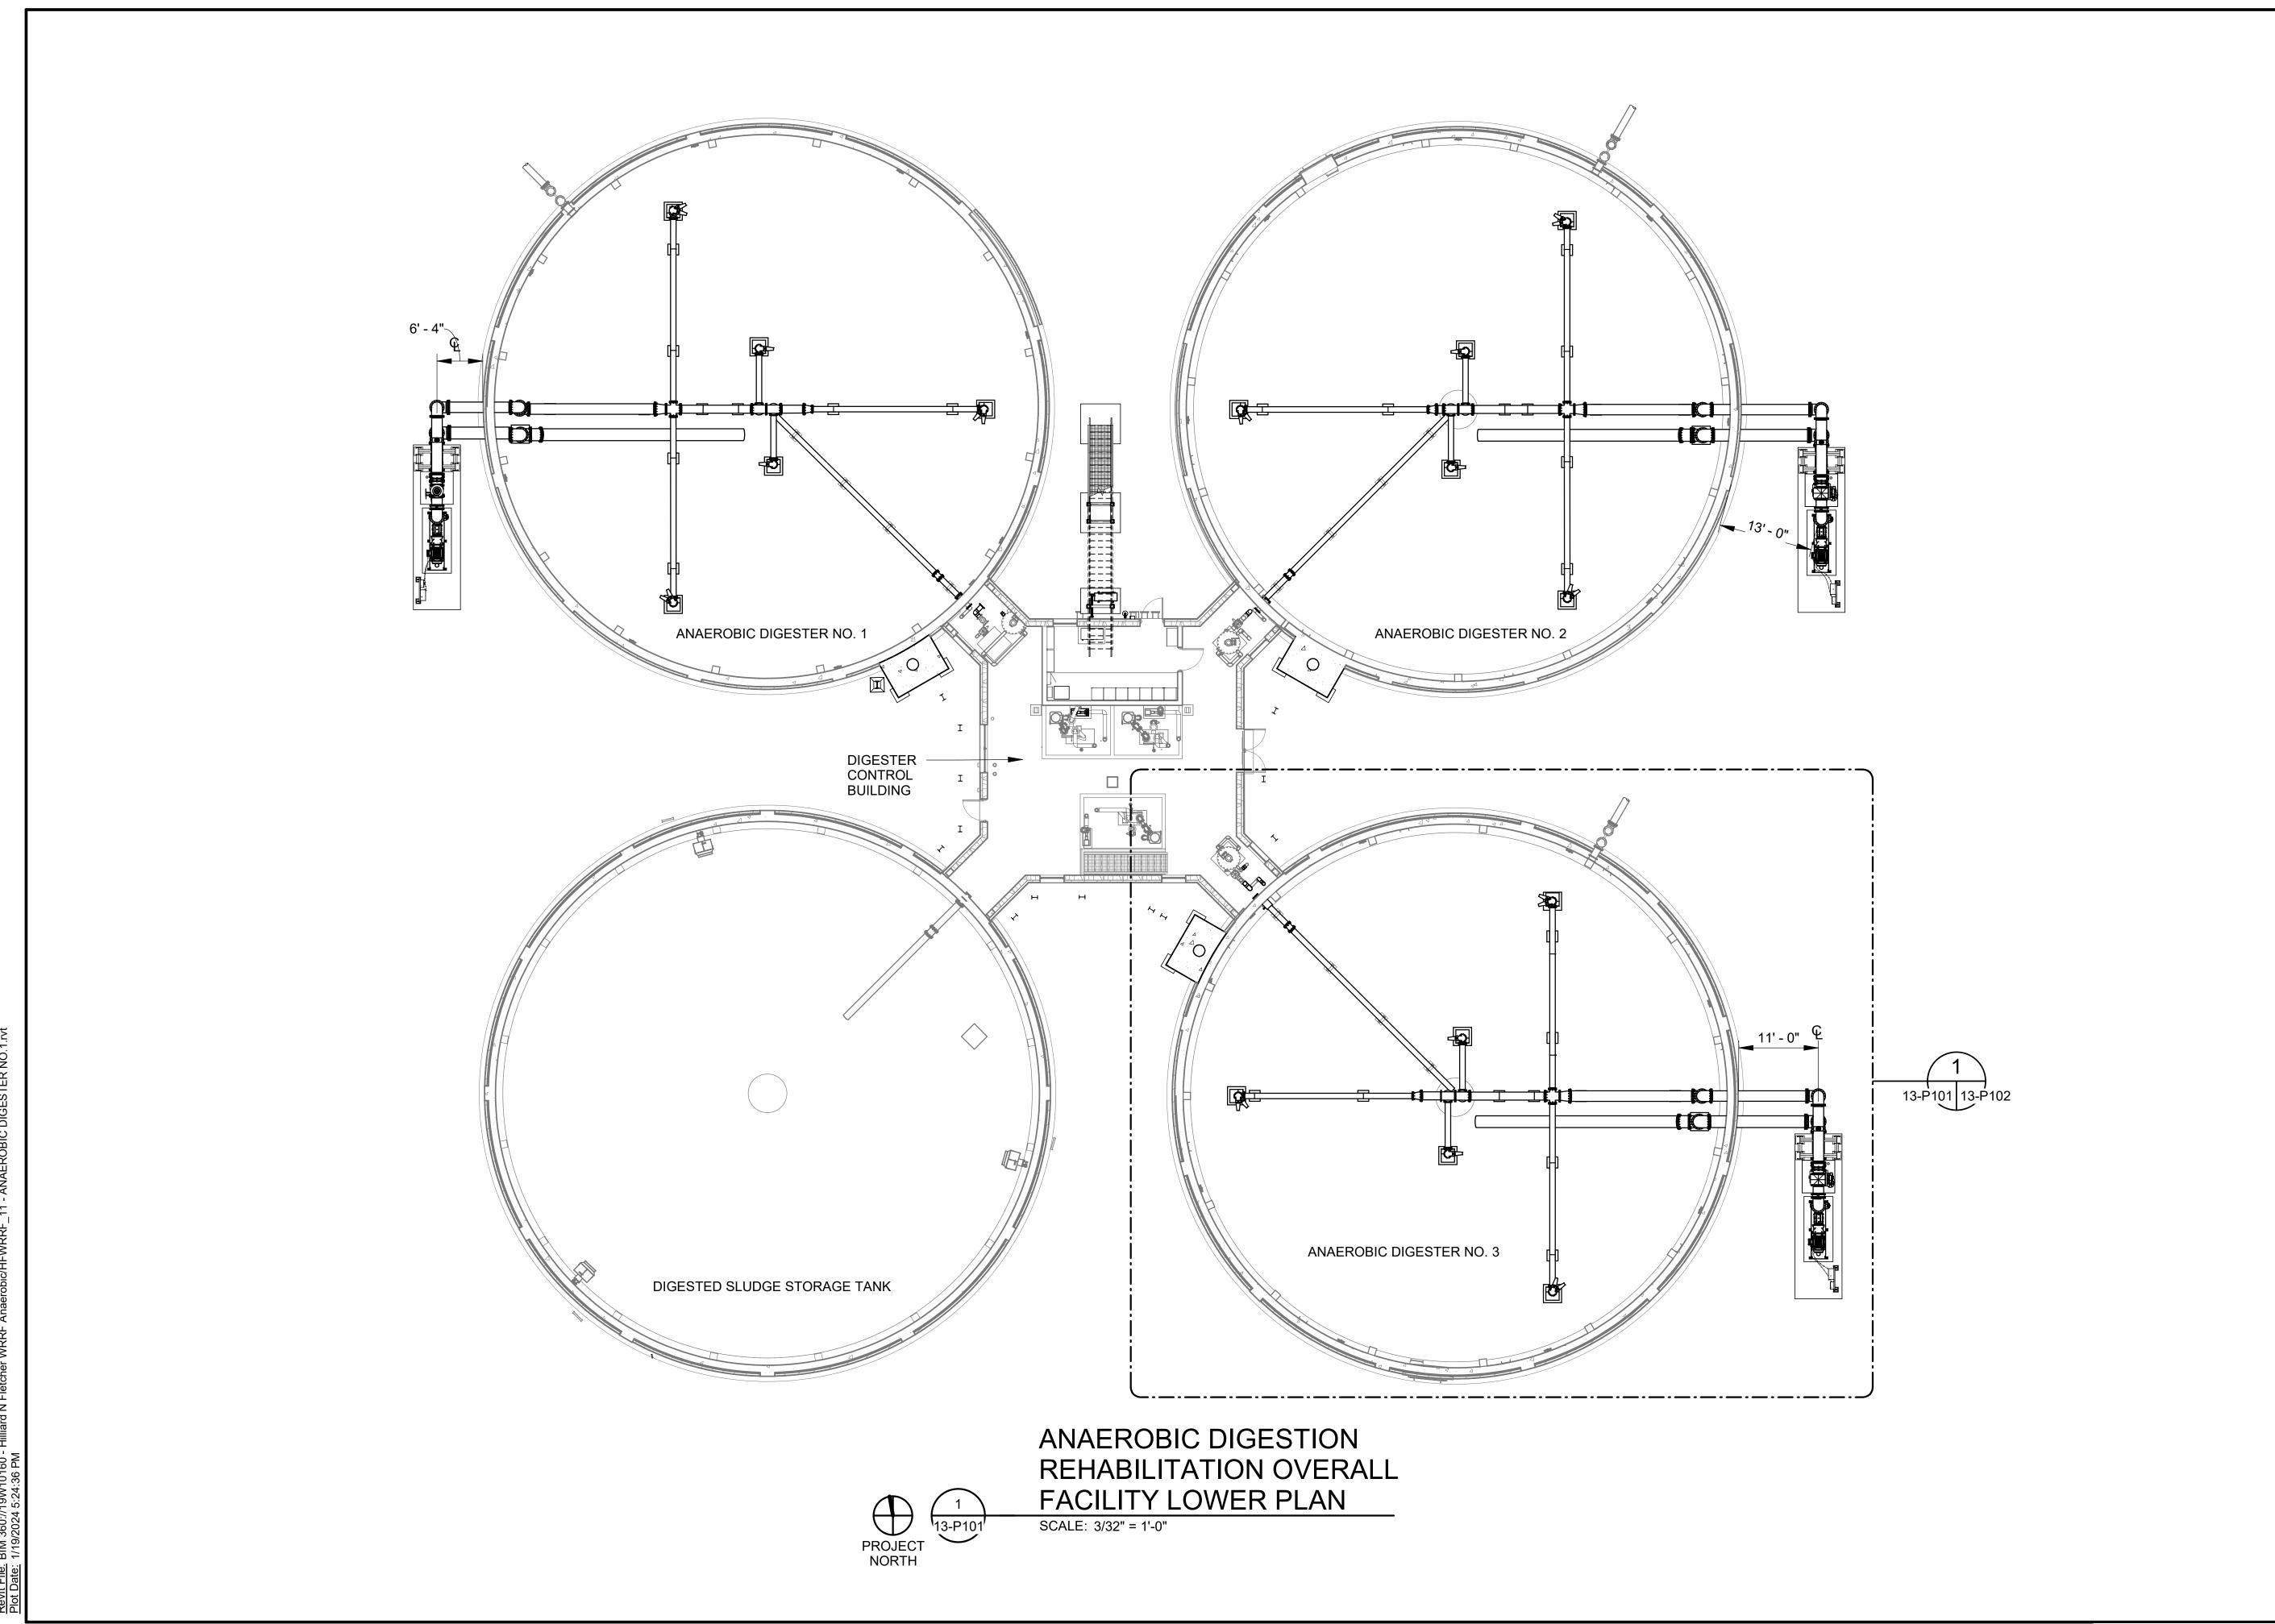
JOB NO.: 19W10160 DATE: JAN. 2024 DESIGNED BY: RWC DRAWN BY: WTL CHECKED BY: RDT
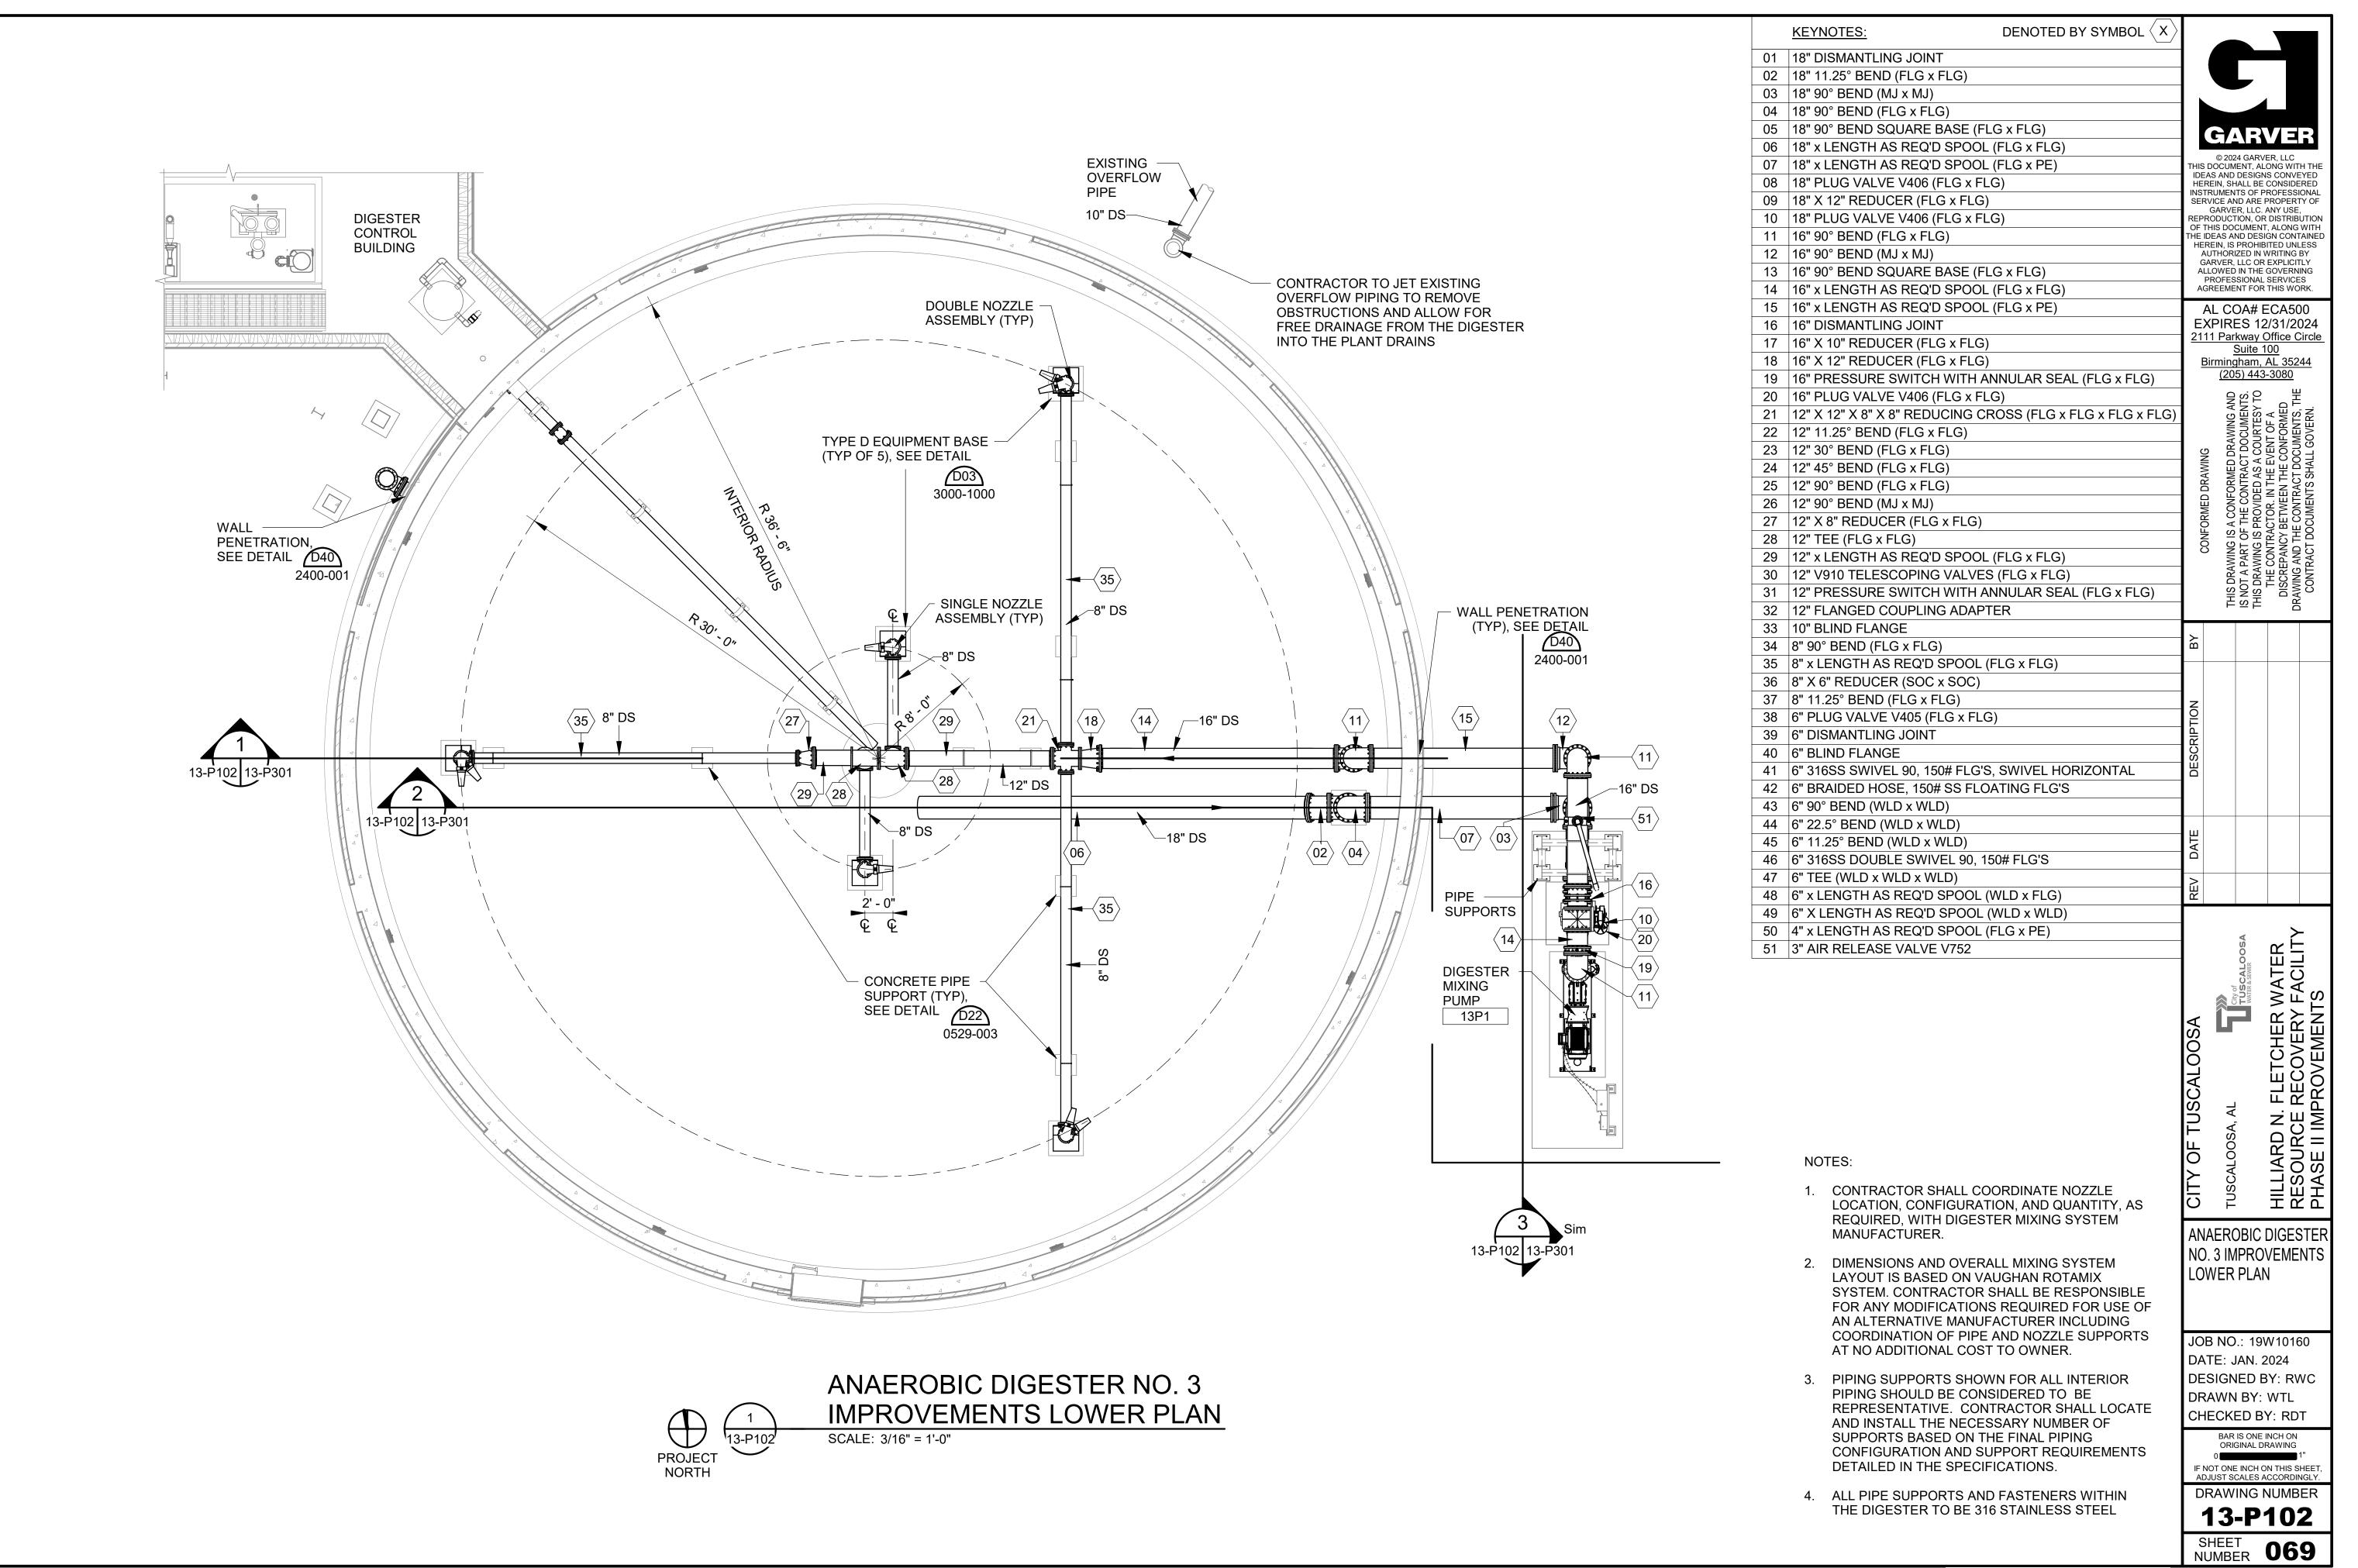
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ANAEROBIC DIGESTER NO. 3 DIGESTER COVER BIOGAS PIPING ISOMETRIC

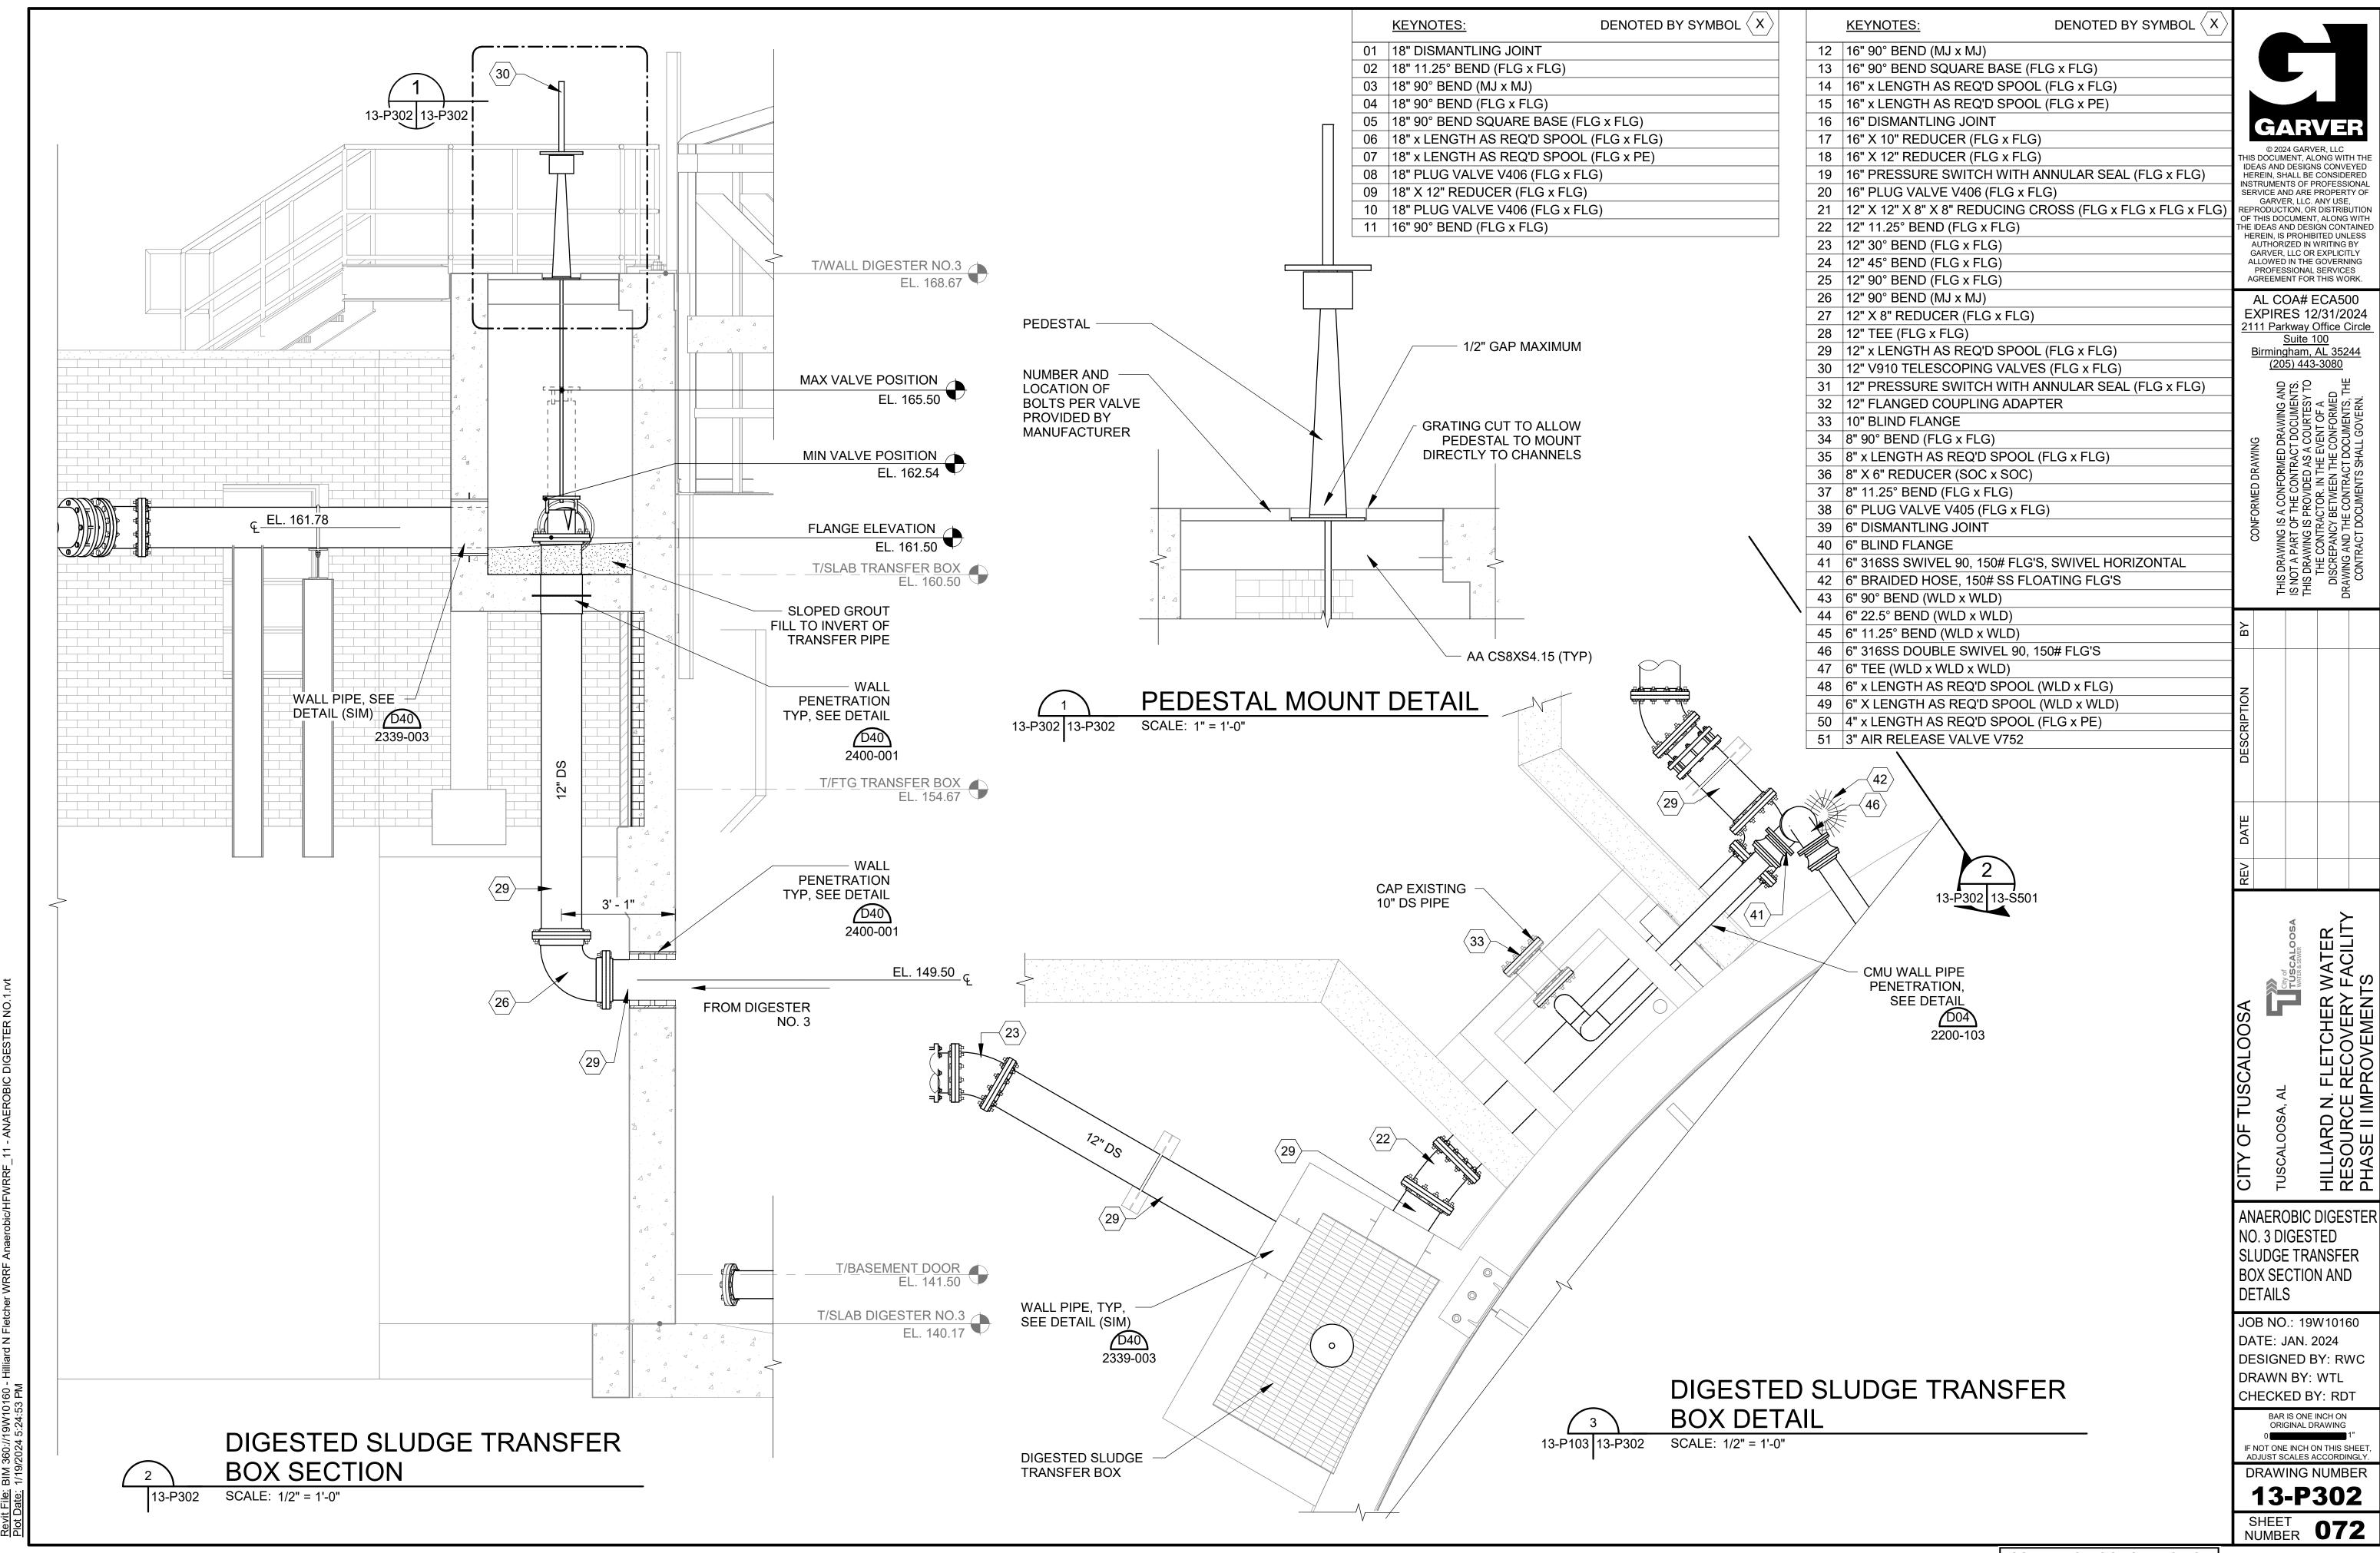
JOB NO.: 19W10160 DATE: JAN. 2024 DESIGNED BY: RWC DRAWN BY: WTL CHECKED BY: RDT
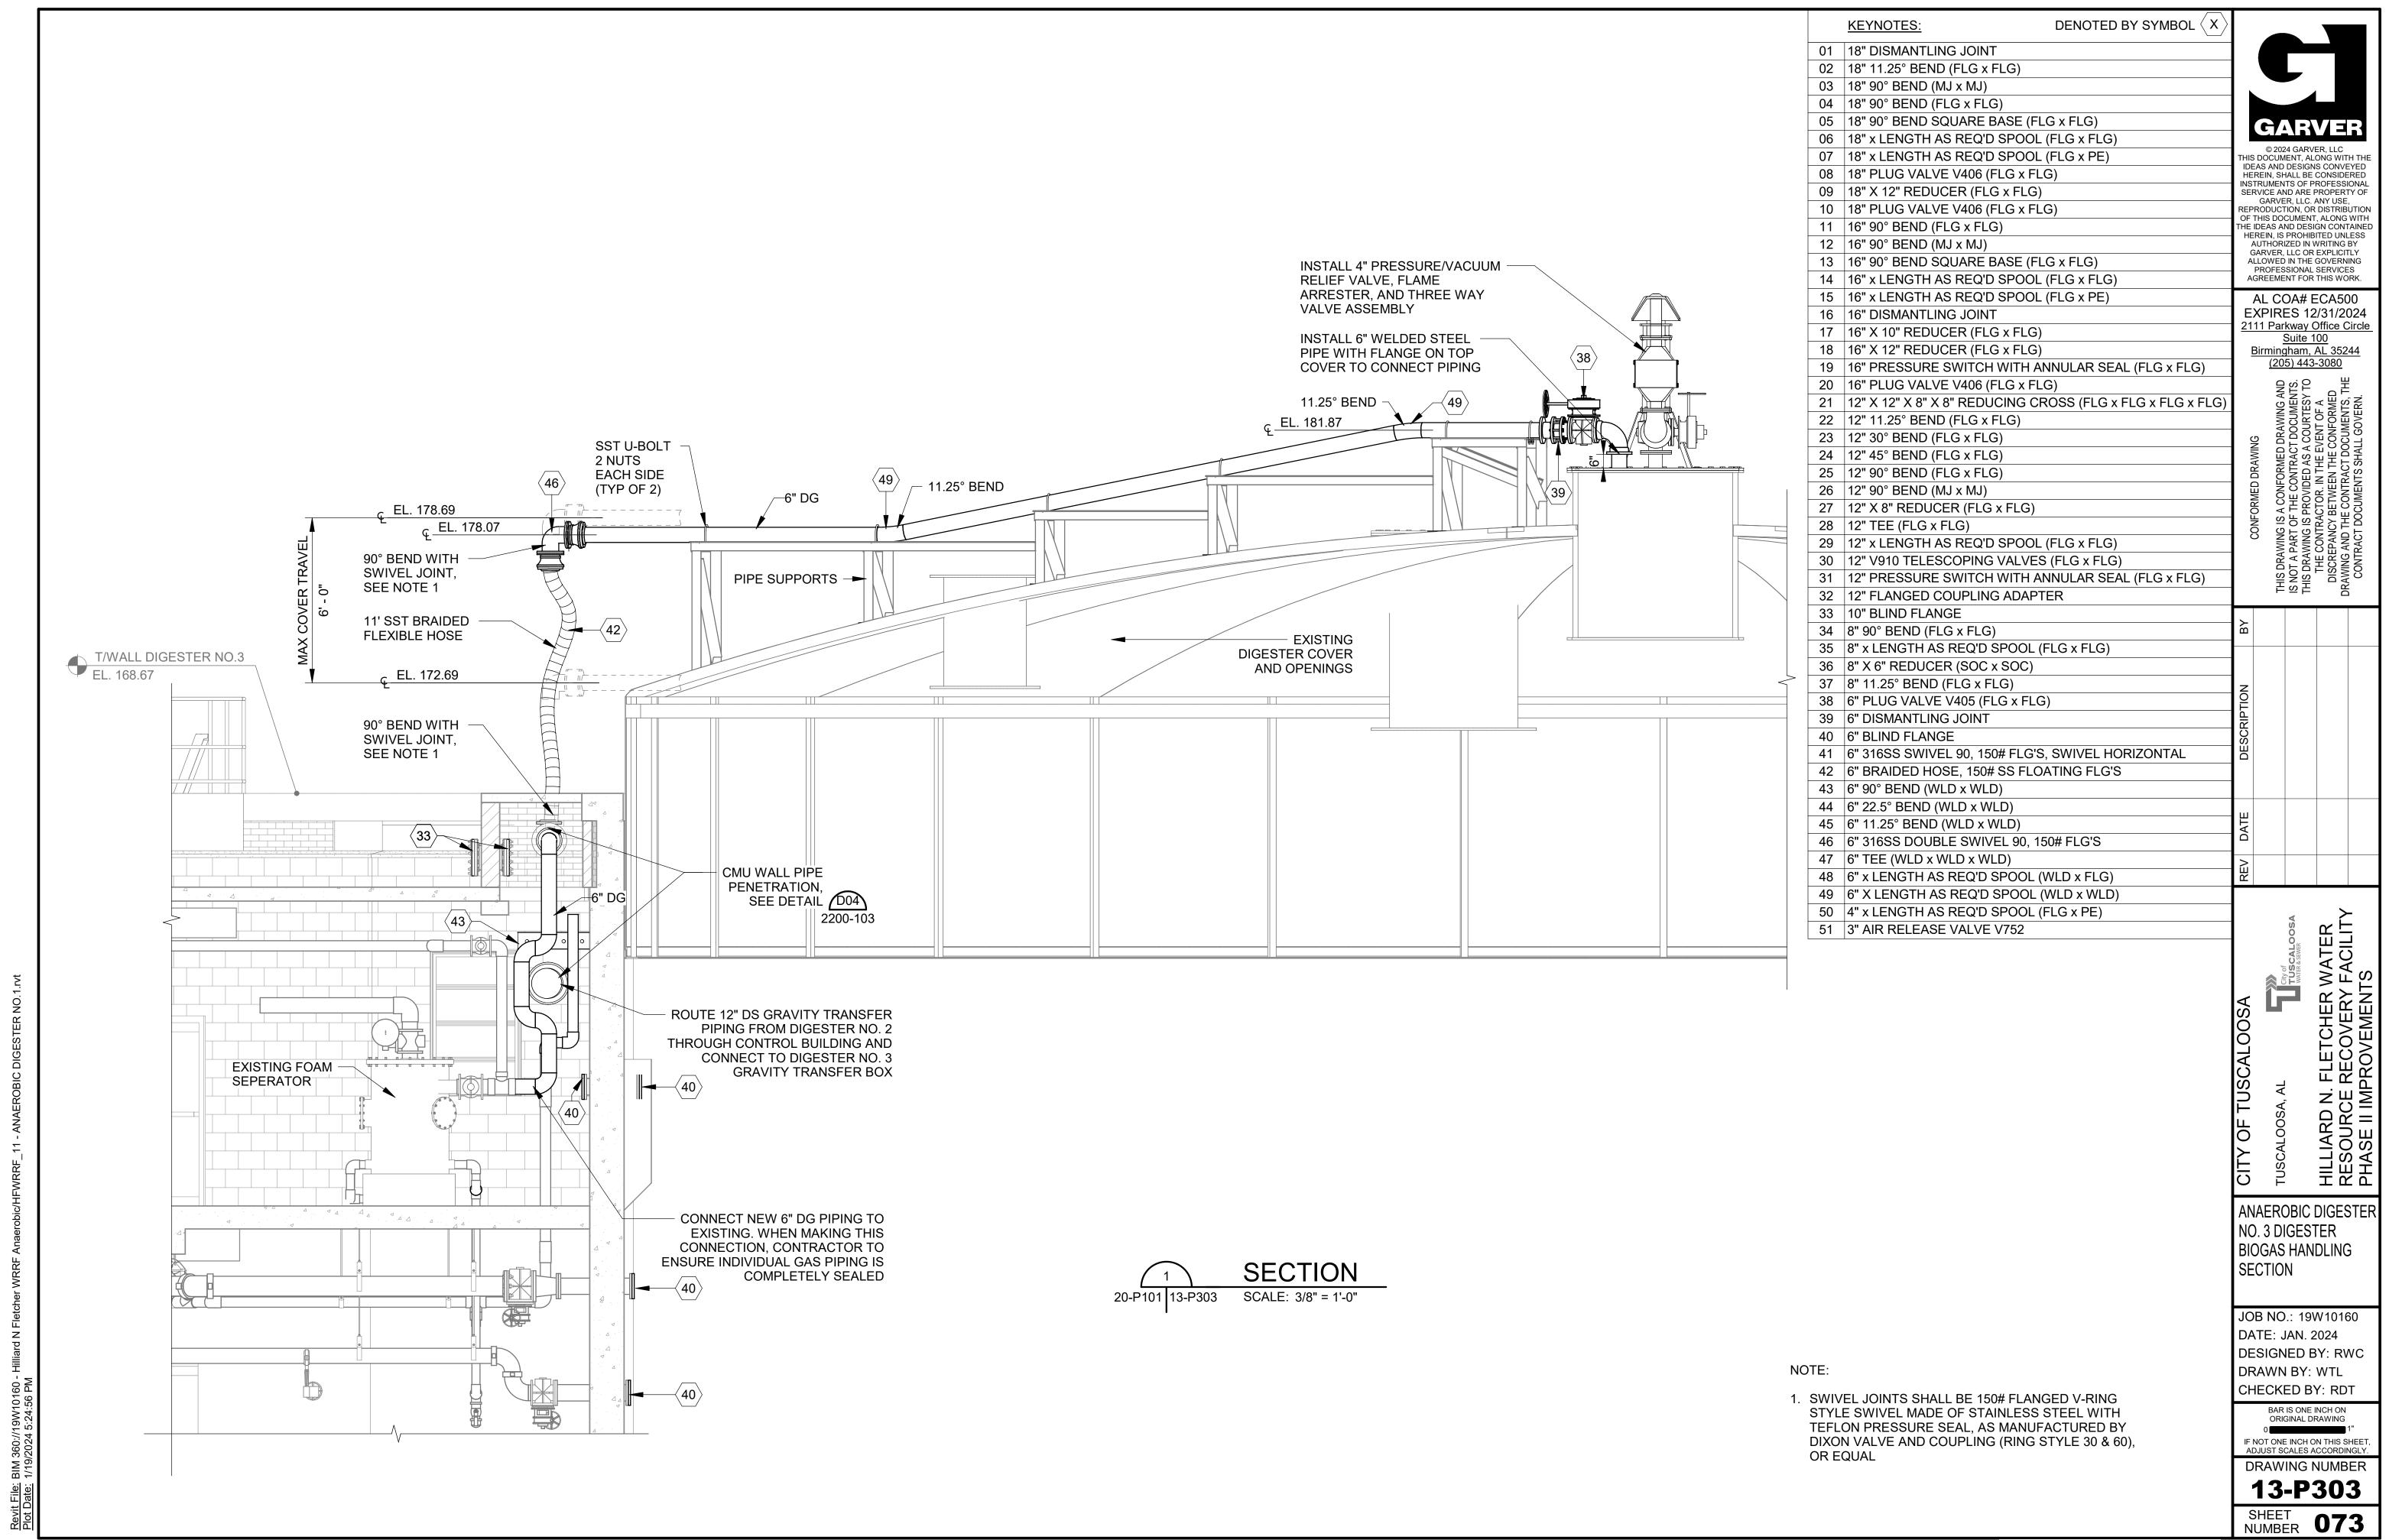
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13-P902 SHEET NUMBER 075

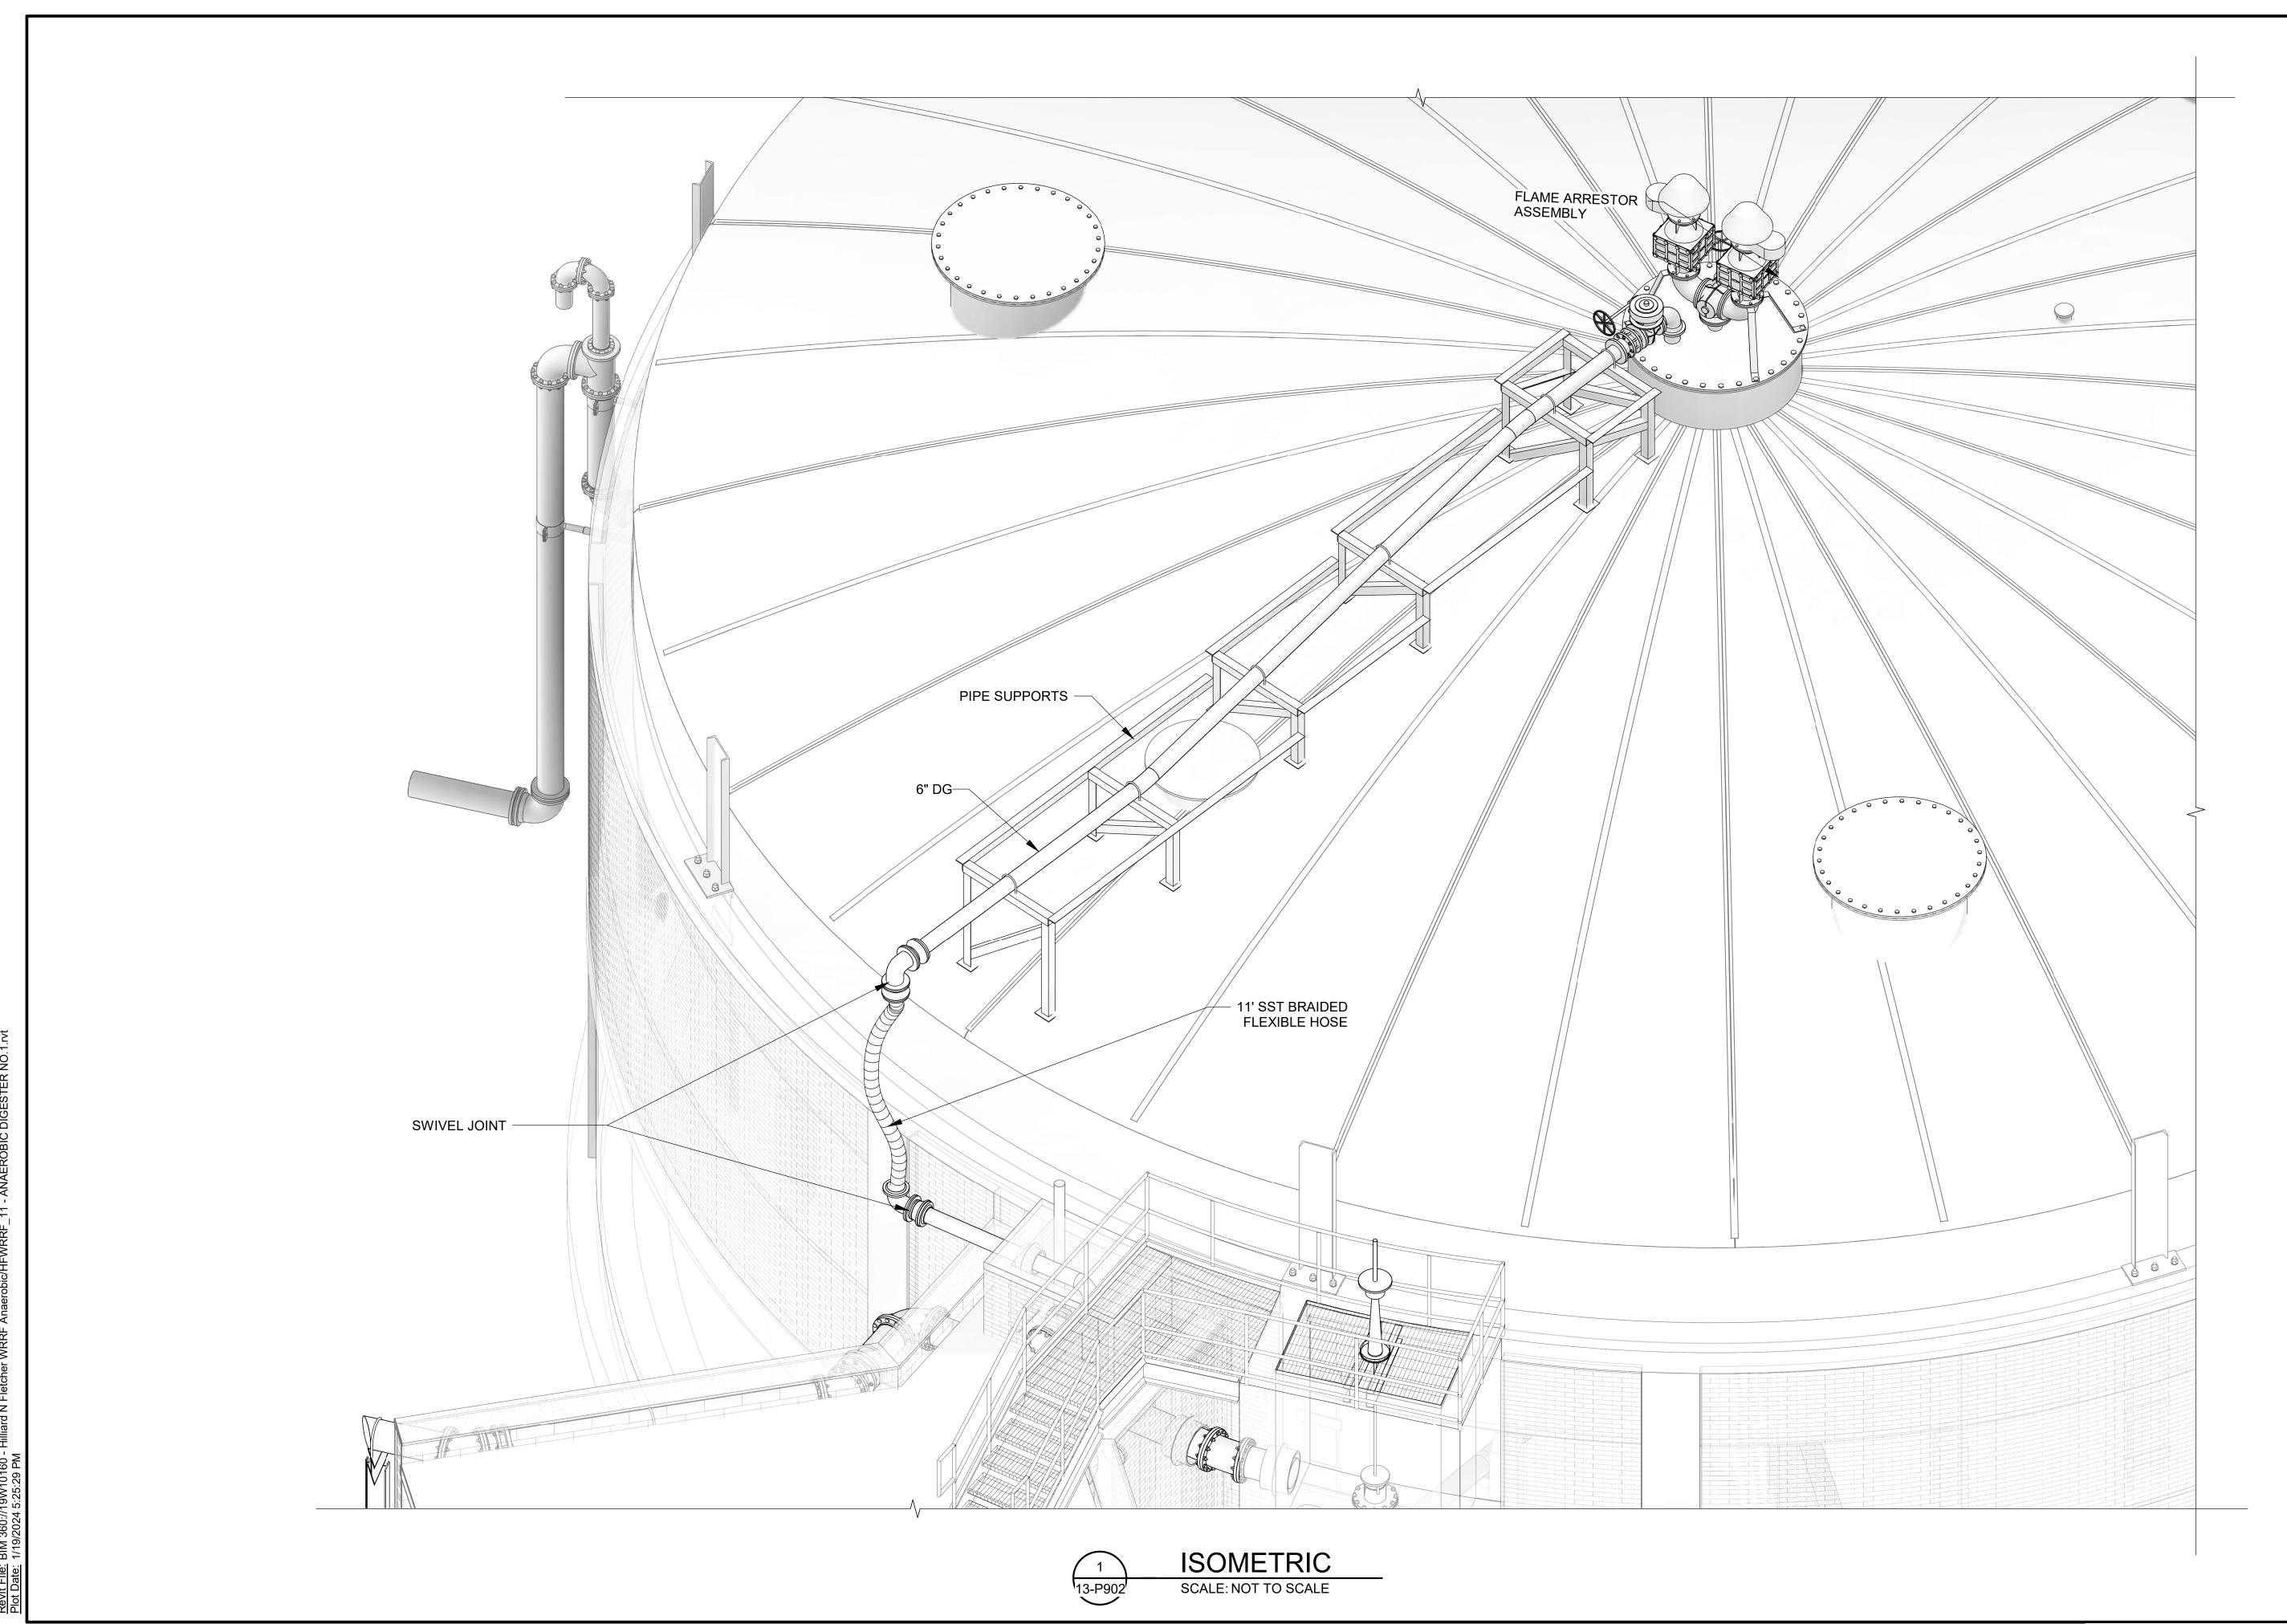

DEMOLITION ROOF PLAN

SCALE: 1/4" = 1'-0"

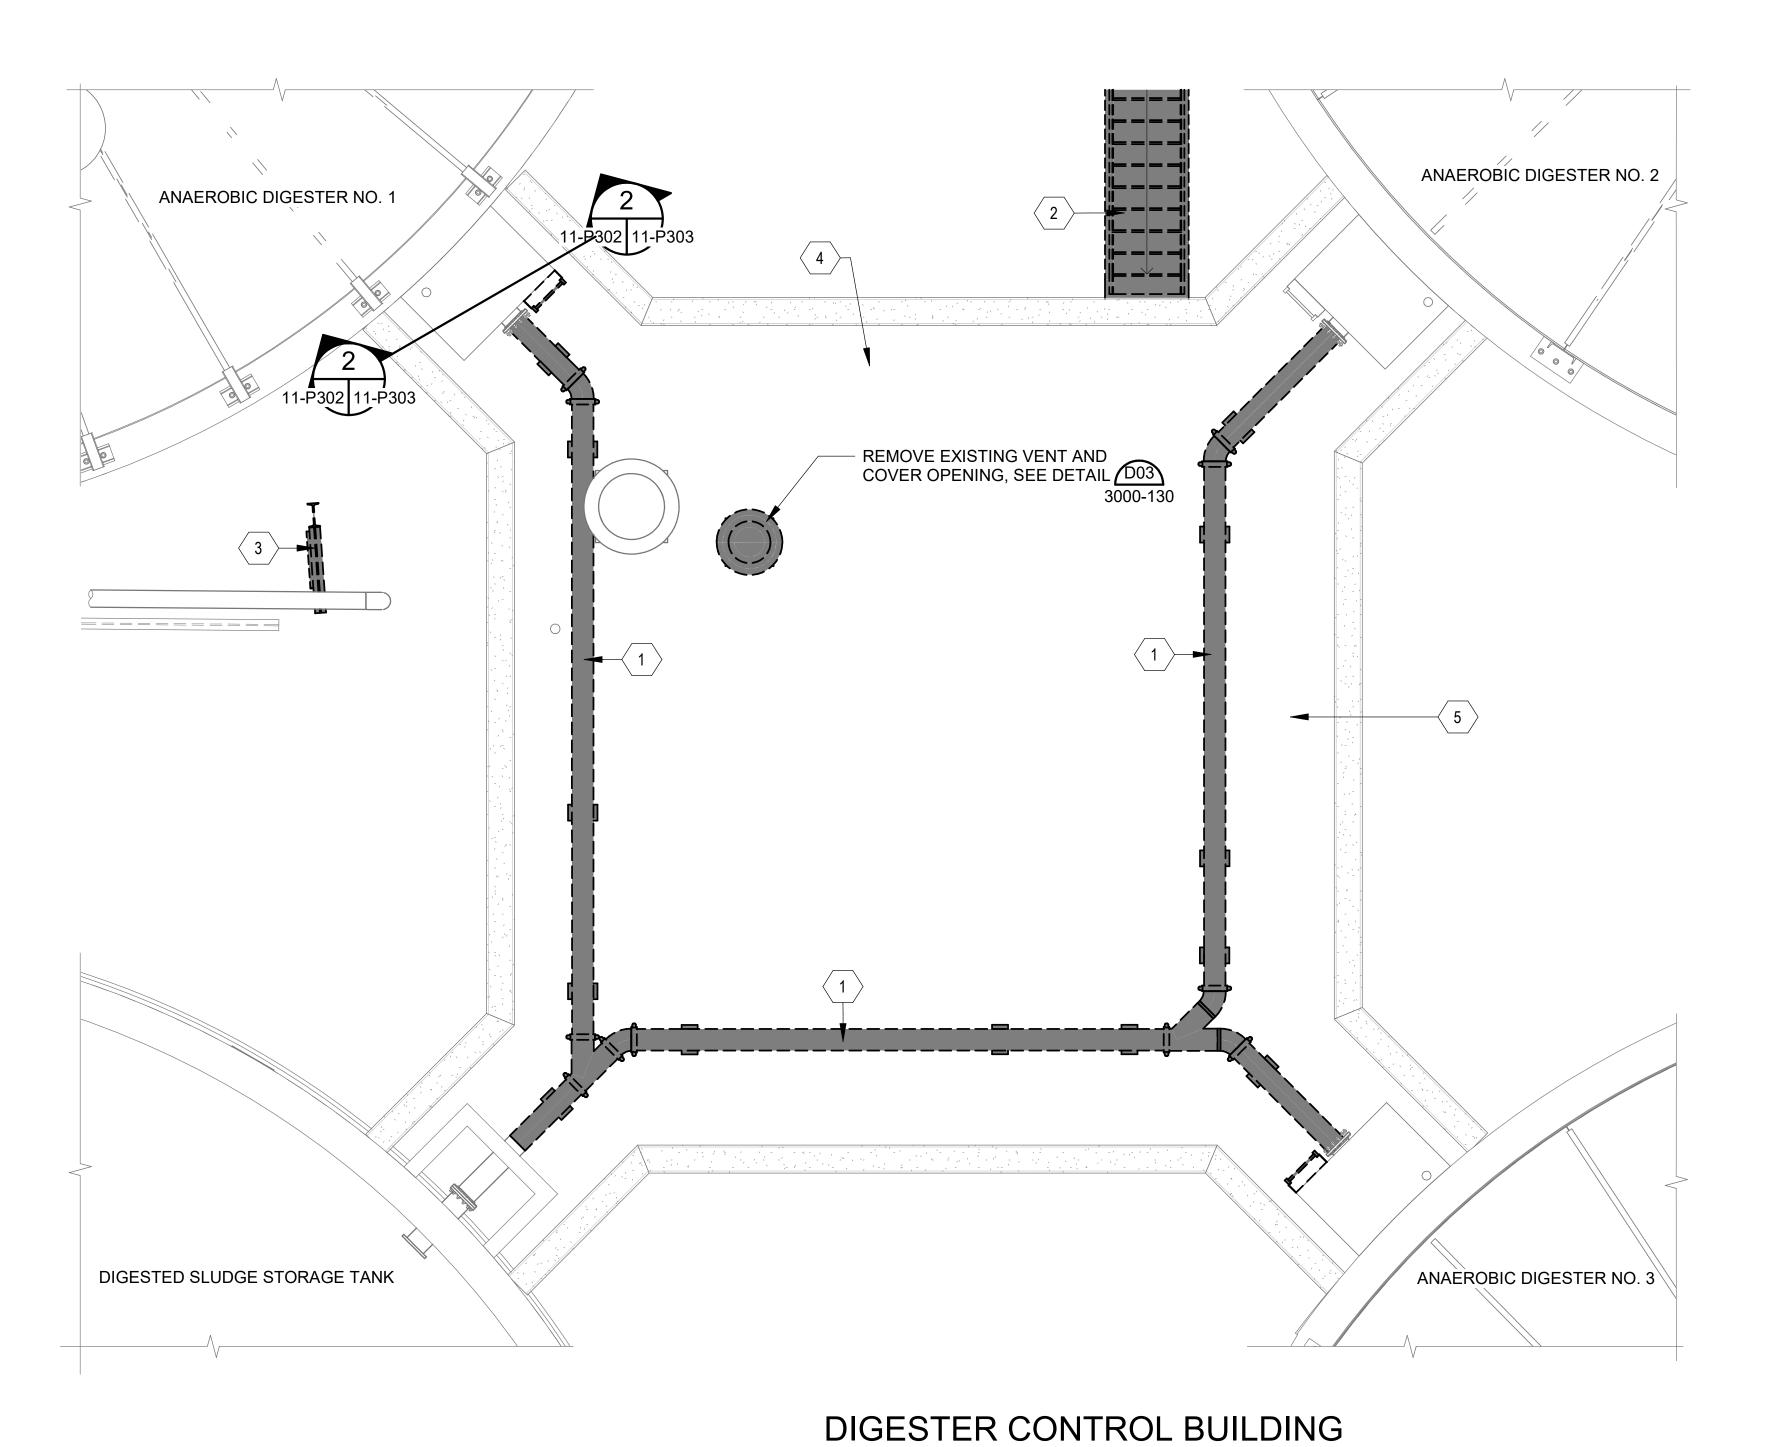PROJECT NORTH **KEYNOTES:**

DENOTED BY SYMBOL $\langle \mathsf{X}
angle$



- 1 DEMOLISH AND DISPOSE EXISTING 10" DIGESTED SLUDGE TRANSFER PIPE AND ASSOCIATED SUPPORTS ON ROOF.
- DEMOLISH AND DISPOSE EXISTING STAIRS.
 RELOCATE EXISTING PIPE SUPPORT. PROVIDE TEMPORARY PIPE SUPPORT DURING CONSTRUCTION
- 4 CLEAN AND PREP ROOF FOR SPECIFIED COATING.
- 5 REMOVE EXISTING ROOFING AND REPLACE WITH MEMBRANE ROOF, SEE SPEC 07 50 00.

DEMOLITION LEGEND

TO BE DEMOLISHED

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City of TUSCALOOSA
WATER SEWER

FTCHER WATER

TUSCALOOSA, AL
HILLIARD N. FLETCH
RESOURCE RECOV

DIGESTER CONTROL
BUILDING SELECTIVE
DEMOLITION ROOF

JOB NO.: 19W10160 DATE: JAN. 2024 DESIGNED BY: RWC DRAWN BY: WTL CHECKED BY: RDT


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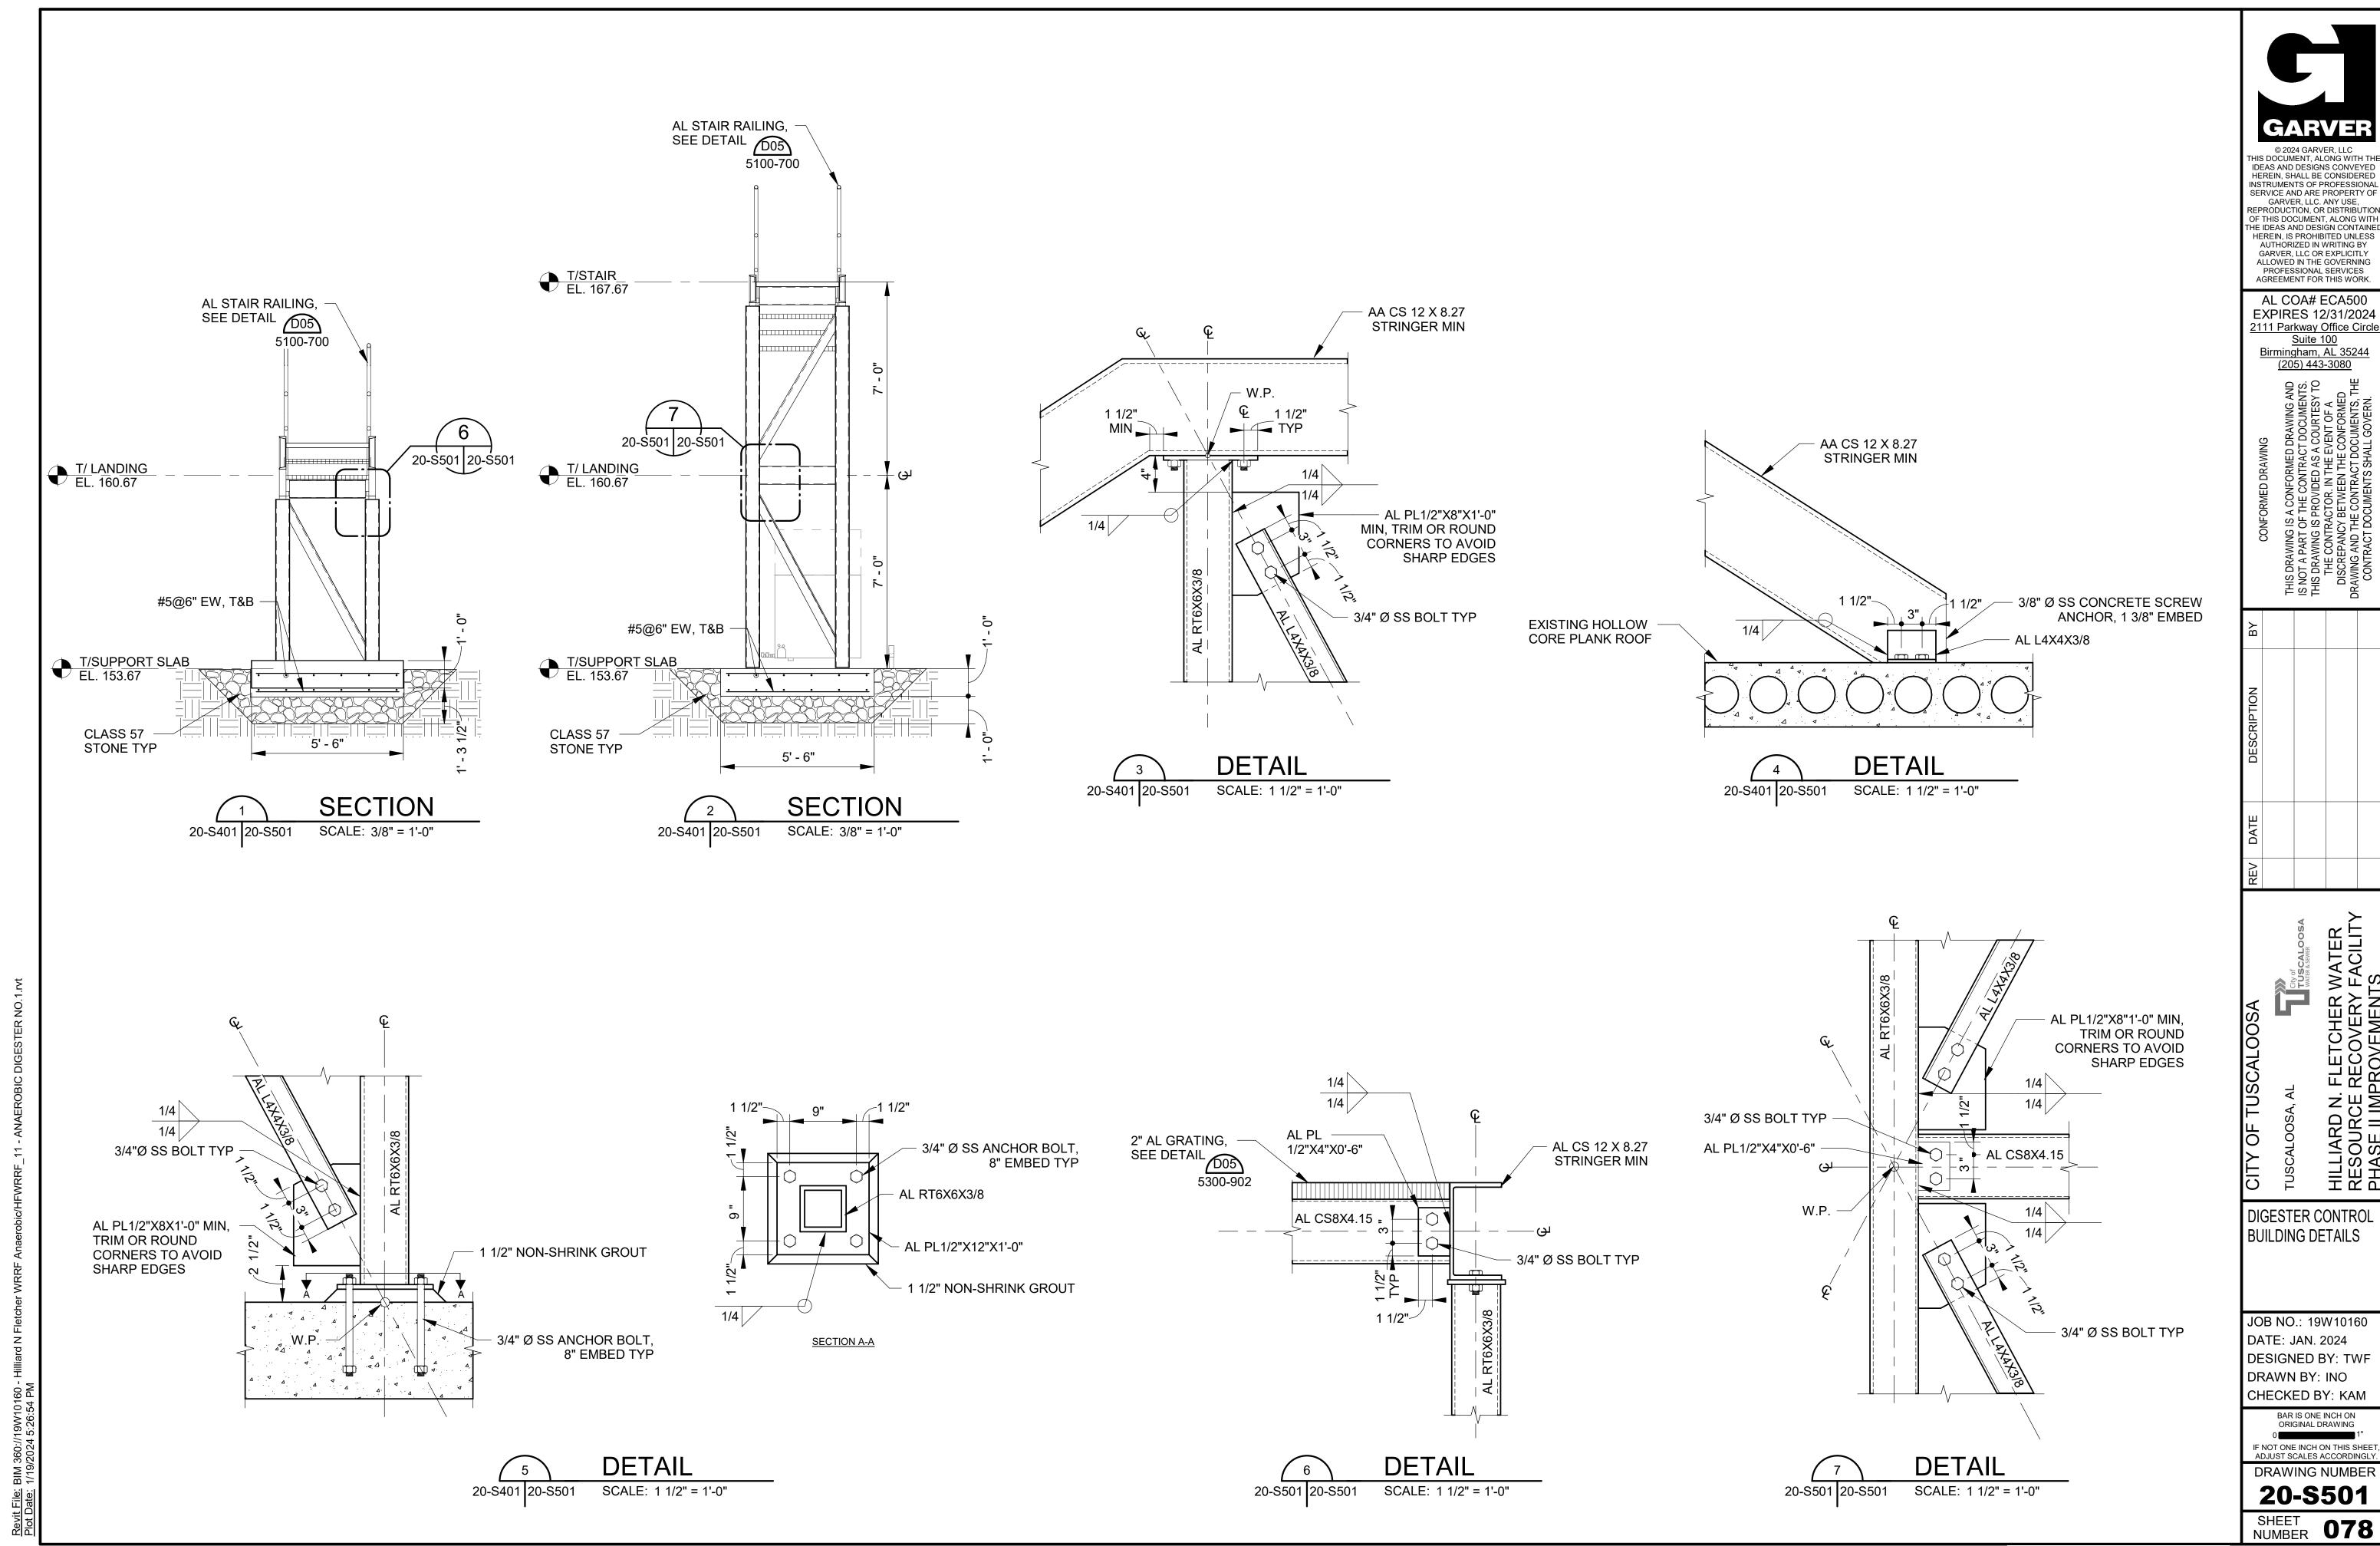
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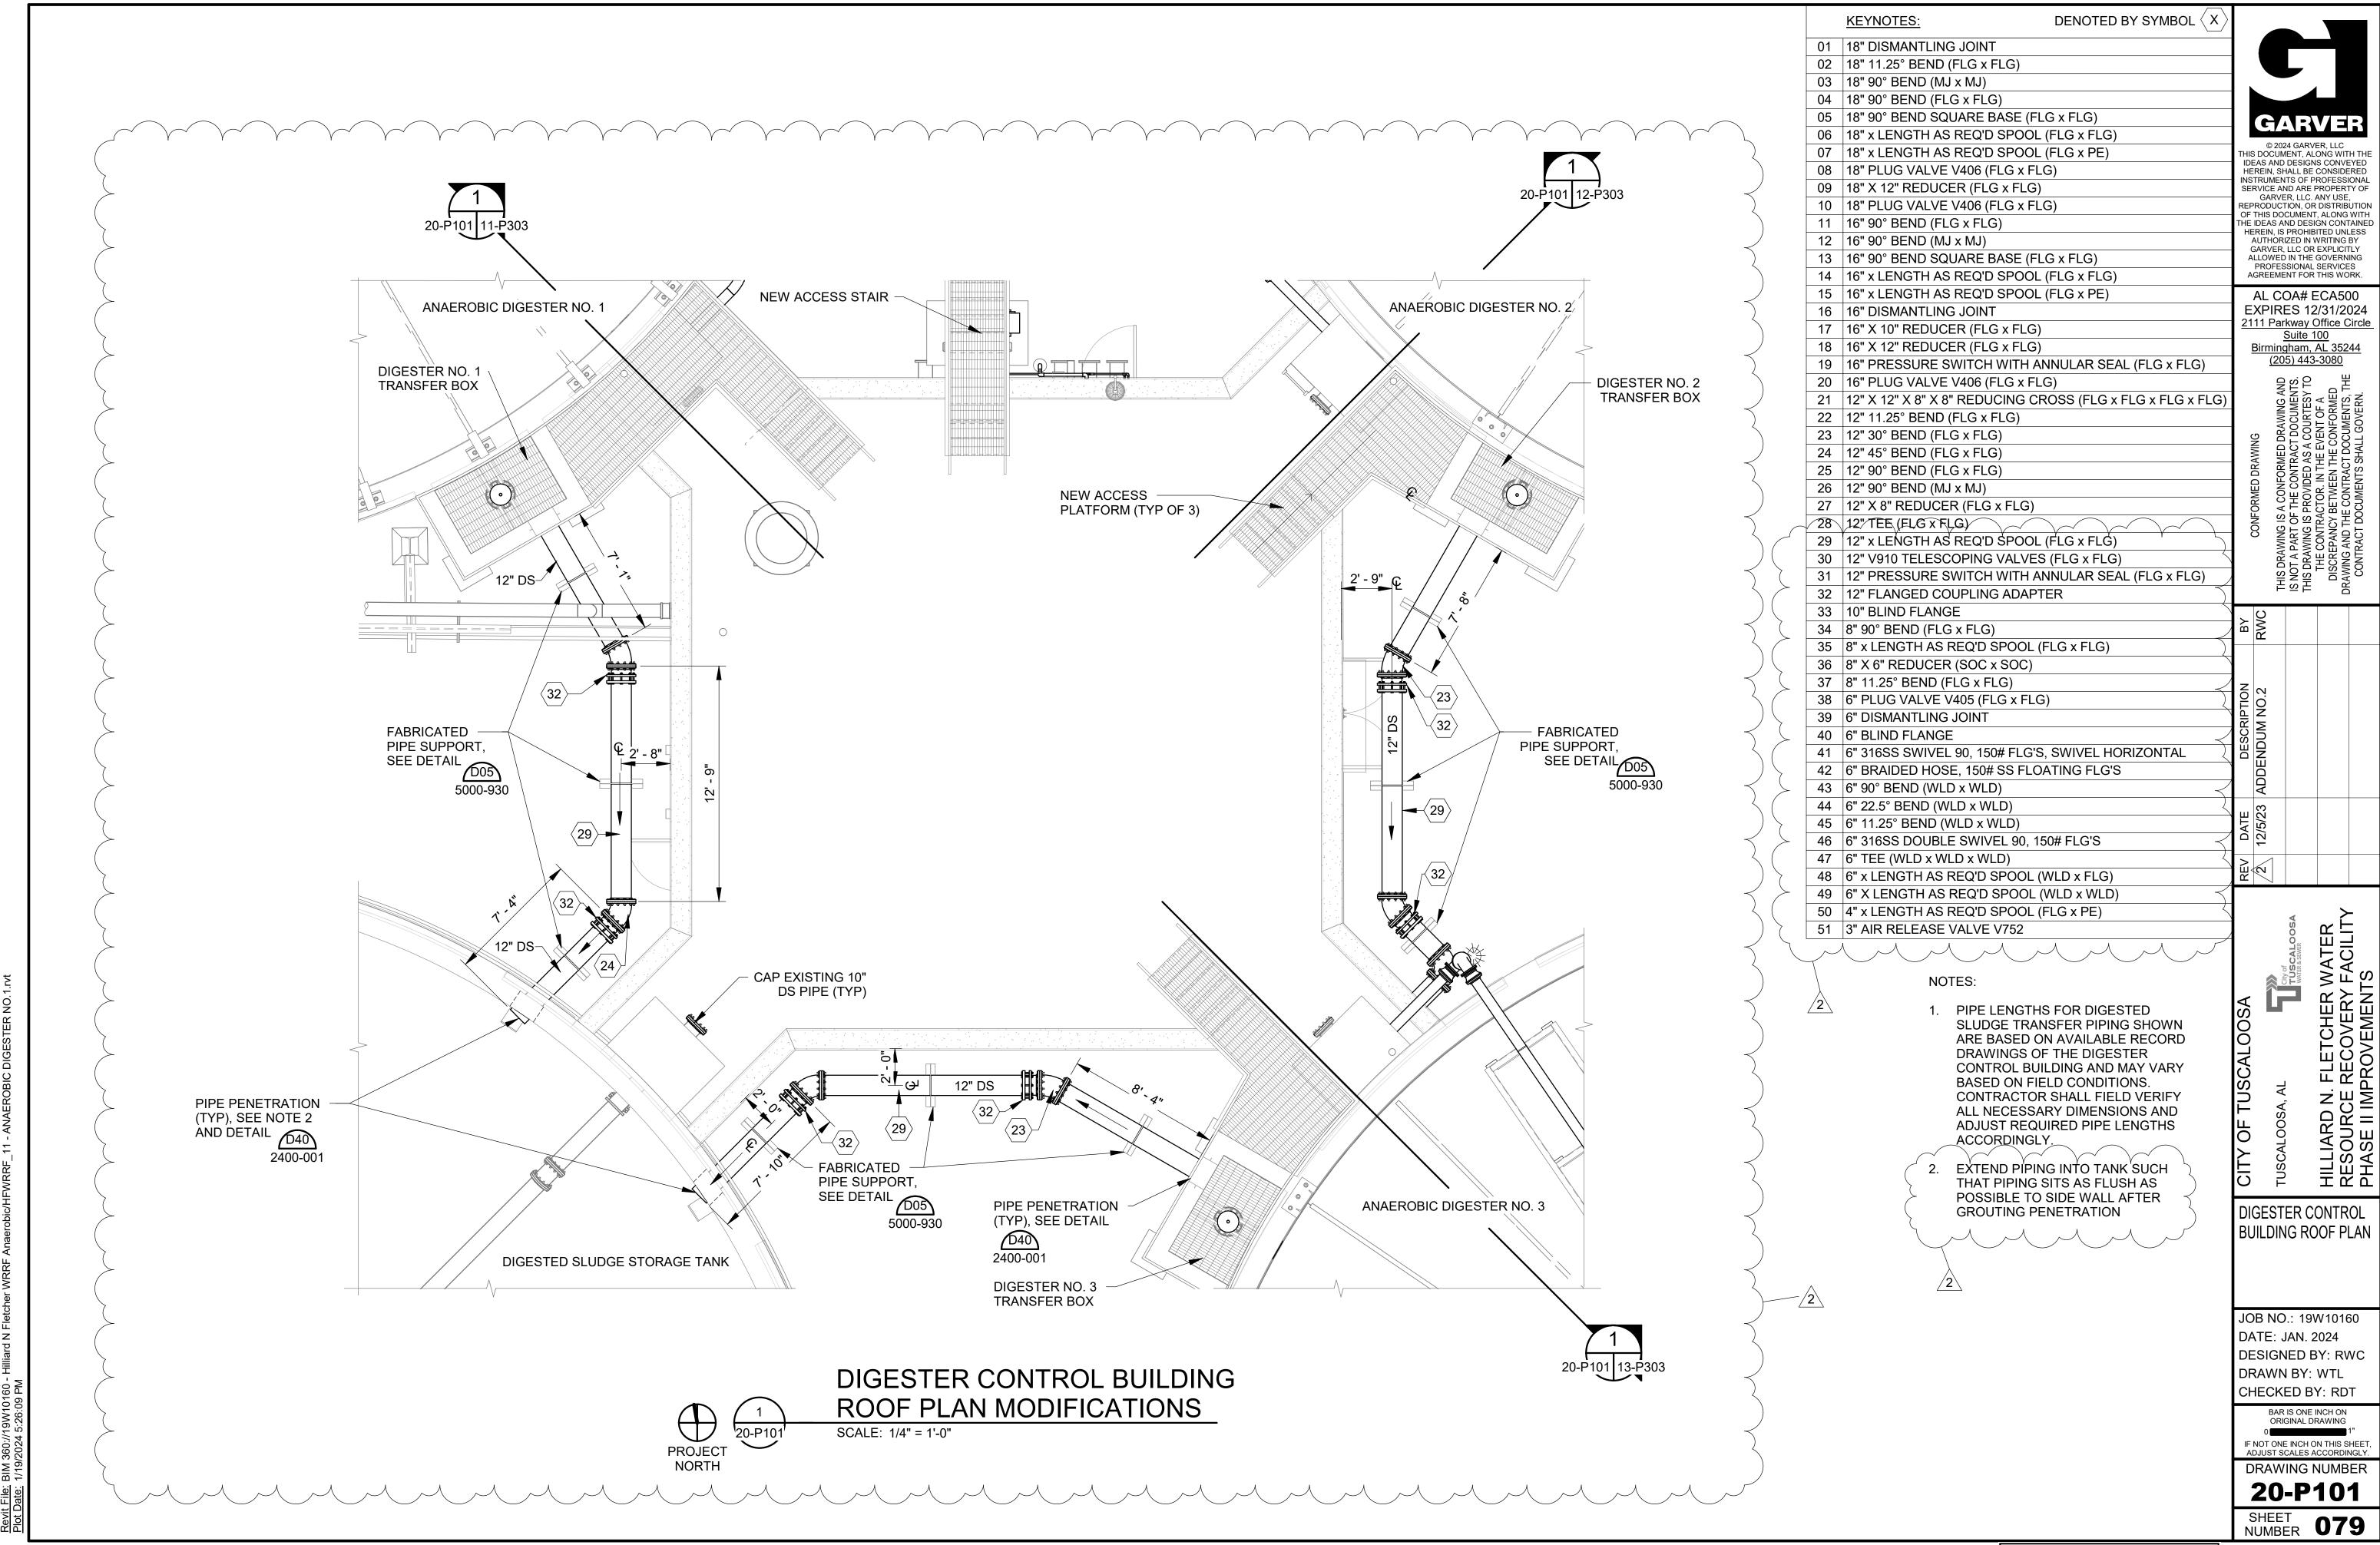
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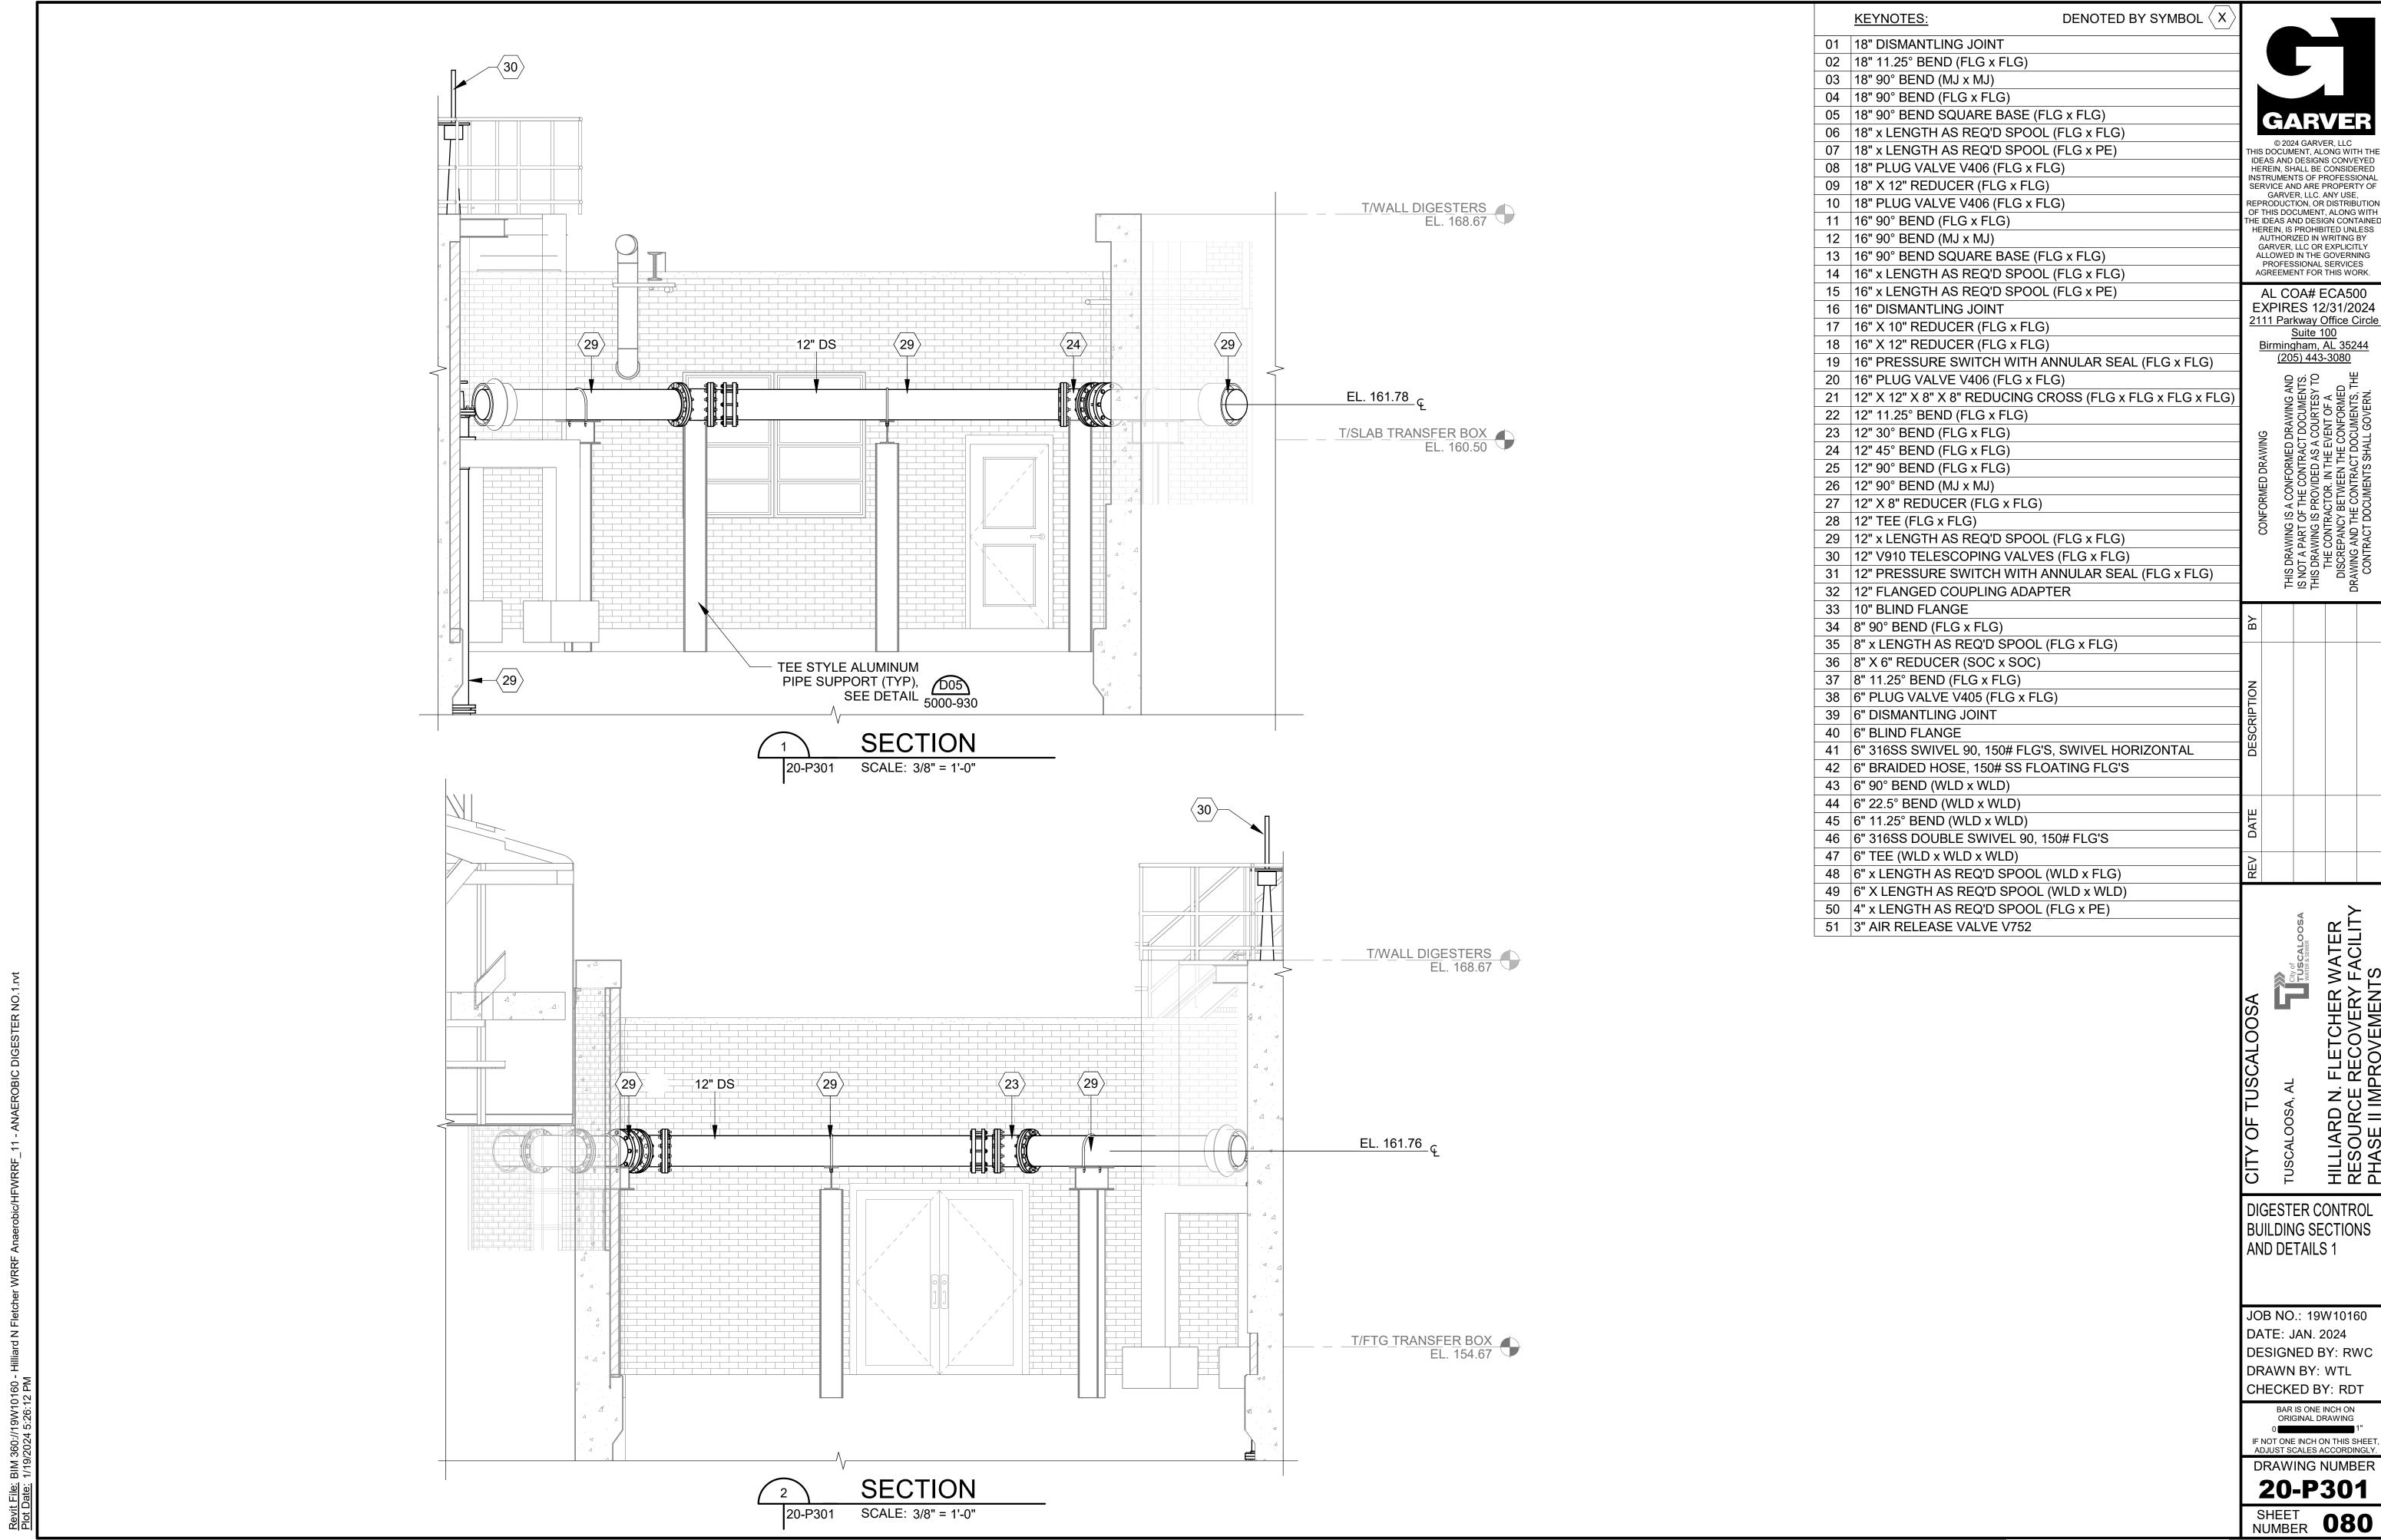



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DIGESTER CONTROL BUILDING ISOMETRIC

JOB NO.: 19W10160 DATE: JAN. 2024 DESIGNED BY: RWC DRAWN BY: WTL CHECKED BY: RDT

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20-P901

SHEET NUMBER 082

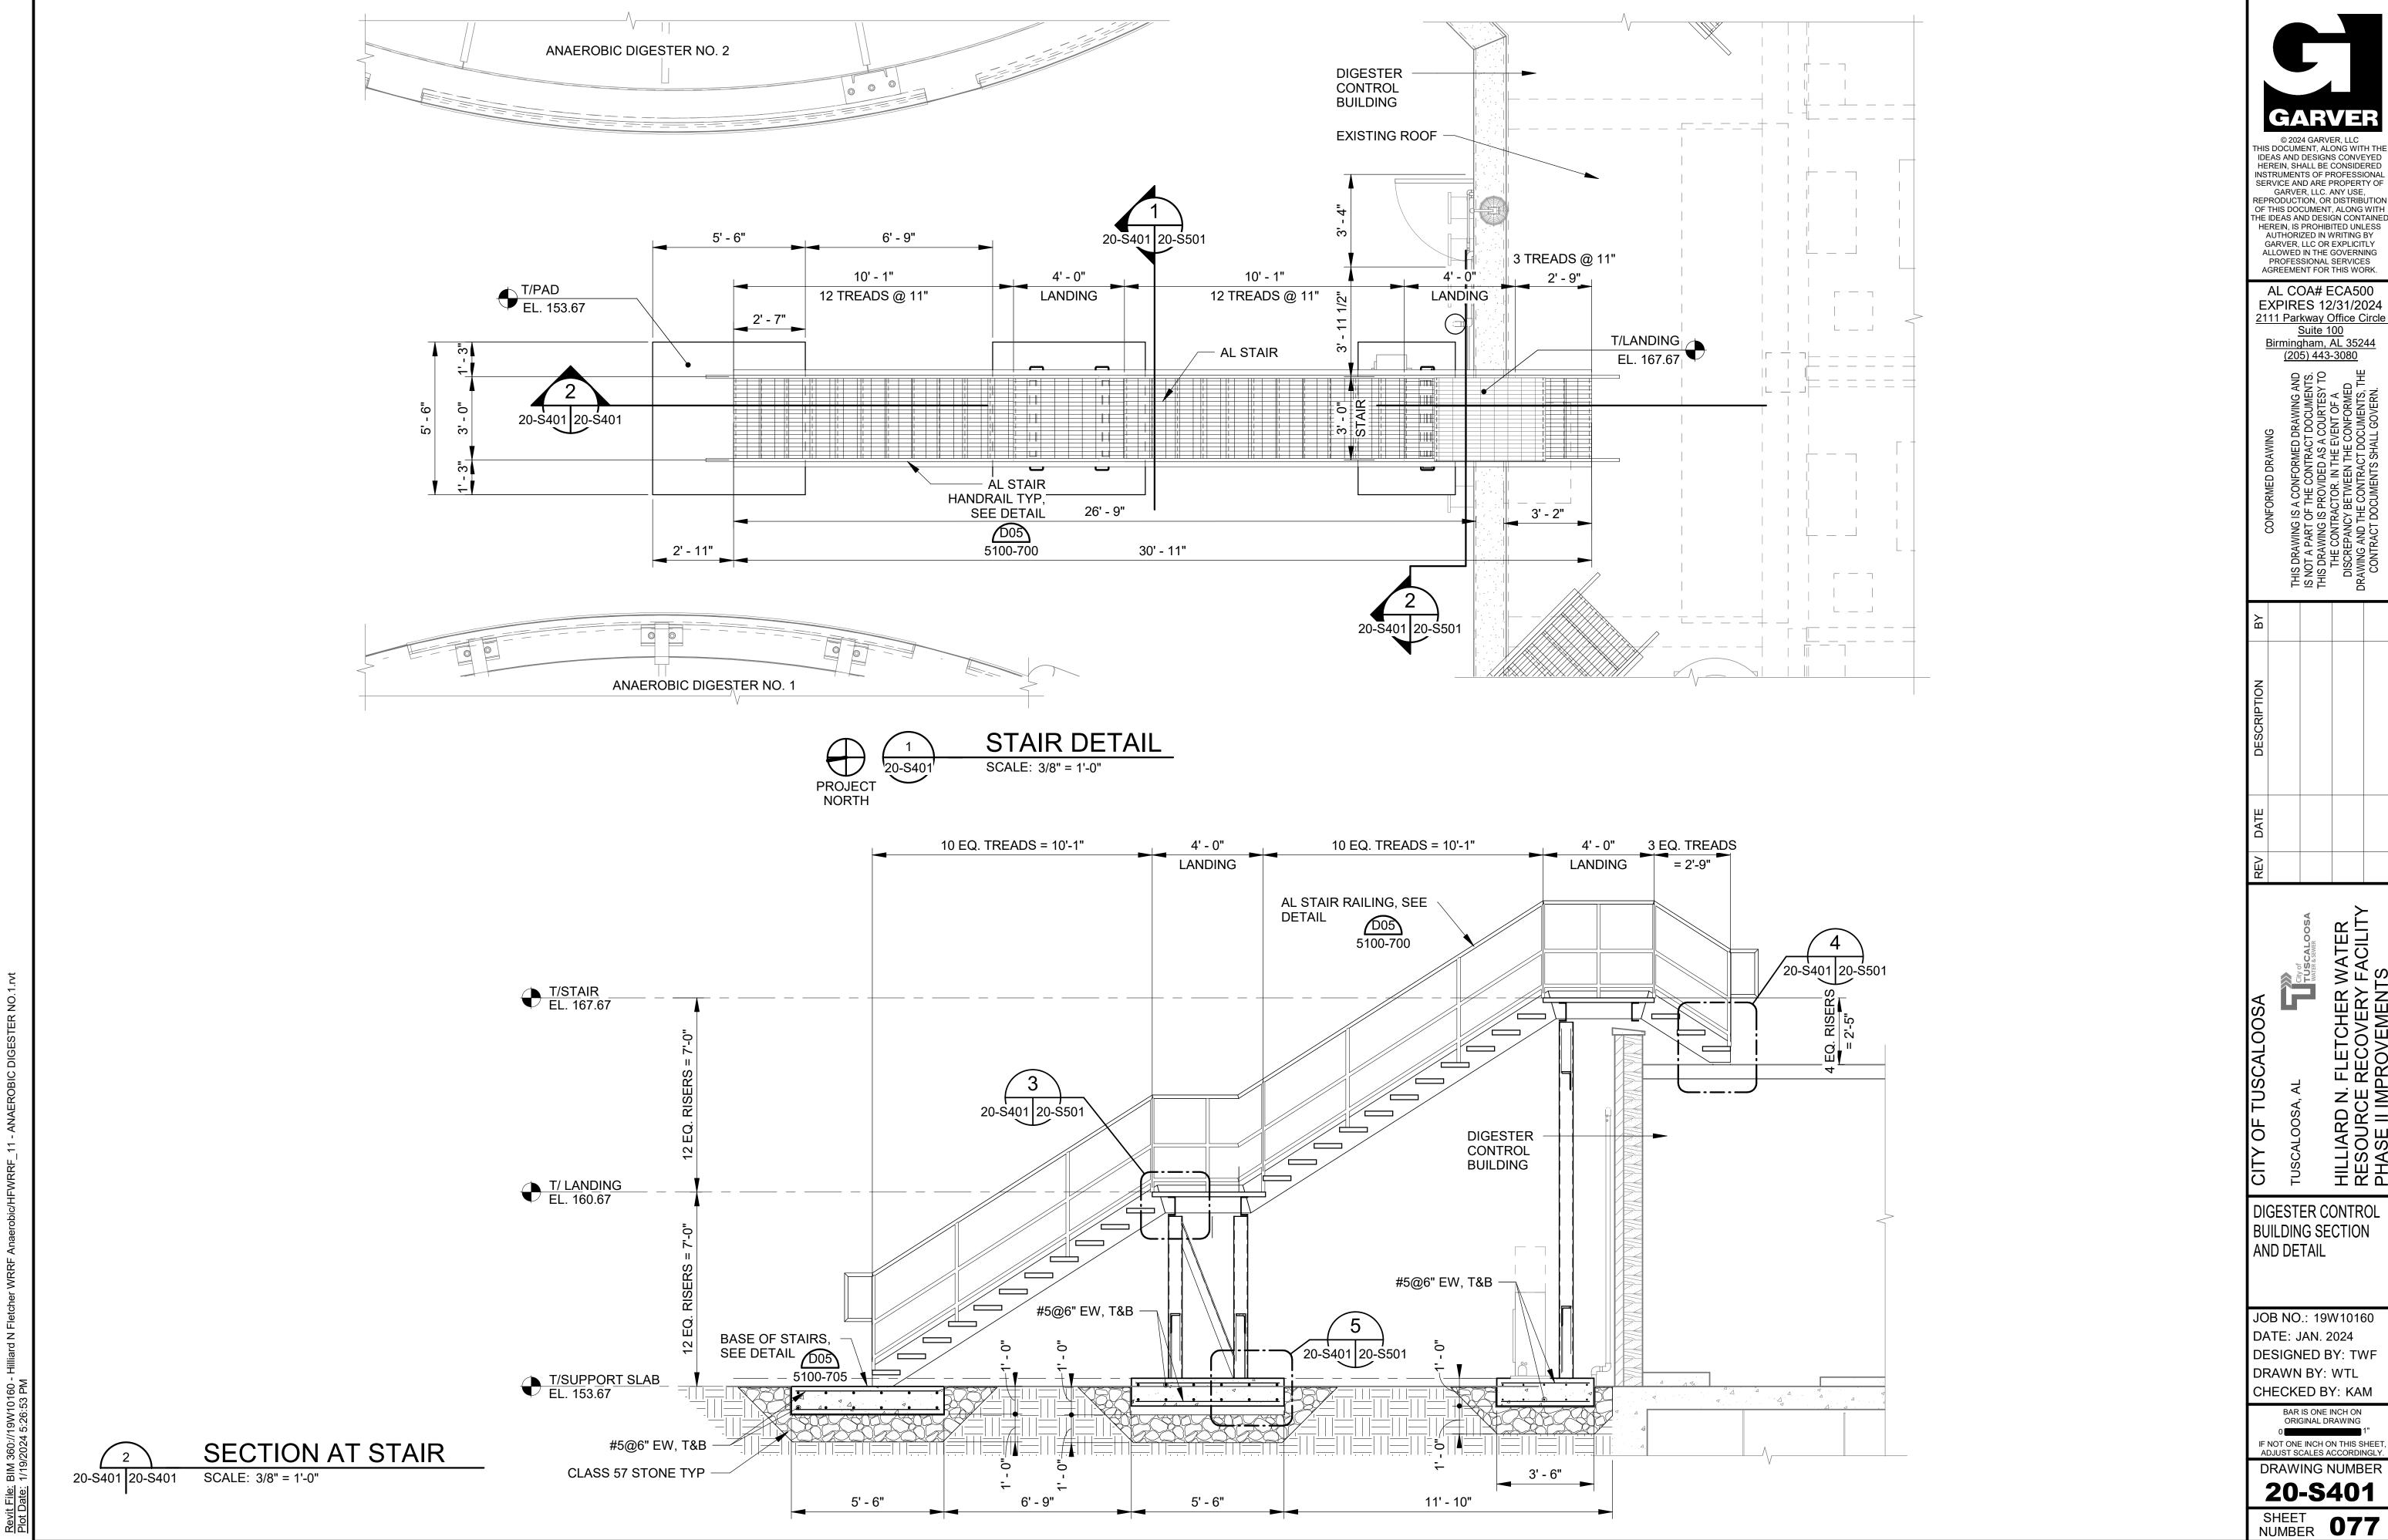20-P901

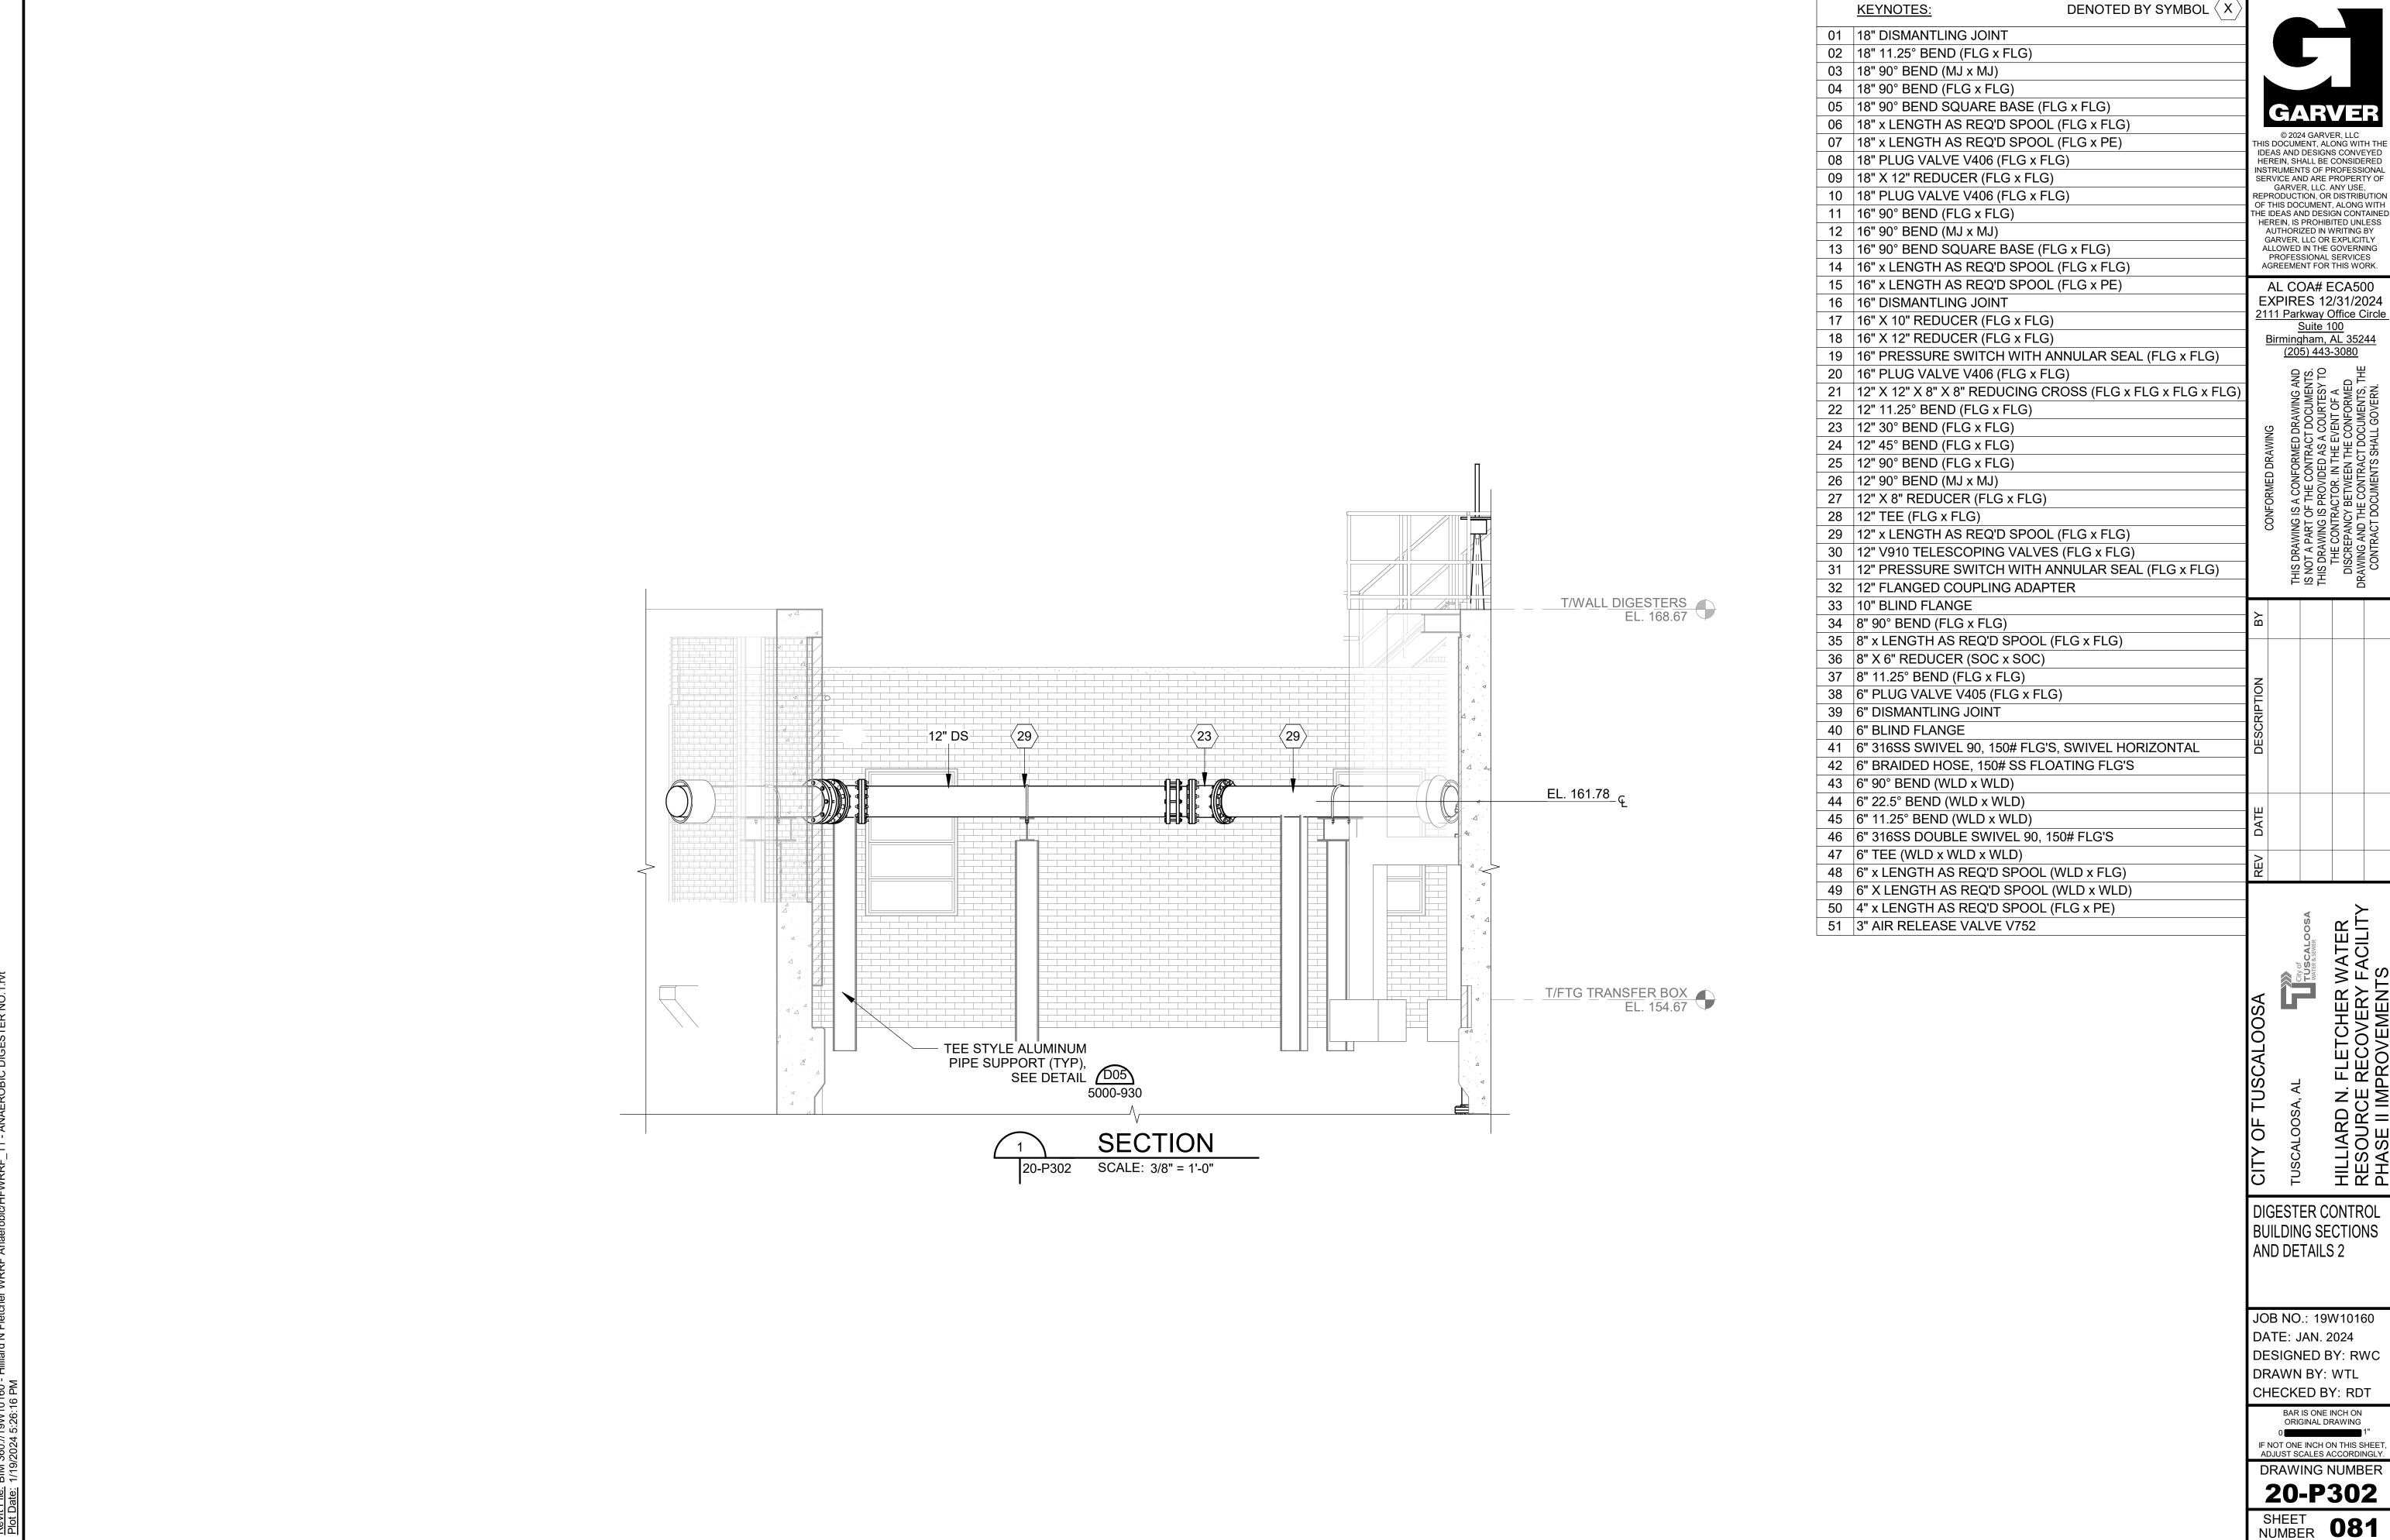DIGESTER CONTROL BUILDING ISOMETRIC SCALE: NOT TO SCALE

20-M101

PROJECT NORTH SCALE: 3/4" = 1'-0"

NOTES:

- CEILING SUSPEND 20EV01 PER MANUFACTURER'S CLEARANCE REQUIREMENTS. INSTALL SO BOTTOM OF 20EV01 IS AT LEAST 9' ABOVE FLOOR. DO NOT INSTALL OVER ANY ELECTRICAL EQUIPMENT. INSTALLATION DIMENSIONS ARE ESTIMATES. COORDINATE WITH CONTRACTOR ON ACCEPTABLE LOCATION BASED ON FIELD CONDITIONS.
- FIELD ROUTE REFRIGERANT LINES FROM 20CU01 TO 20EV01. DO NOT RUN REFRIGERANT LINES OVER ELECTRICAL GEAR. CORE DRILL THROUGH WALL ABOVE DOOR AND PROVIDE WEATHER-TIGHT SEAL.
- FIELD ROUTE CONDENSATE LINE FROM 20EV01 TO NEW GRAVEL DRAIN WELL. DO NOT RUN CONDENSATE LINE OVER ELECTRICAL GEAR. CORE DRILL THROUGH WALL ABOVE DOOR AND PROVIDE WEATHER-TIGHT SEAL.

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JSA, AL

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HVAC PLAN

JOB NO.: 19W10160 DATE: JAN. 2024 DESIGNED BY: BCR DRAWN BY: ADA CHECKED BY: BCR

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MINI-SPLIT EVAPORATING UNIT SCHEDULE AIRFLOW | OUTSIDE AIR | COOLING CAPACITY (MBH) WEIGHT SEER | VOLTAGE | PHASE MCA (LB) ACCESSORIES NOTES MARK AREA SERVED MANUFACTURER MODEL (SCFM) (SCFM) SENSIBLE FLA 20EV01 DIGESTER ELECTRICAL ROOM MITSUBISHI PLA-A42EA7R1.TH 1200 41.1 32.8 21 208 2 56 ALL ALL **ACCESSORIES** <u>NOTES</u> 1. WIRED REMOTE CONTROL 1. INDOOR UNIT IS POWERED BY OUTDOOR UNIT


MINI-SPLIT CONDENSING UNIT SCHEDULE													
MADIC		COOLING CAPACITY (MBH) COIL/CONDENSOR AMBIENT COMBINATION RATING							DUACE	MCA	ГІА	WEIGHT	ACCESCODIES
MARK	AREA SERVED	MANUFACTURER	MODEL	TEMP (°F)	TOTAL	SENSIBLE	(SEER)	VOLTAGE	PHASE	MCA	FLA	(LB)	ACCESSORIES
20CU01	DIGESTER ELECTRICAL ROOM	MITSUBISHI	PUY-A42NKA7-BS	105	41.1	32.8	21	208	1	25	1	211	ALL


ACCESSORIES

- 1. WIND BAFFLE FOR LOW AMBIENT COOLING TO 0 DEGREES FAHRENHEIT.
- 2. CORROSION RESISTANT COATING ON COILS

KEYNOTES:

- EXISTING MCC TO BE REMOVED AND REPLACED WITH NEW. COORDINATE SALVAGE WITH OWNER. MAKE ALL REQUIRED CONNECTIONS TO NEW AND REMAINING LOADS. FURNISH AND INSTALL NEW CONDUIT AND CONDUCTORS FROM MCC TO PUMP MIXERS. CONDUIT AND CONDUCTORS TO EXISTING LOADS TO BE REUSED.
- $\langle 2 \rangle$ GAS LEAK DETECTION PLC PANEL TO BE REMOVED AND REPLACED WITH NEW PLC CONTROL PANEL. COORDINATE SALVAGE WITH OWNER.
- (3) DIGESTION HEATING FIELD PANEL FP-15-1 TO BE REMOVED. COORDINATE SALVAGE WITH OWNER.
- 4 DIGESTER FEED PANEL FP-13-1 TO BE REMOVED. COORDINATE SALVAGE WITH OWNER.
- DEWATERING FEED PUMP STATION FIELD PANEL FP-16-7 CONTROLS TO BE REMOVED. ENCLOSURE TO REMAIN. EXTEND FIELD WIRING FROM EXISTING ENCLOSURE TO NEW PLC CONTROL PANEL AND MAKE ALL REQUIRED CONNECTIONS. REMOVE ALL PANEL MOUNTED CONTROLS AND INDICATORS. FILL ALL HOLES WITH APPROPRIATE PLUGS OR COVERS.
- (6) EXISTING 15KVA TRANSFORMER TO BE REMOVED AND REPLACED WITH NEW 30KVA 208/120VAC TRANSFORMER. MAKE ALL REQUIRED CONNECTIONS.
- FIELD PANELS FP-13-1, FP-15-1, FP16-7, AND GAS LEAK DETECTION PANEL ARE TO BE REPLACED WITH NEW PLC CONTROL PANEL 20CP1. CONTRACTOR SHALL FIELD VERIFY EXISTING CONTROL PANELS FUNCTIONALITY AND I/O REQUIREMENTS. EXTEND FIELD WIRING FROM EXISTING PANEL LOCATIONS TO NEW PLC CONTROL PANEL AND MAKE ALL REQUIRED CONNECTIONS. SEE 1991 EXPANSION AND 2020 DIGESTER HEATING UPGRADES RECORD DRAWINGS FOR ADDITIONAL DETAILS.

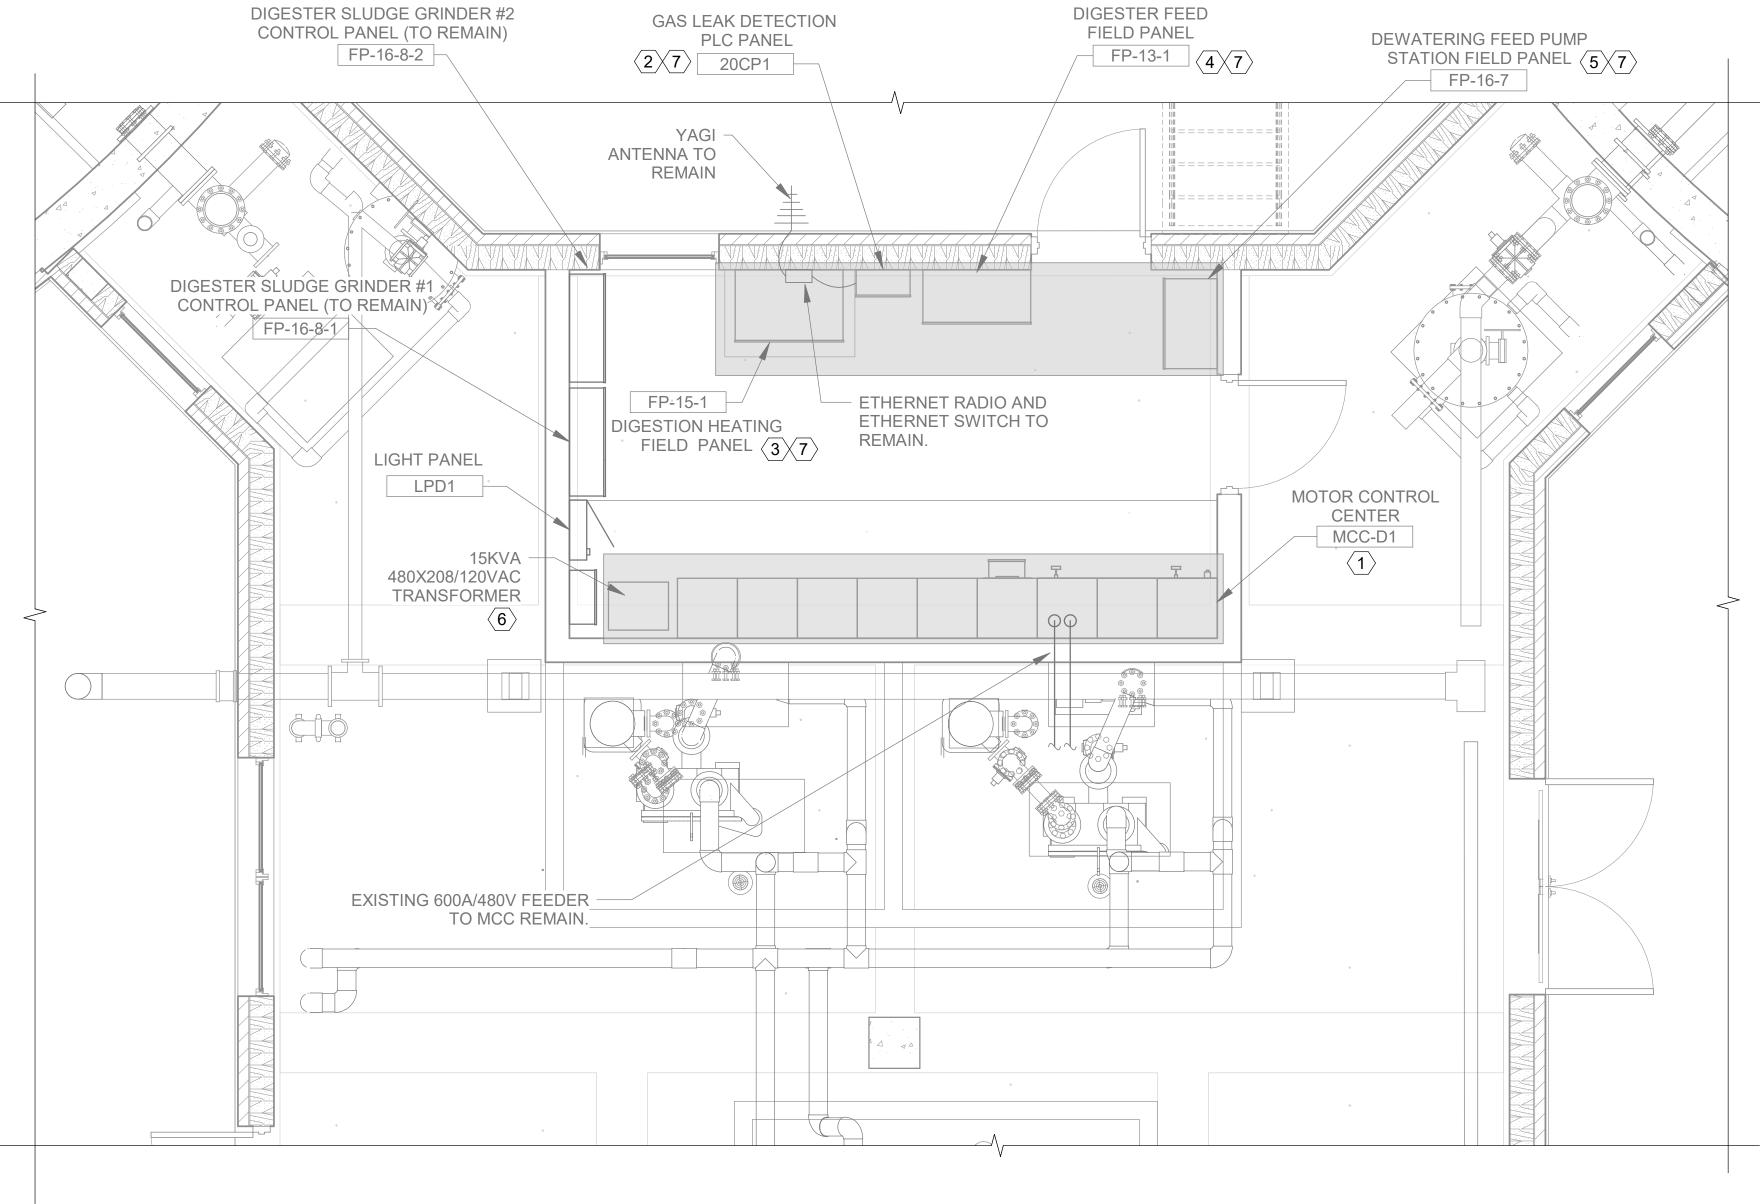

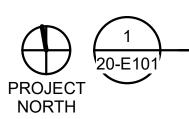

DIGESTER CONTROL BUILDING ELECTRICAL ROOM DEMOLITION

SCALE: 3/8" = 1'-0"

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OOSA, AL

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RD N. FLETCHER WATER
URCE RECOVERY FACILITY
E II IMPROVEMENTS

DIGESTER CONTROL BUILDING ELECTRICAL ROOM DEMOLITION

JOB NO.: 19W10160 DATE: JAN. 2024 DESIGNED BY: SAH DRAWN BY: SAH CHECKED BY: JCW

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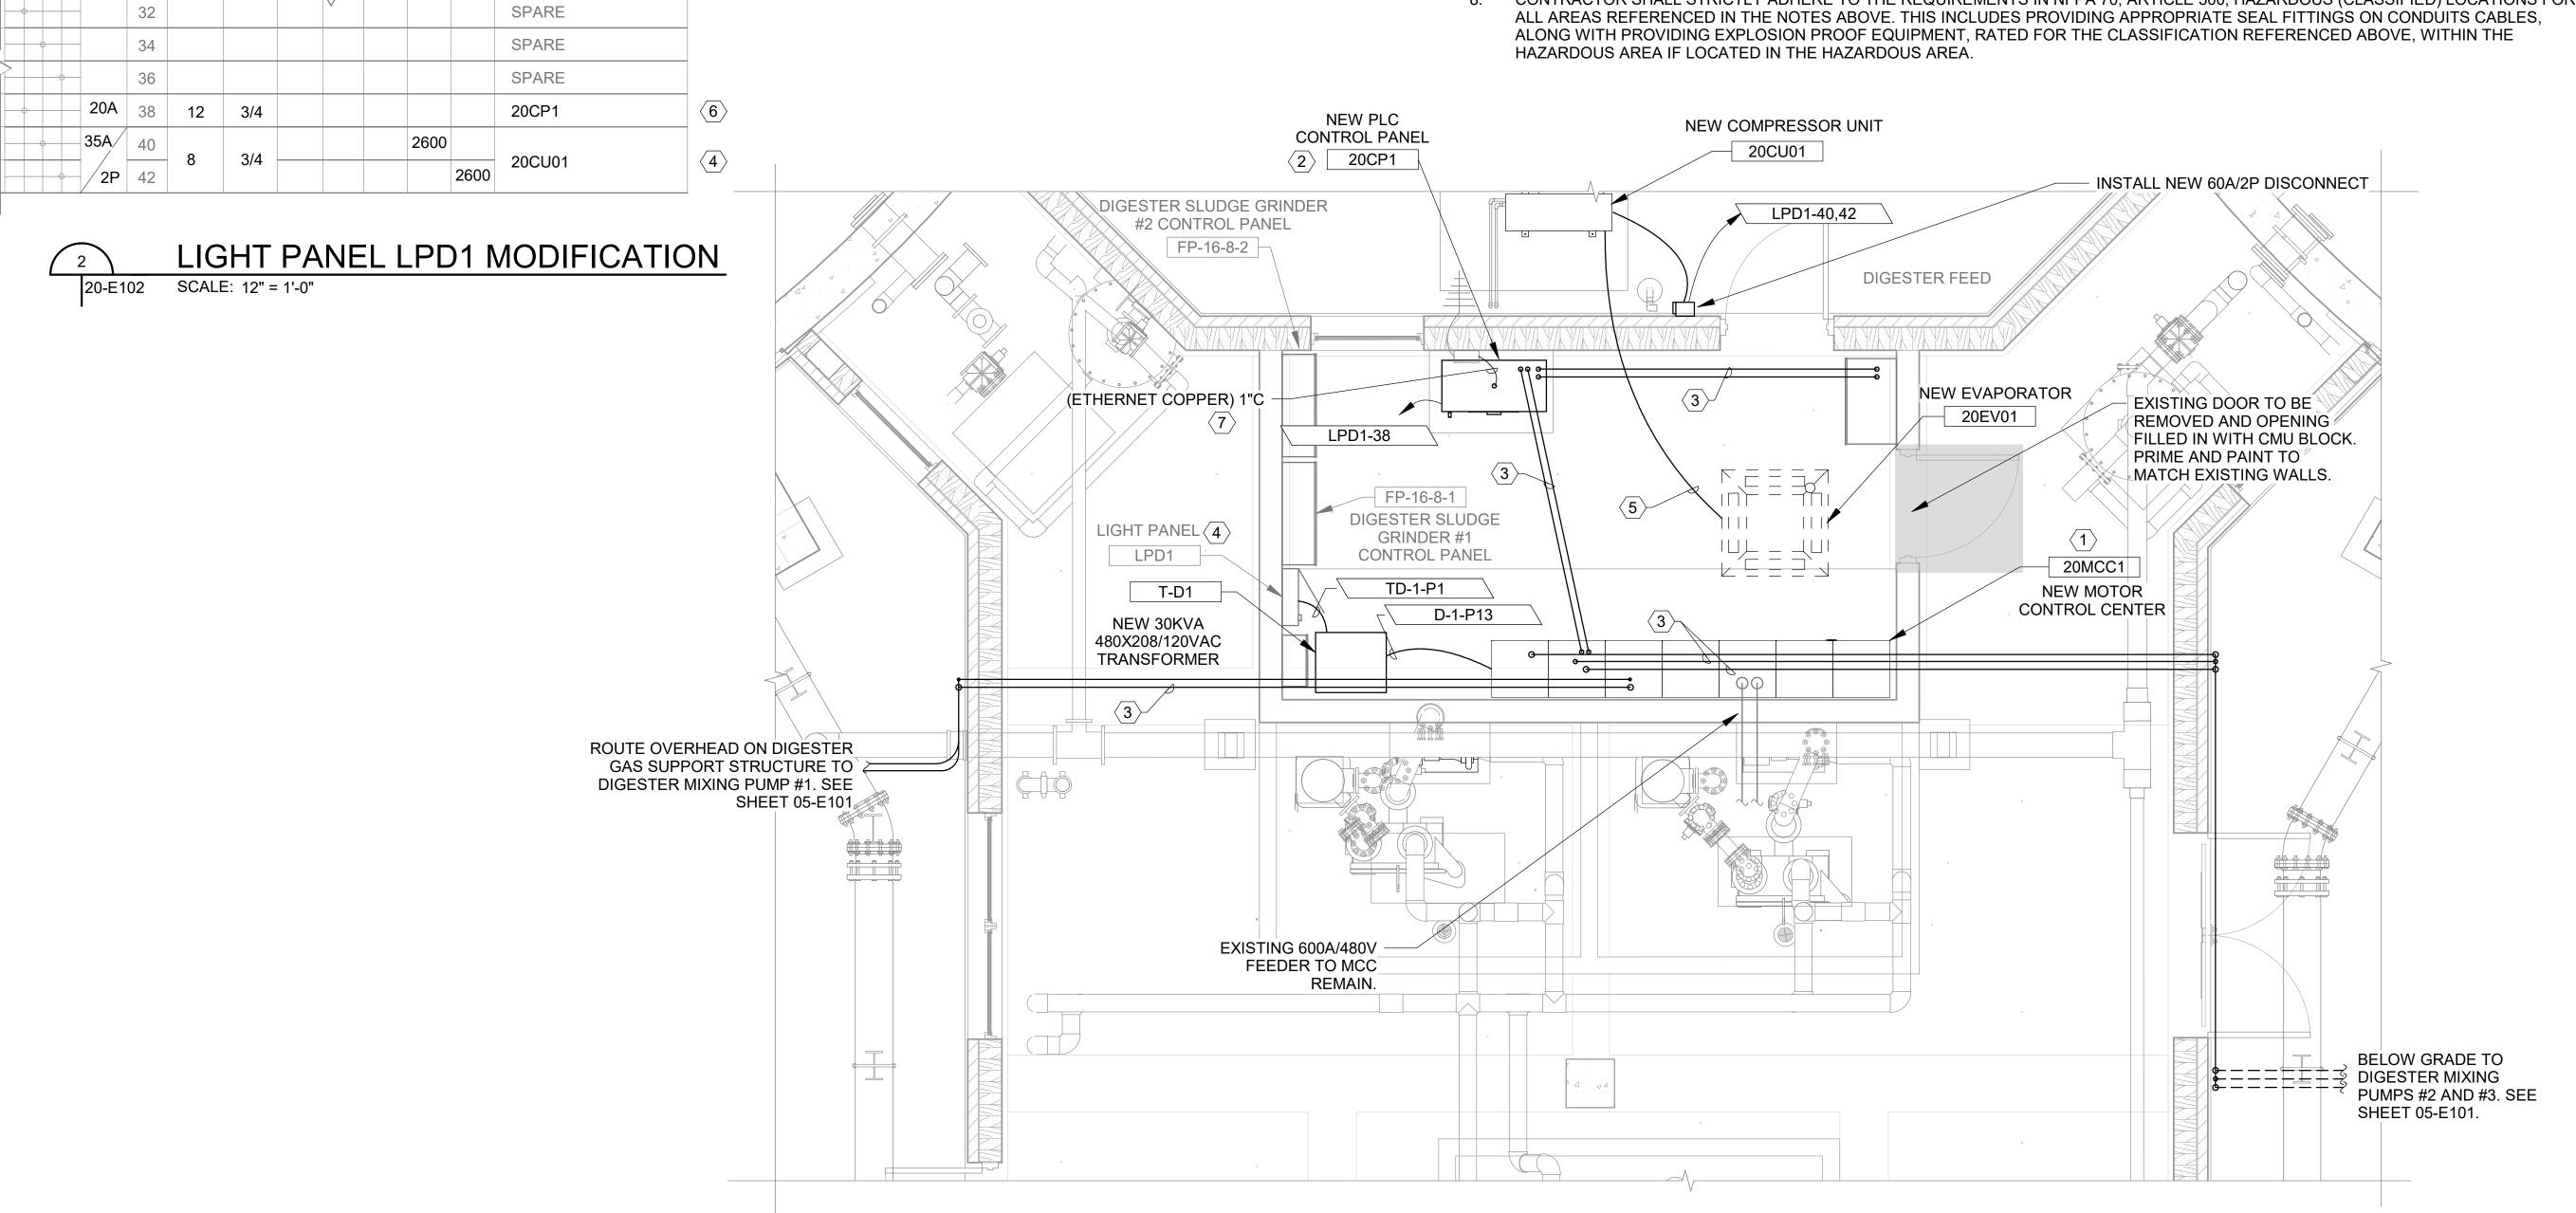
20-E101
SHEET NUMBER 084

KEYNOTES:

- EXISTING MCC TO BE REMOVED AND REPLACED WITH NEW. COORDINATE SALVAGE WITH OWNER. MAKE ALL REQUIRED CONNECTIONS TO NEW AND REMAINING LOADS. FURNISH AND INSTALL NEW CONDUIT AND CONDUCTORS FROM MCC TO PUMP MIXERS. CONDUIT AND CONDUCTORS TO EXISTING LOADS TO BE REUSED.
- 2 MAKE ALL REQUIRED PLC CONTROL PANEL MODIFICATIONS FOR NEW MIXER I/O.
- (3) SEE INTERCONNECT DIAGRAM FOR CONDUIT AND CONDUCTORS ON SHEET 11-E101.
- 4 FURNISH AND INSTALL NEW 35A/2P CIRCUIT IN EXISTING LIGHT PANEL LPD1 FOR NEW HVAC LOAD. MAKE ALL REQUIRED PANEL MODIFICATIONS AND CONNECTIONS.
- 5 EVAPORATOR POWERED AND CONTROLLED FROM COMPRESSOR UNIT. MANUFACTURER SUPPLIED CONDUCTORS. FURNISH AND INSTALL CONDUITS FOR SUPPLIED CONDUCTORS.
- 6 FURNISH AND INSTALL NEW 20A/1P CIRCUIT IN EXISTING LIGHT PANEL LPD1 FOR NEW PLC CONTROL PANEL MAKE ALL REQUIRED PANEL MODIFICATIONS AND CONNECTIONS.
- $\langle 7 \rangle$ EXISTING YAGI ANTENNA, RADIO AND ETHERNET SWITCH TO REMAIN. FURNISH AND INSTALL NEW ETHERNET COPPER CONNECTION FROM 20CP1 TO EXISTING ETHERNET SWITCH.

GENERAL NOTES:

- THE CONTRACTOR SHALL FURNISH AND INSTALL ALL CONDUIT, WIRING, TERMINATIONS, DISCONNECTS, CONTROL RELAYS, CONTROL ENCLOSURES AND OTHER ITEMS AS NECESSARY FOR A COMPLETE AND FUNCTIONAL MOTOR CONTROL AND PUMP MIXING SYSTEM. CONTRACTOR SHALL REFER TO THE SPECIFICATIONS AND OTHER SECTIONS OF THE PLANS FOR ITEMS AS MAY BE REQUIRED.
- CONTRACTOR SHALL COORDINATE CONDUIT, WIRE AND INTERCONNECTIONS AS REQUIRED BY MIXER PUMP EQUIPMENT SUPPLIER. MAKE ALL REQUIRED CONNECTIONS ACCORDING TO MANUFACTURERS RECOMMENDATIONS. NOT ALL CONNECTIONS SHOWN.
- SOME CONDUIT RUNS OMITTED FOR CLARITY. COORDINATE ALL CONDUIT ROUTING WITH SUPPLIED EQUIPMENT MANUFACTURER AND ENGINEER PRIOR TO INSTALLATION.
- CONDUIT ROUTING AS SHOWN IS DIAGRAMMATIC IN NATURE AND SHOWN FOR REFERENCE ONLY. THE CONTRACTOR SHALL BE RESPONSIBLE FOR COORDINATING NUMBER OF REQUIRED CONDUITS AND PLACEMENT OF THESE CONDUITS. THE CONTRACTOR SHALL DEVELOP AND SUBMIT A CONDUIT ROUTING PLAN FOR REVIEW PRIOR TO INSTALLATION.
- SIGNAL AND CONTROL CONDUCTORS OF LIKE VOLTAGES MAY BE COMBINED IN A SINGLE CONDUIT. MULTI-CONDUCTOR CONTROL AND SIGNAL CABLE MAY BE SUBSTITUTED FOR INDIVIDUAL CONDUCTORS.
- ALL AREAS WITHIN THE DIGESTER CONTROL BUILDING, EXCEPT THE ELECTRICAL ROOM, SHALL BE CONSIDERED A CLASS 1, DIVISION 2 LOCATION ACCORDING TO NFPA 820. ELECTRICAL ROOM TO BE PHYSICALLY SEPARATED FROM THE REST OF THE CONTROL BUILDING BY SEALING OF ACCESS DOOR.
- 7. ALL AREAS 15' OVER DIGESTER TANK COVERS AND 5' BEYOND TANK WALLS SHALL BE CONSIDERED A CLASS1, DIVISION 2 LOCATION ACCORDING TO NFPA 820.
- CONTRACTOR SHALL STRICTLY ADHERE TO THE REQUIREMENTS IN NFPA 70, ARTICLE 500, HAZARDOUS (CLASSIFIED) LOCATIONS FOR ALL AREAS REFERENCED IN THE NOTES ABOVE. THIS INCLUDES PROVIDING APPROPRIATE SEAL FITTINGS ON CONDUITS CABLES, ALONG WITH PROVIDING EXPLOSION PROOF EQUIPMENT, RATED FOR THE CLASSIFICATION REFERENCED ABOVE, WITHIN THE



DIGESTER CONTROL BUILDING ELECTRICAL ROOM IMPROVEMENTS

20-X301 20-E102 SCALE: 3/8" = 1'-0" BAR IS ONE INCH ON ORIGINAL DRAWING

20-E102

DIGESTER CONTROL

BUILDING LOWER

LEVEL ELECTRICAL **IMPROVEMENTS**

JOB NO.: 19W10160

DESIGNED BY: Designe DRAWN BY: Author CHECKED BY: Checke

DATE: JAN. 2024

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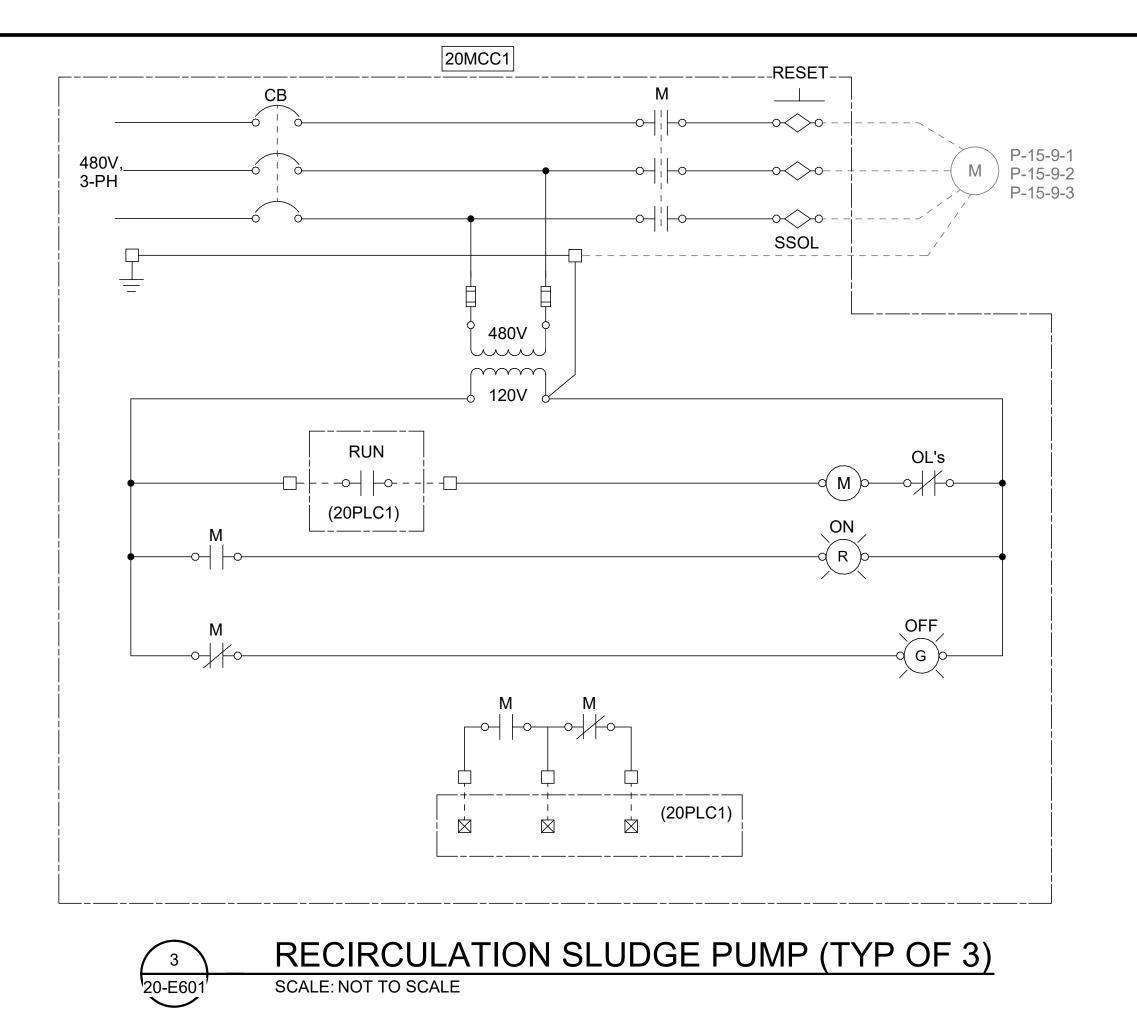
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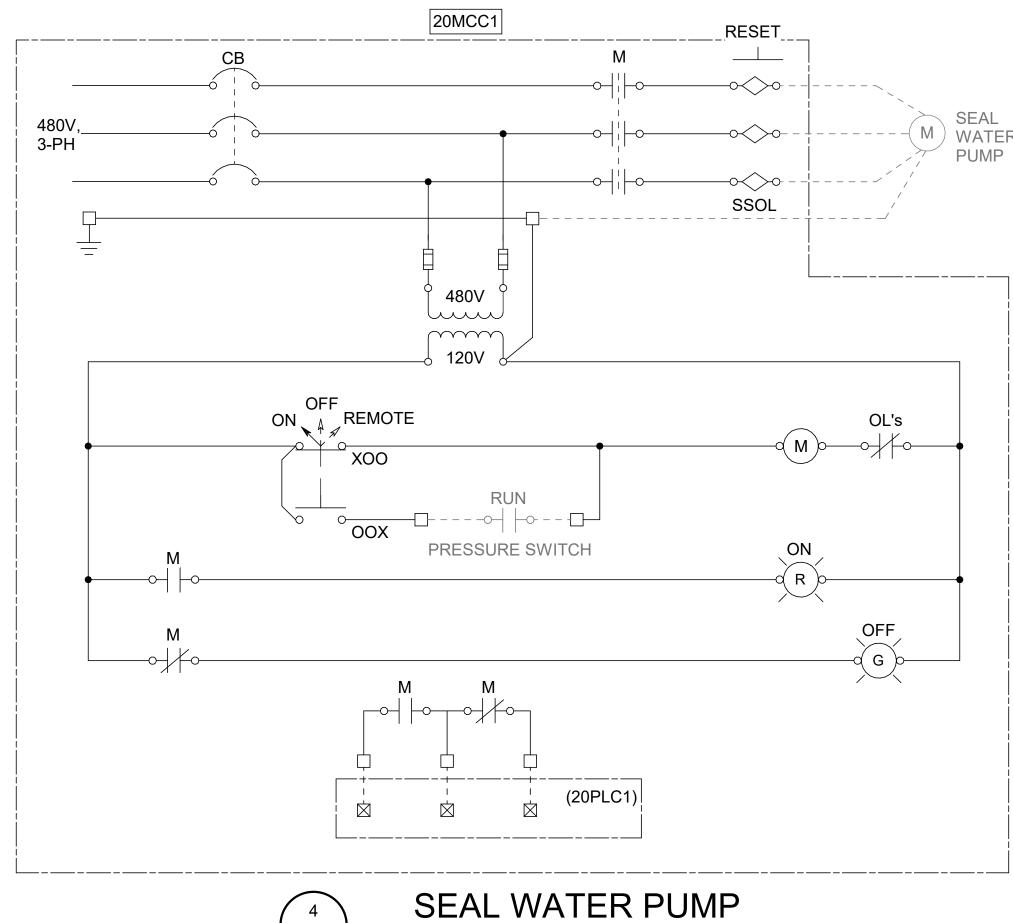
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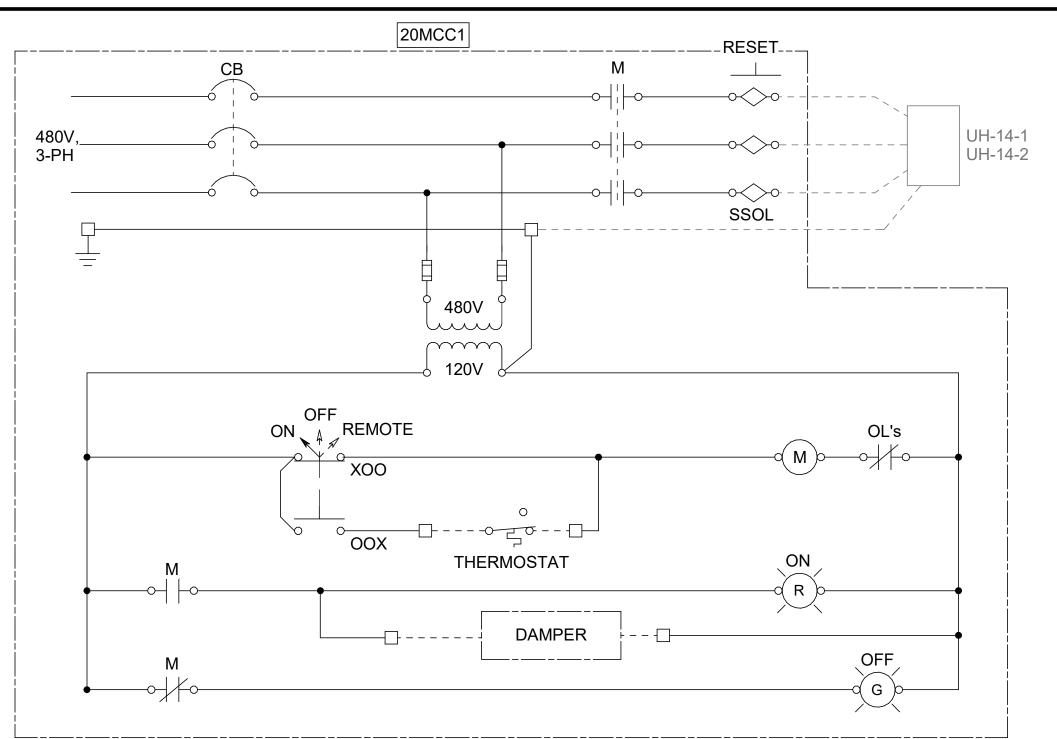
SHEET 085






SCALE: NOT TO SCALE

20-E601



UNIT HEATER (TYP OF 2)

SCALE: NOT TO SCALE

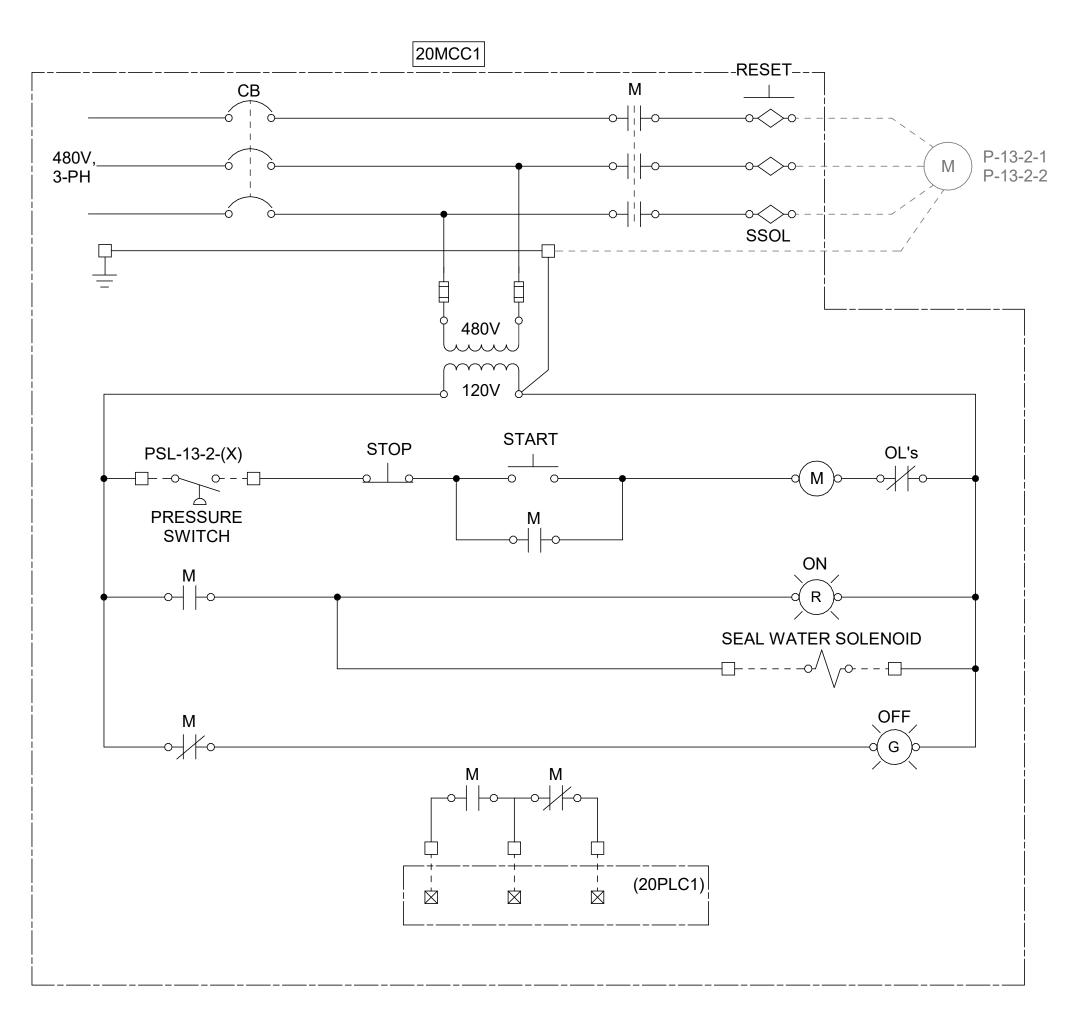

DISESTER TRANSFER PUMP (TYP OF 2)

SCALE: NOT TO SCALE

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DIGESTER CONTROL BUILDING - MCC CONTROL SCHEMATIC 1

JOB NO.: 19W10160 DATE: JAN. 2024 DESIGNED BY: SAH DRAWN BY: SAH CHECKED BY: JCW


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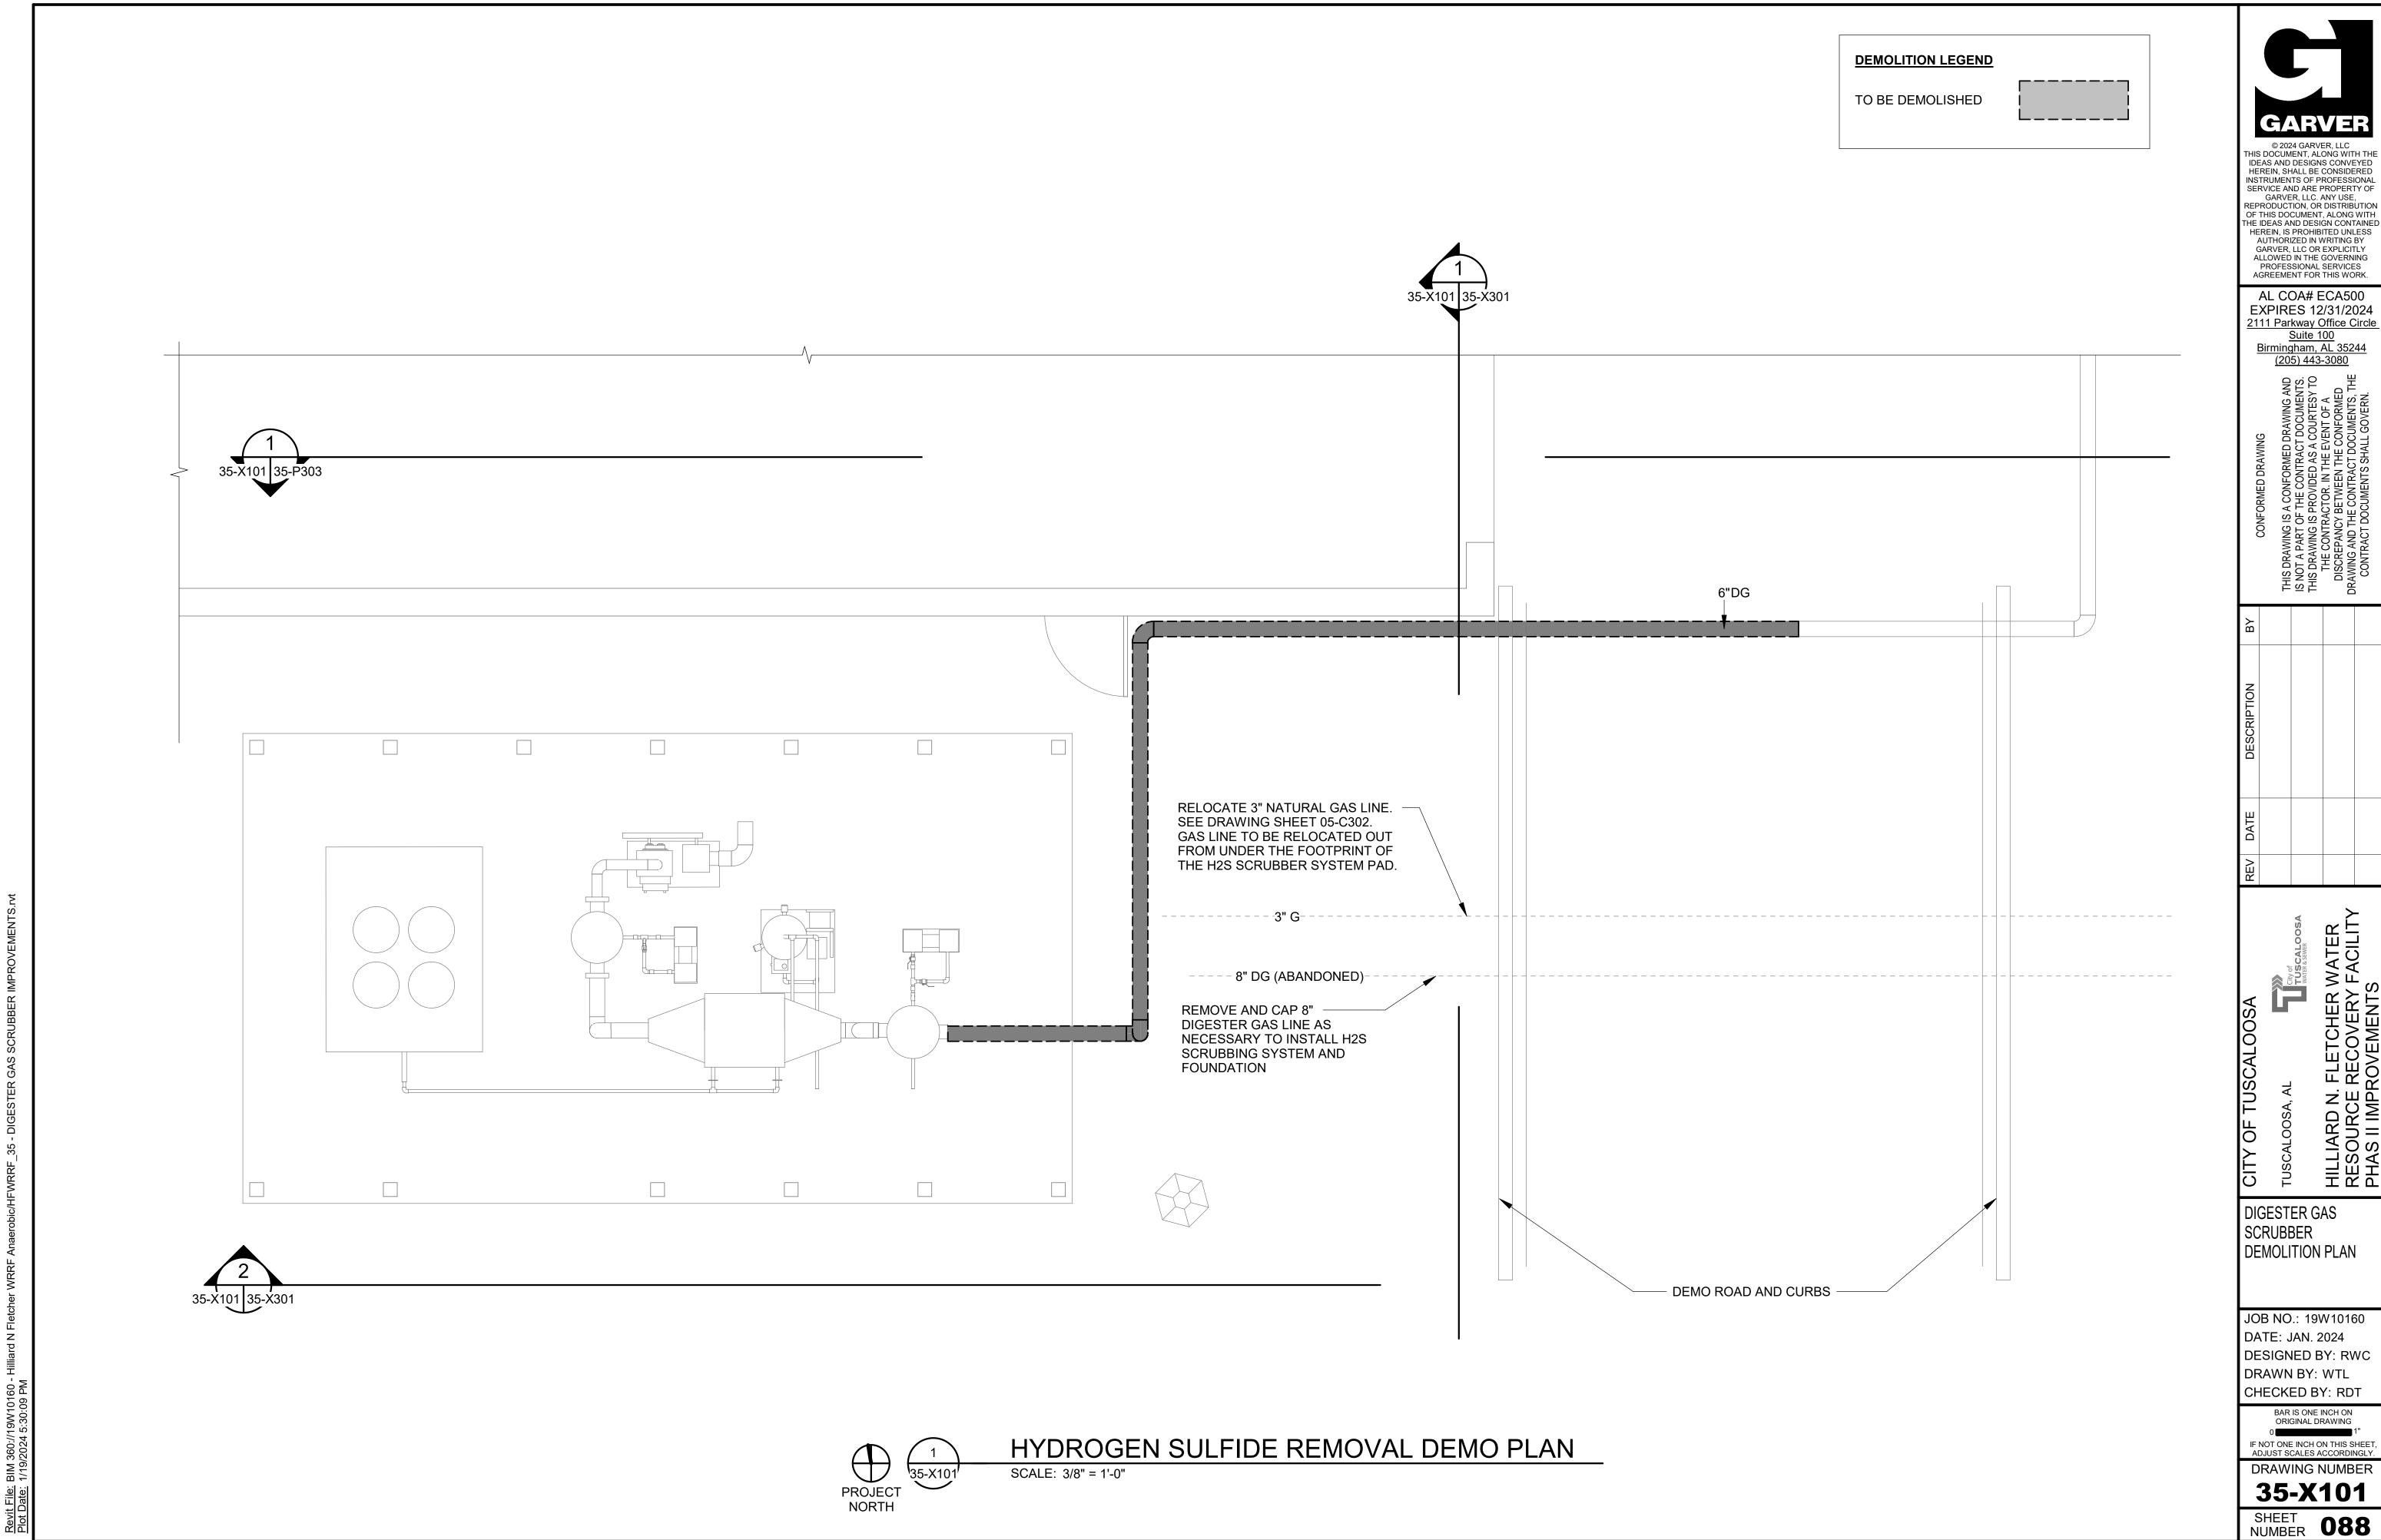
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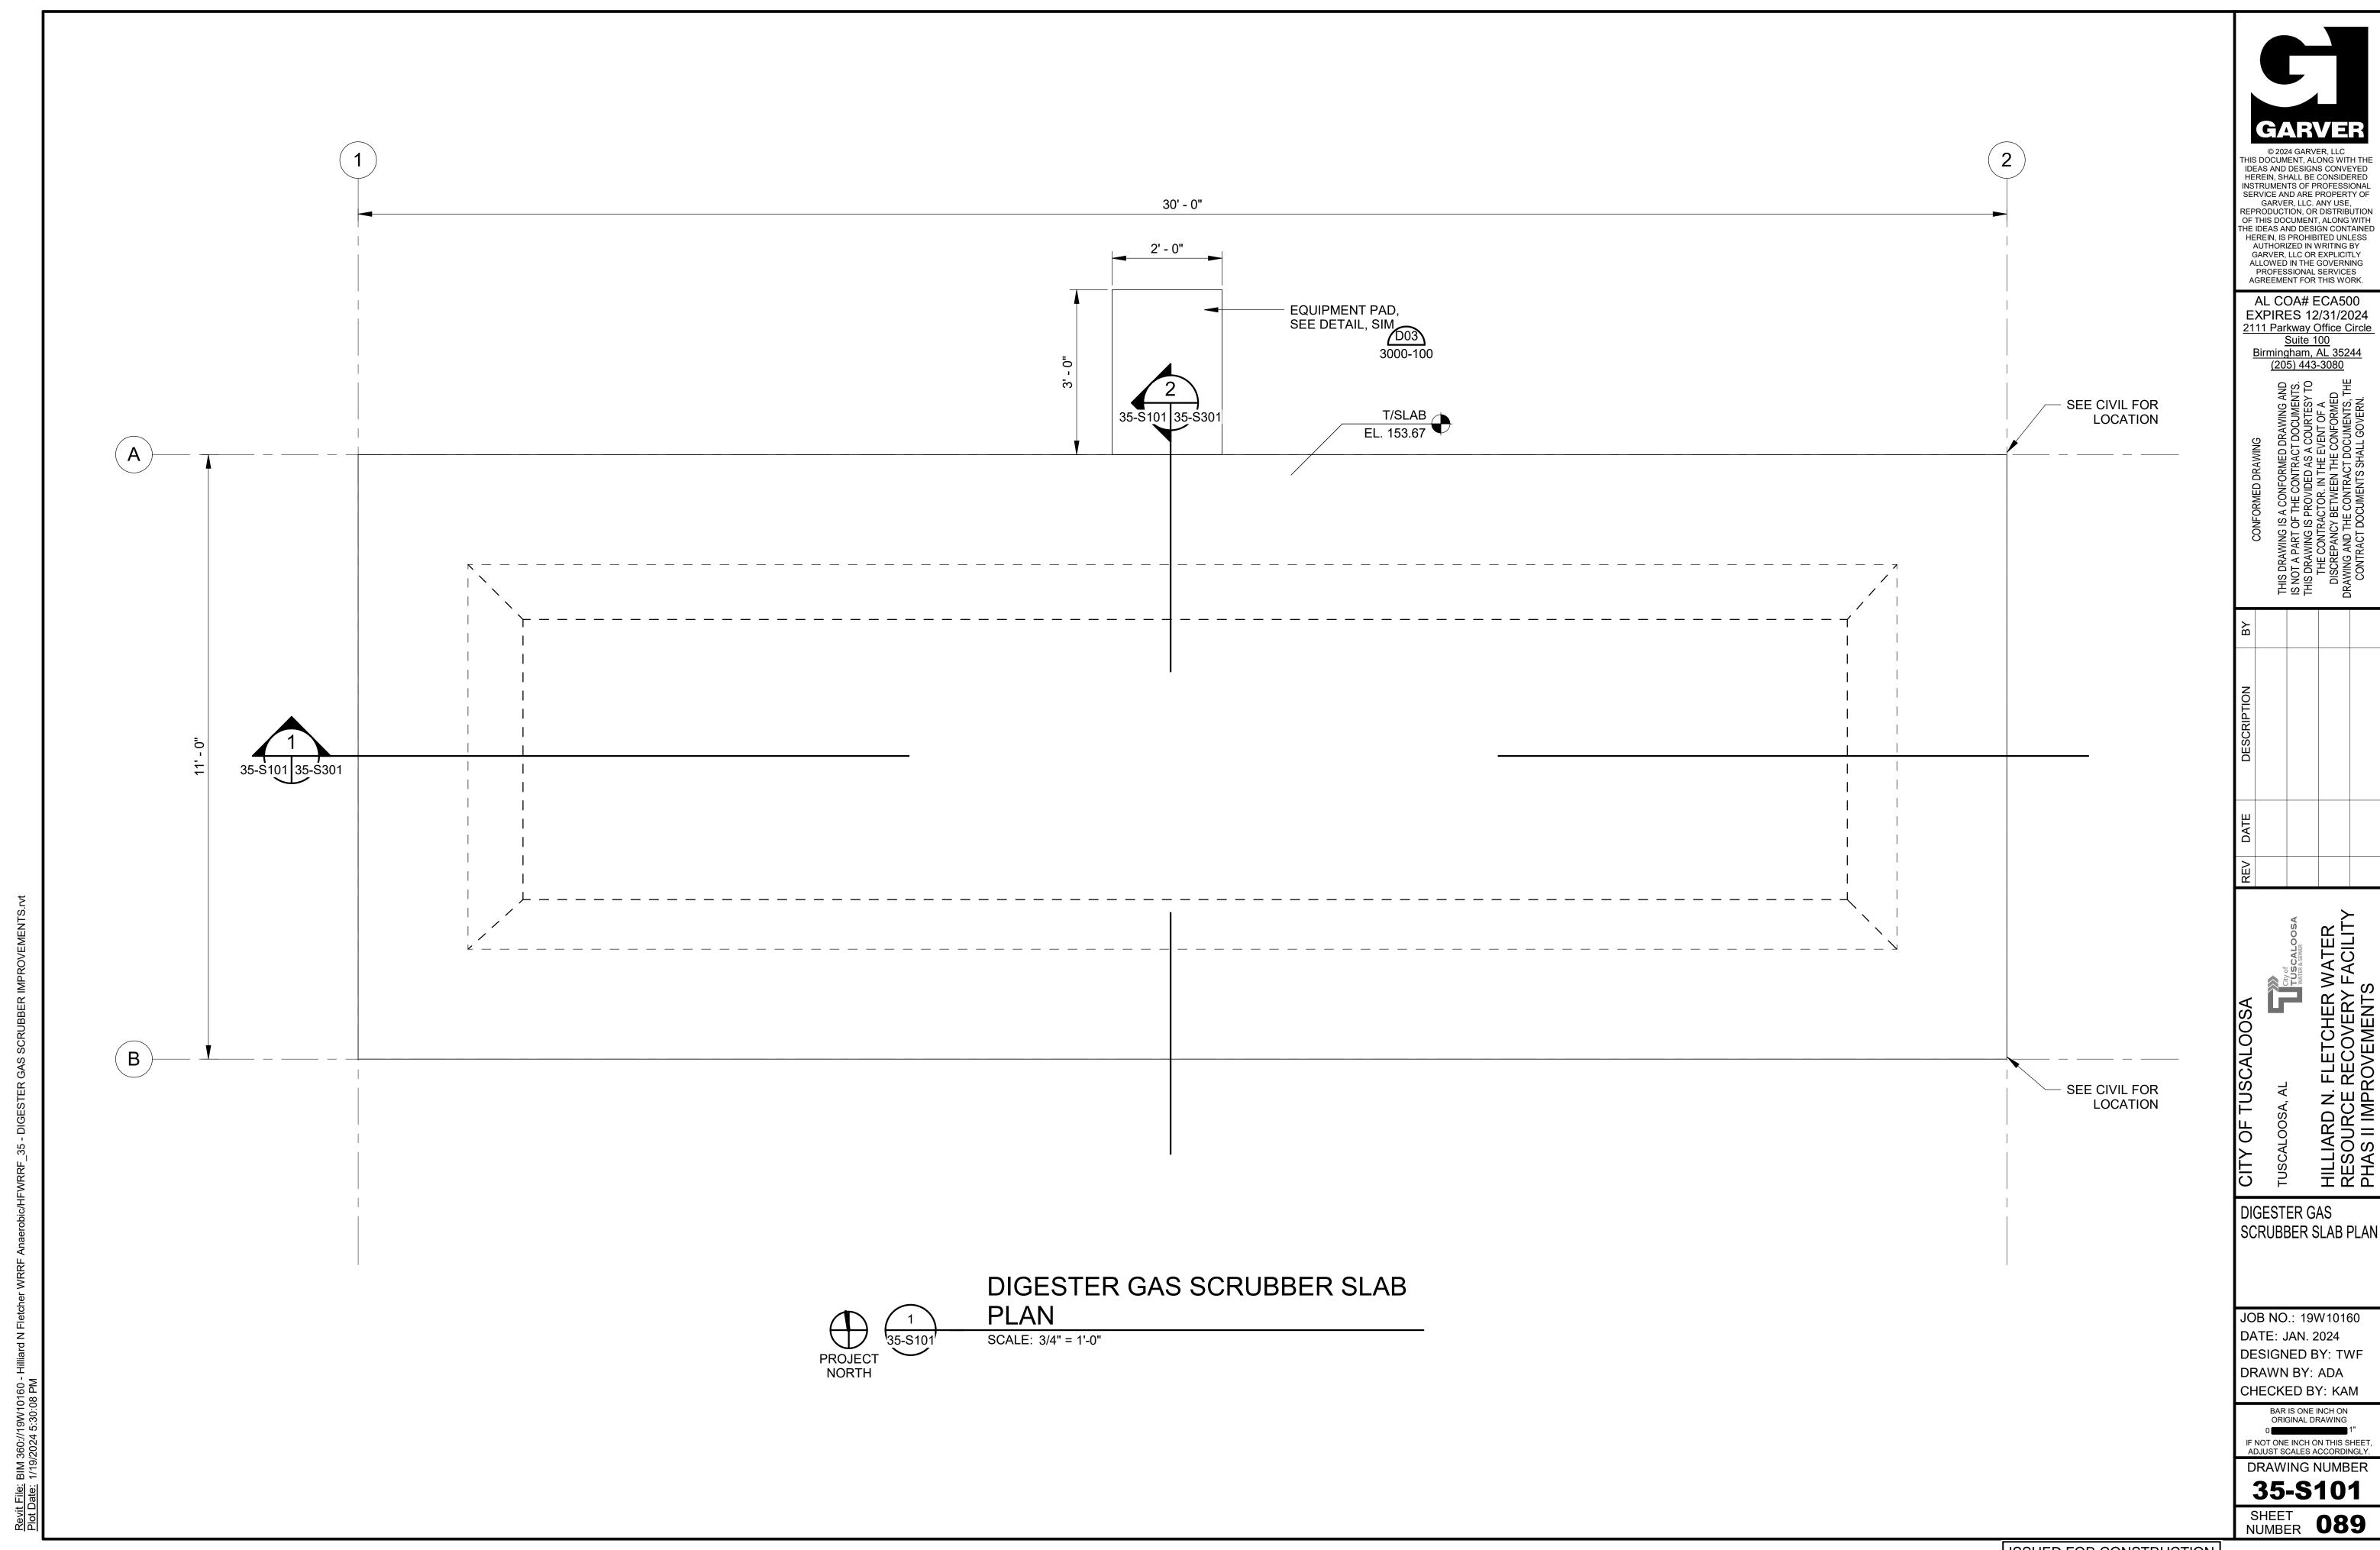



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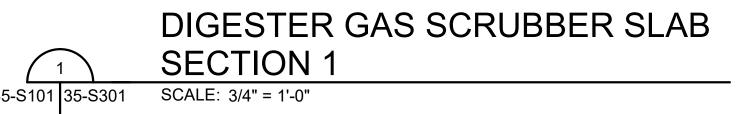
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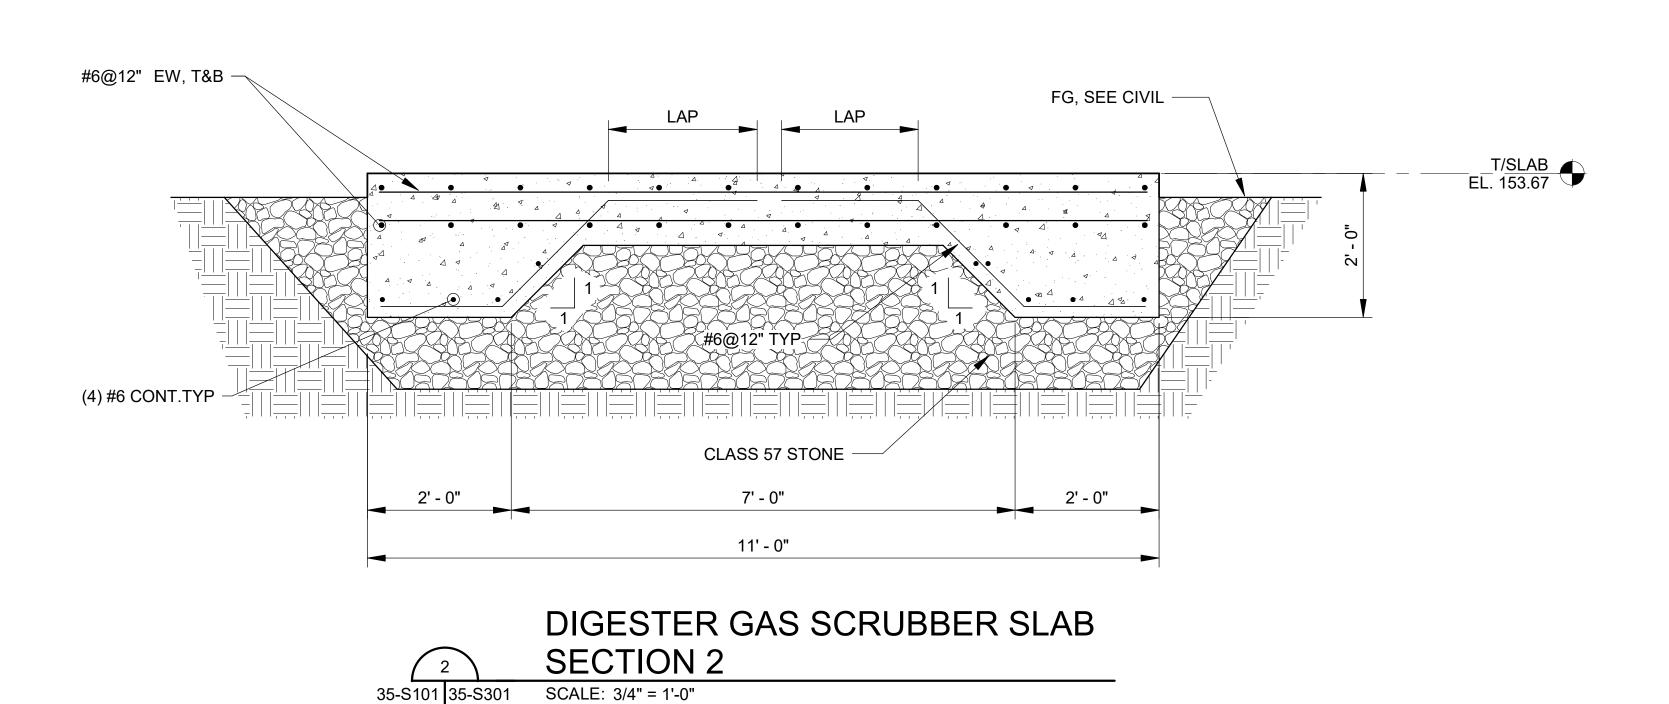
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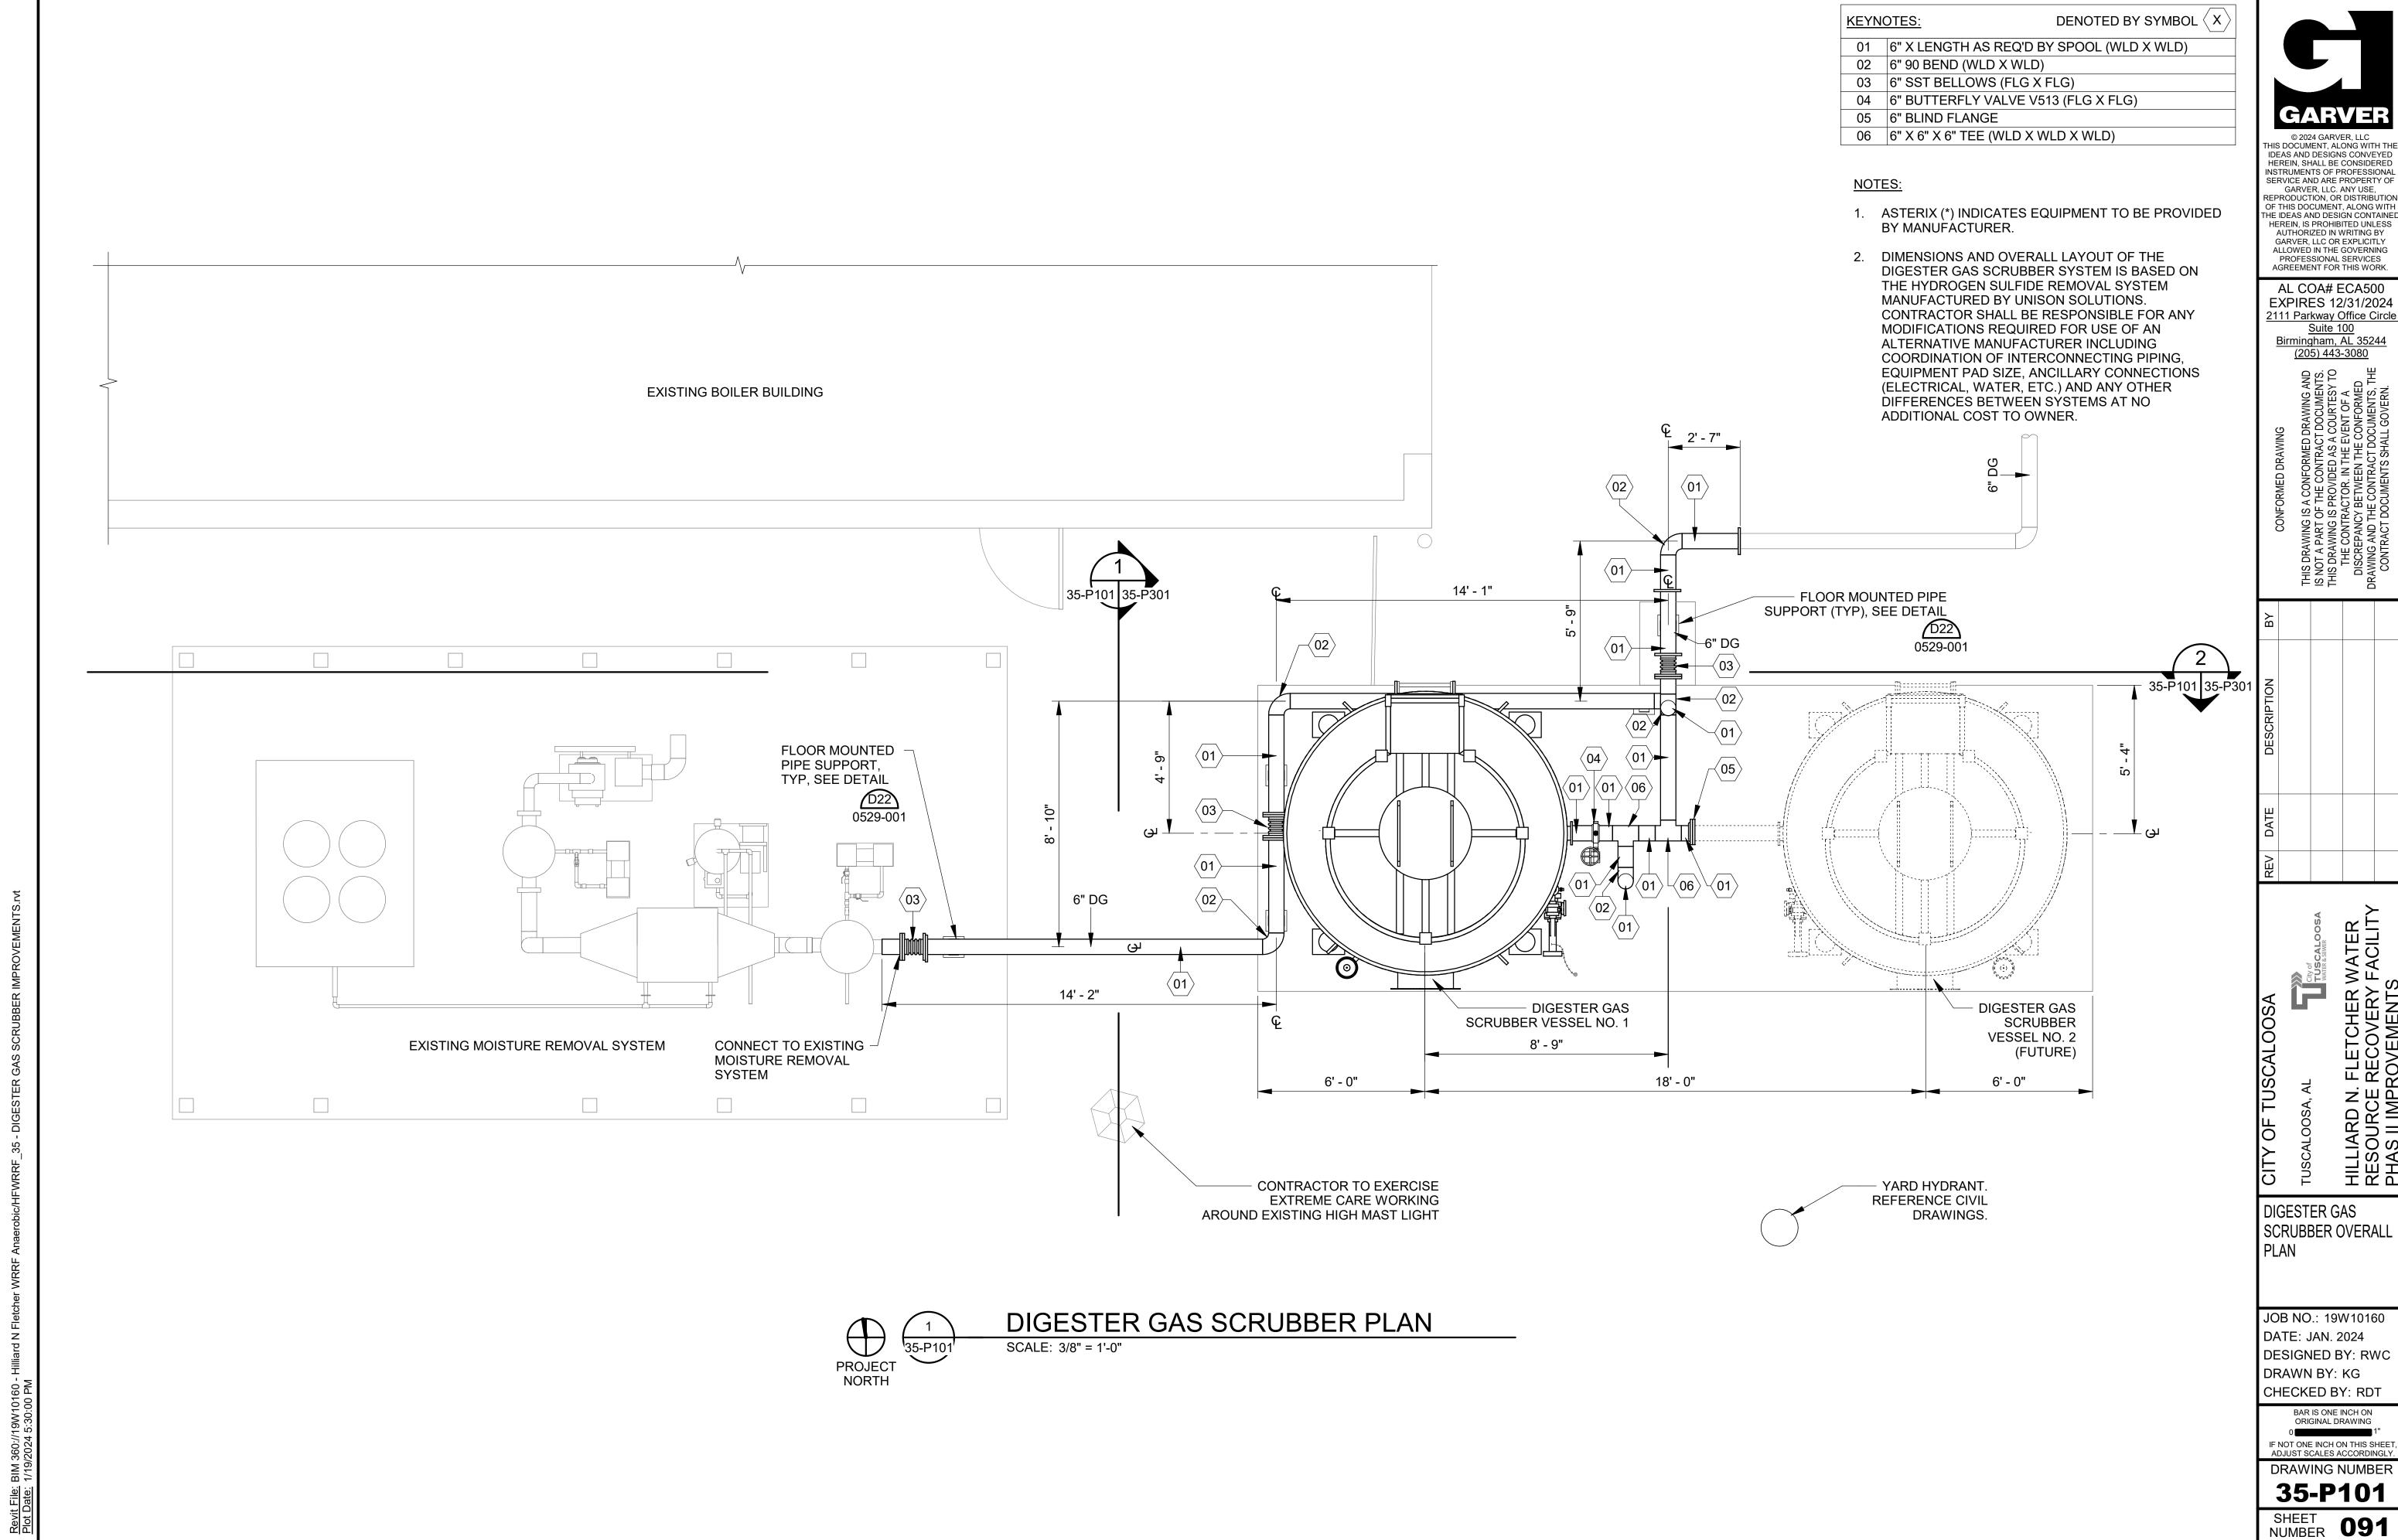
DIGESTER GAS SCRUBBER SLAB SECTIONS

JOB NO.: 19W10160 DATE: JAN. 2024 DESIGNED BY: TWF DRAWN BY: ADA CHECKED BY: KAM


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DSA, AL CITY OF TUSCALOOSA TUSCALOOSA IN FLETCHER WATER RECOVERY FACILITY IN TOP OF THE TOP OF THE

DIGESTER GAS SCRUBBER SECTIONS

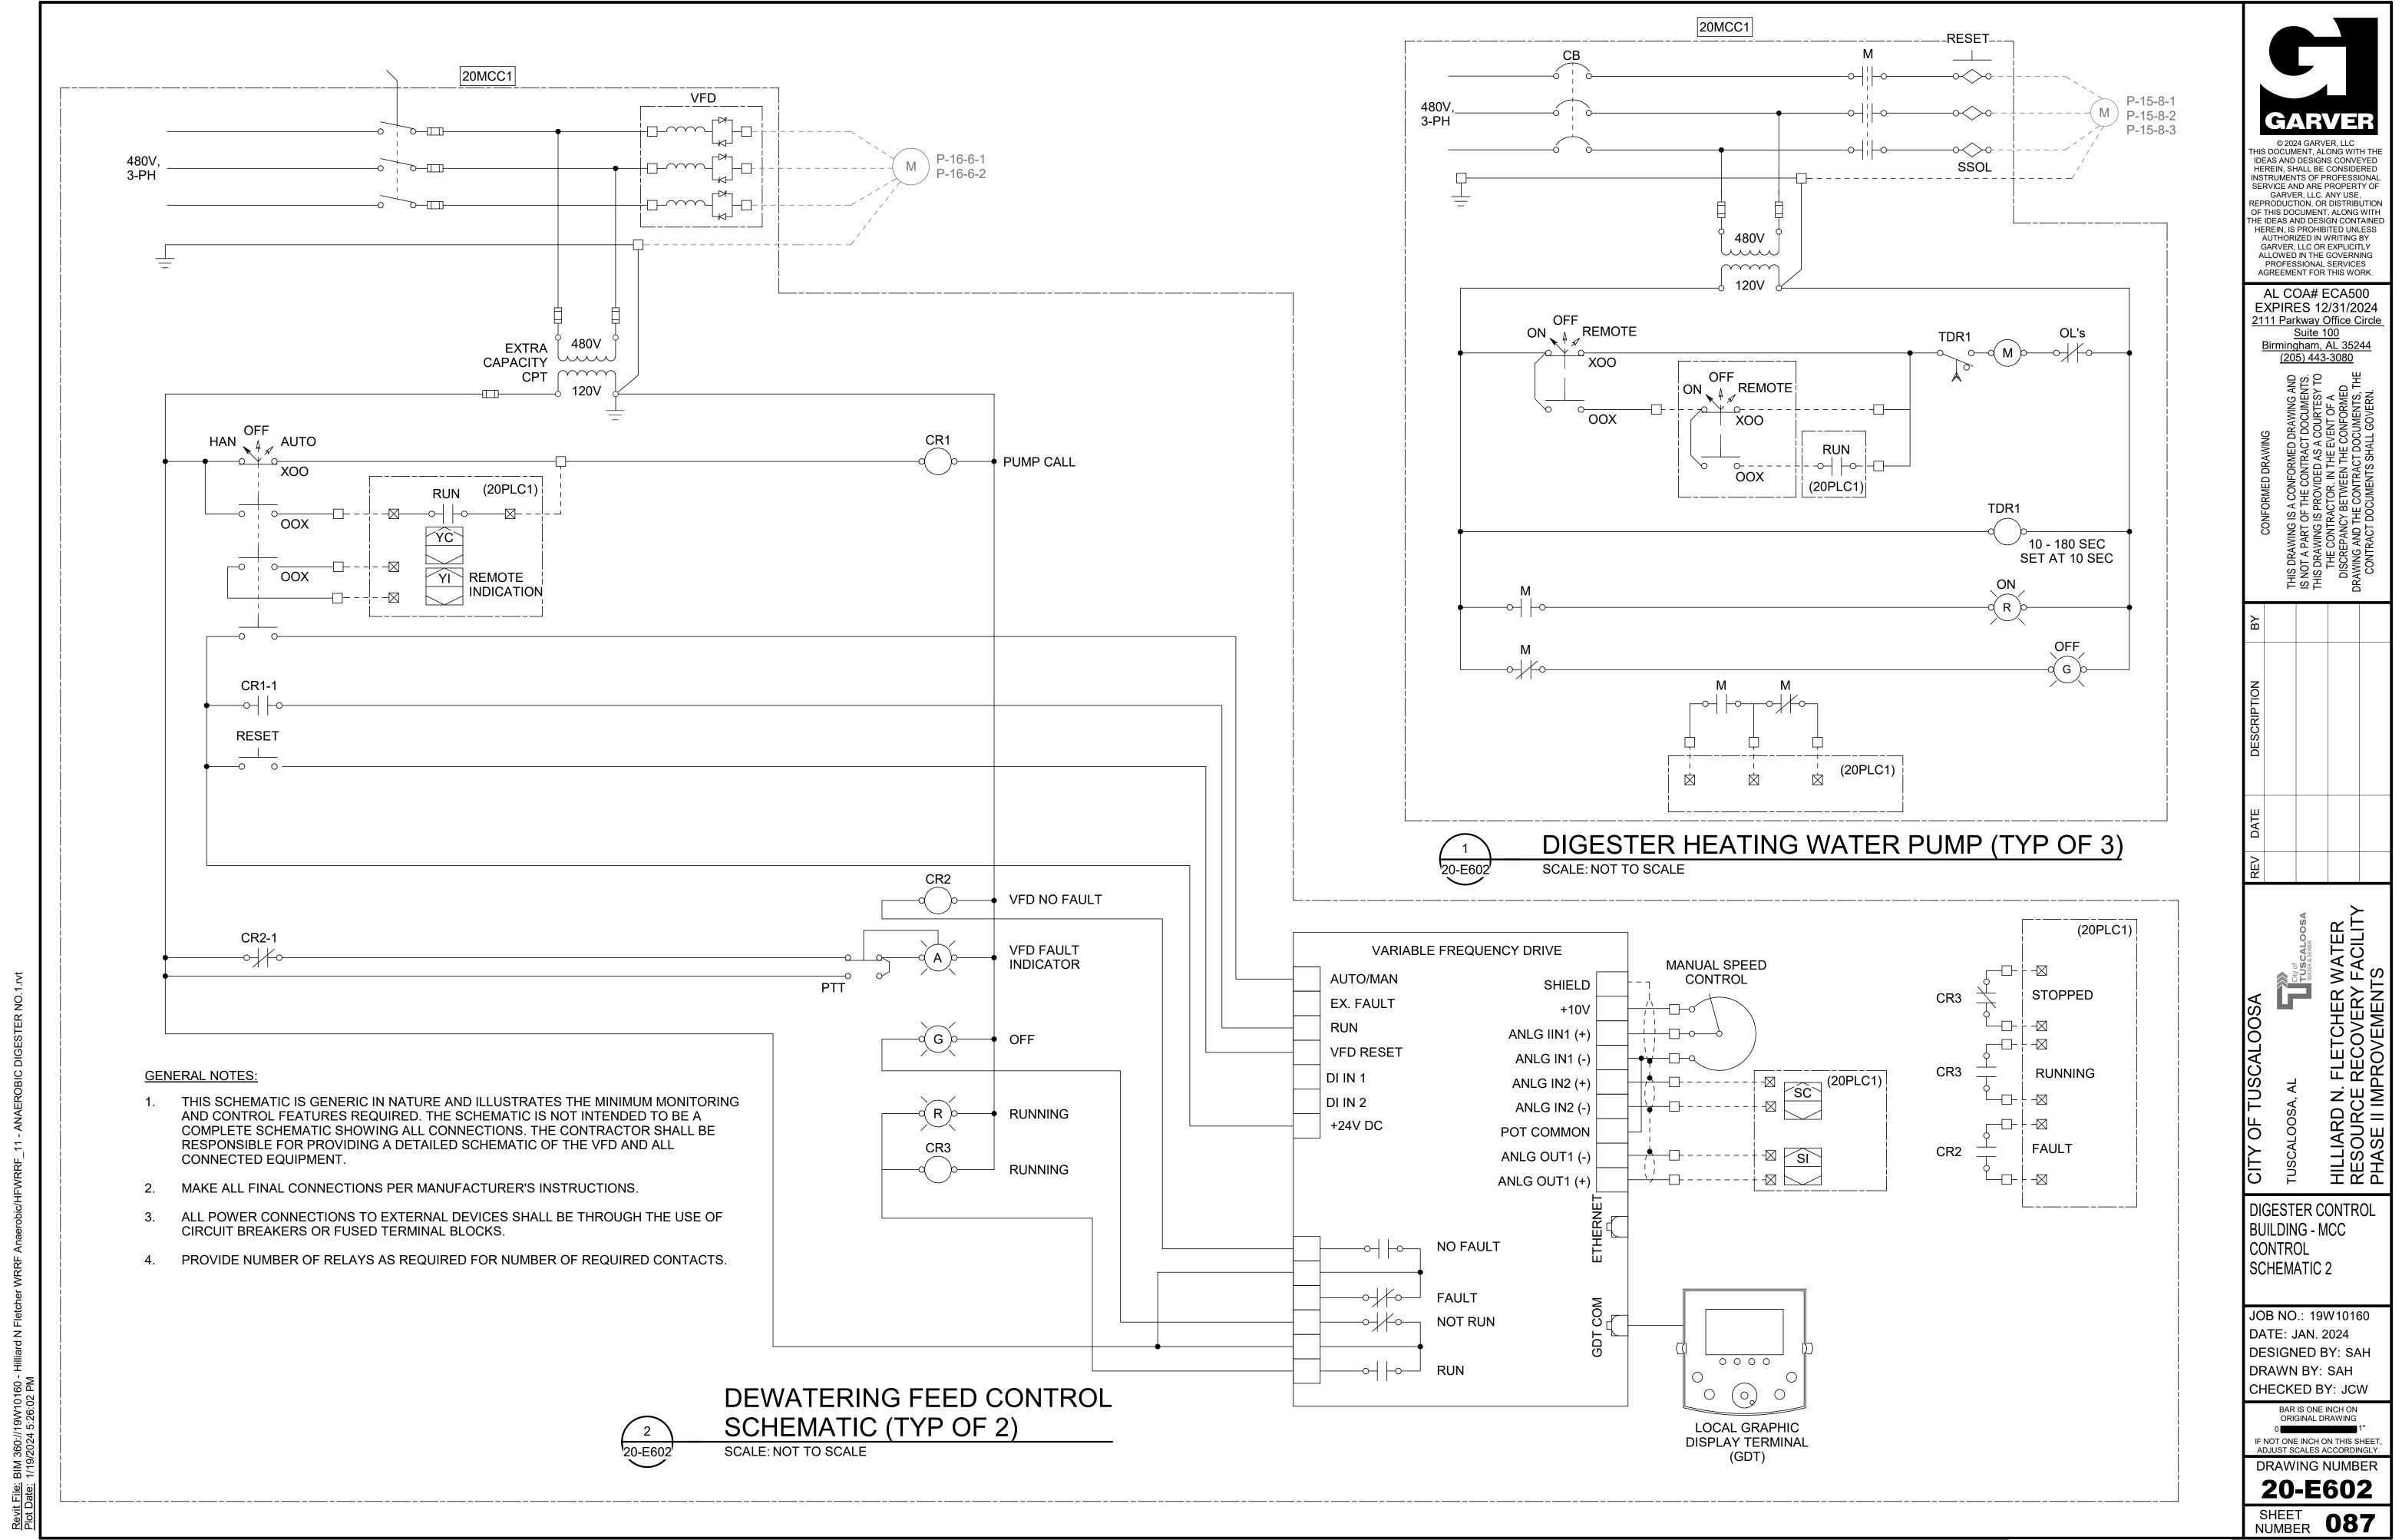JOB NO.: 19W10160 DATE: JAN. 2024 DESIGNED BY: RWC DRAWN BY: WTL CHECKED BY: RDT

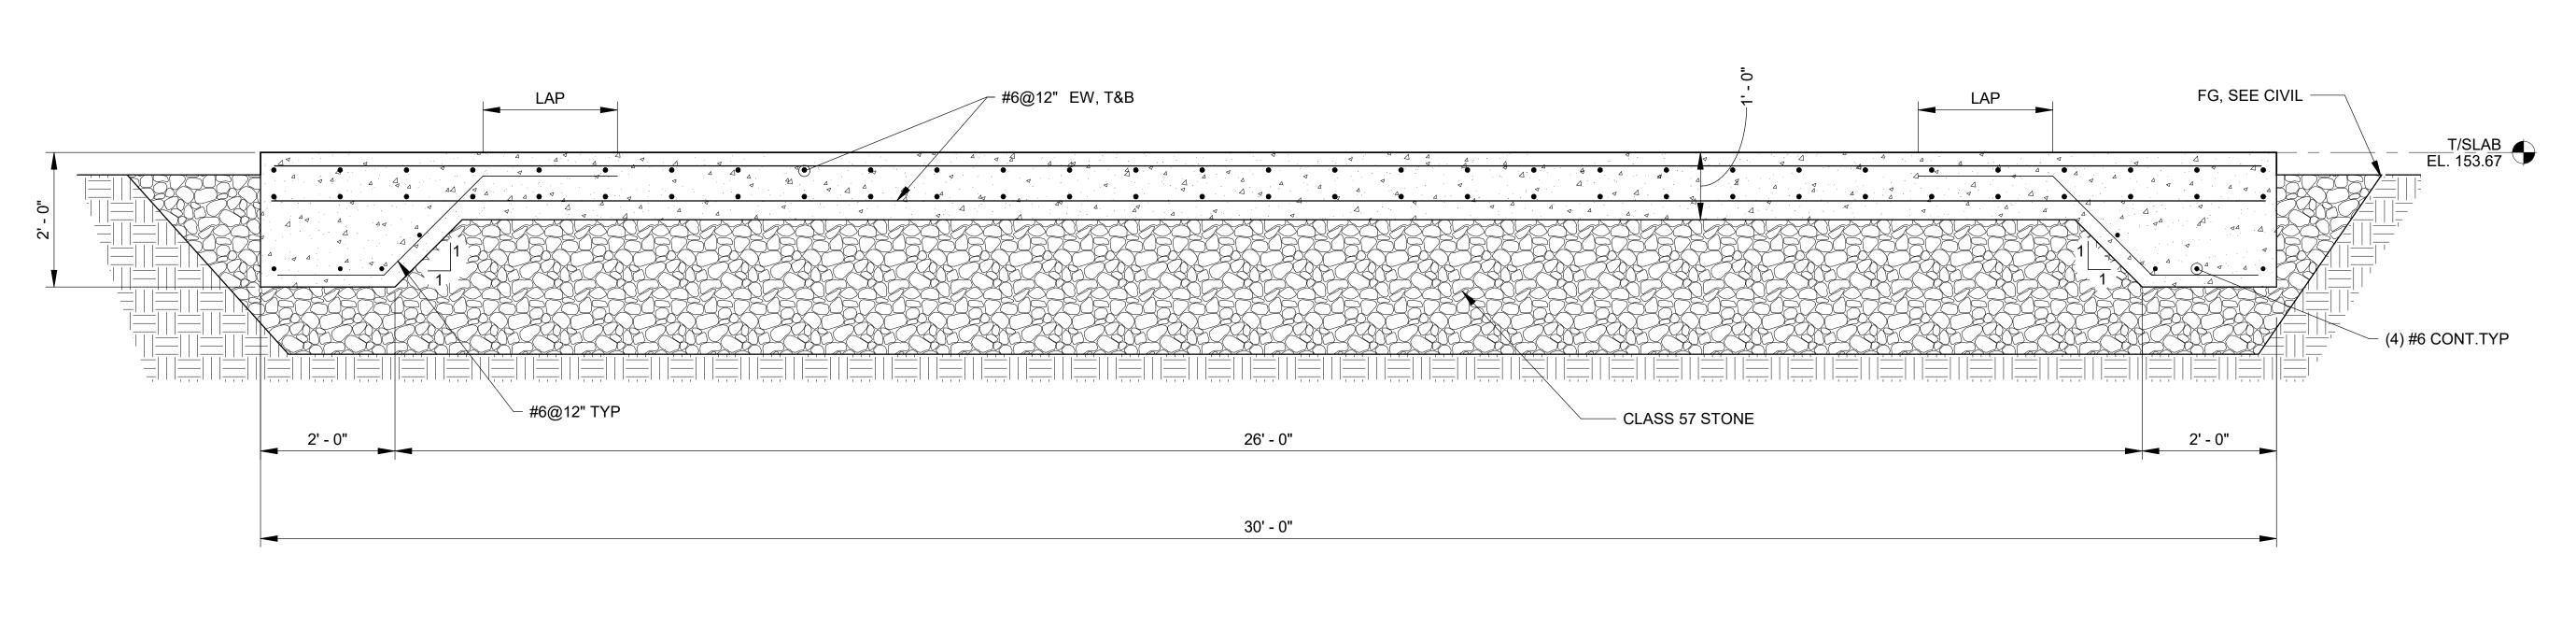
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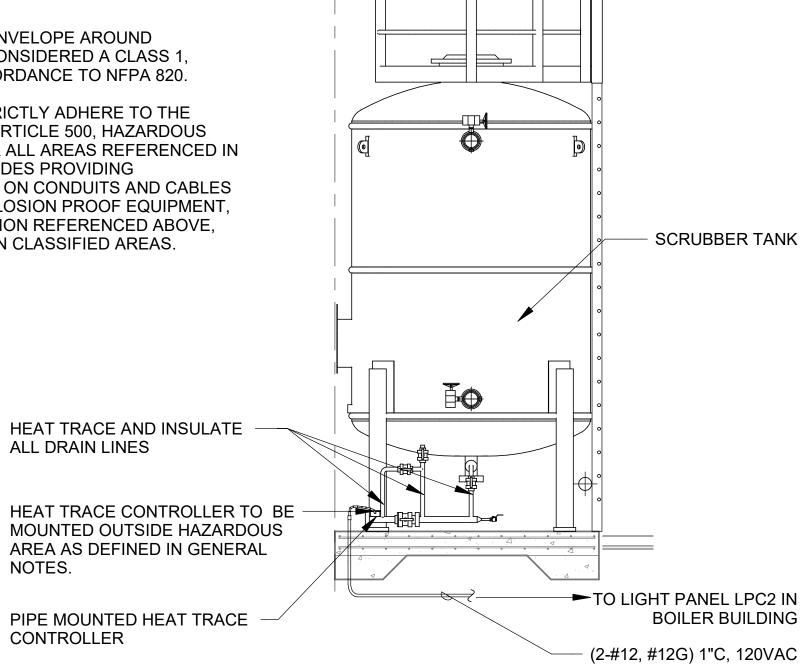
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35-P901 SHEET NUMBER 093

- 1. ALL LOCATIONS WITHIN A 3' ENVELOPE AROUND SCRUBBER TANK SHALL BE CONSIDERED A CLASS 1, DIVISION 2 LOCATION IN ACCORDANCE TO NFPA 820.
- 2. THE CONTRACTOR SHALL STRICTLY ADHERE TO THE REQUIREMENTS IN NFPA 70, ARTICLE 500, HAZARDOUS (CLASSIFIED) LOCATIONS FOR ALL AREAS REFERENCED IN THE NOTE ABOVE. THIS INCLUDES PROVIDING APPROPRIATE SEAL FITTINGS ON CONDUITS AND CABLES ALONG WITH PROVIDING EXPLOSION PROOF EQUIPMENT, RATED FOR THE CLASSIFICATION REFERENCED ABOVE, FOR EQUIPMENT INSTALLED IN CLASSIFIED AREAS.

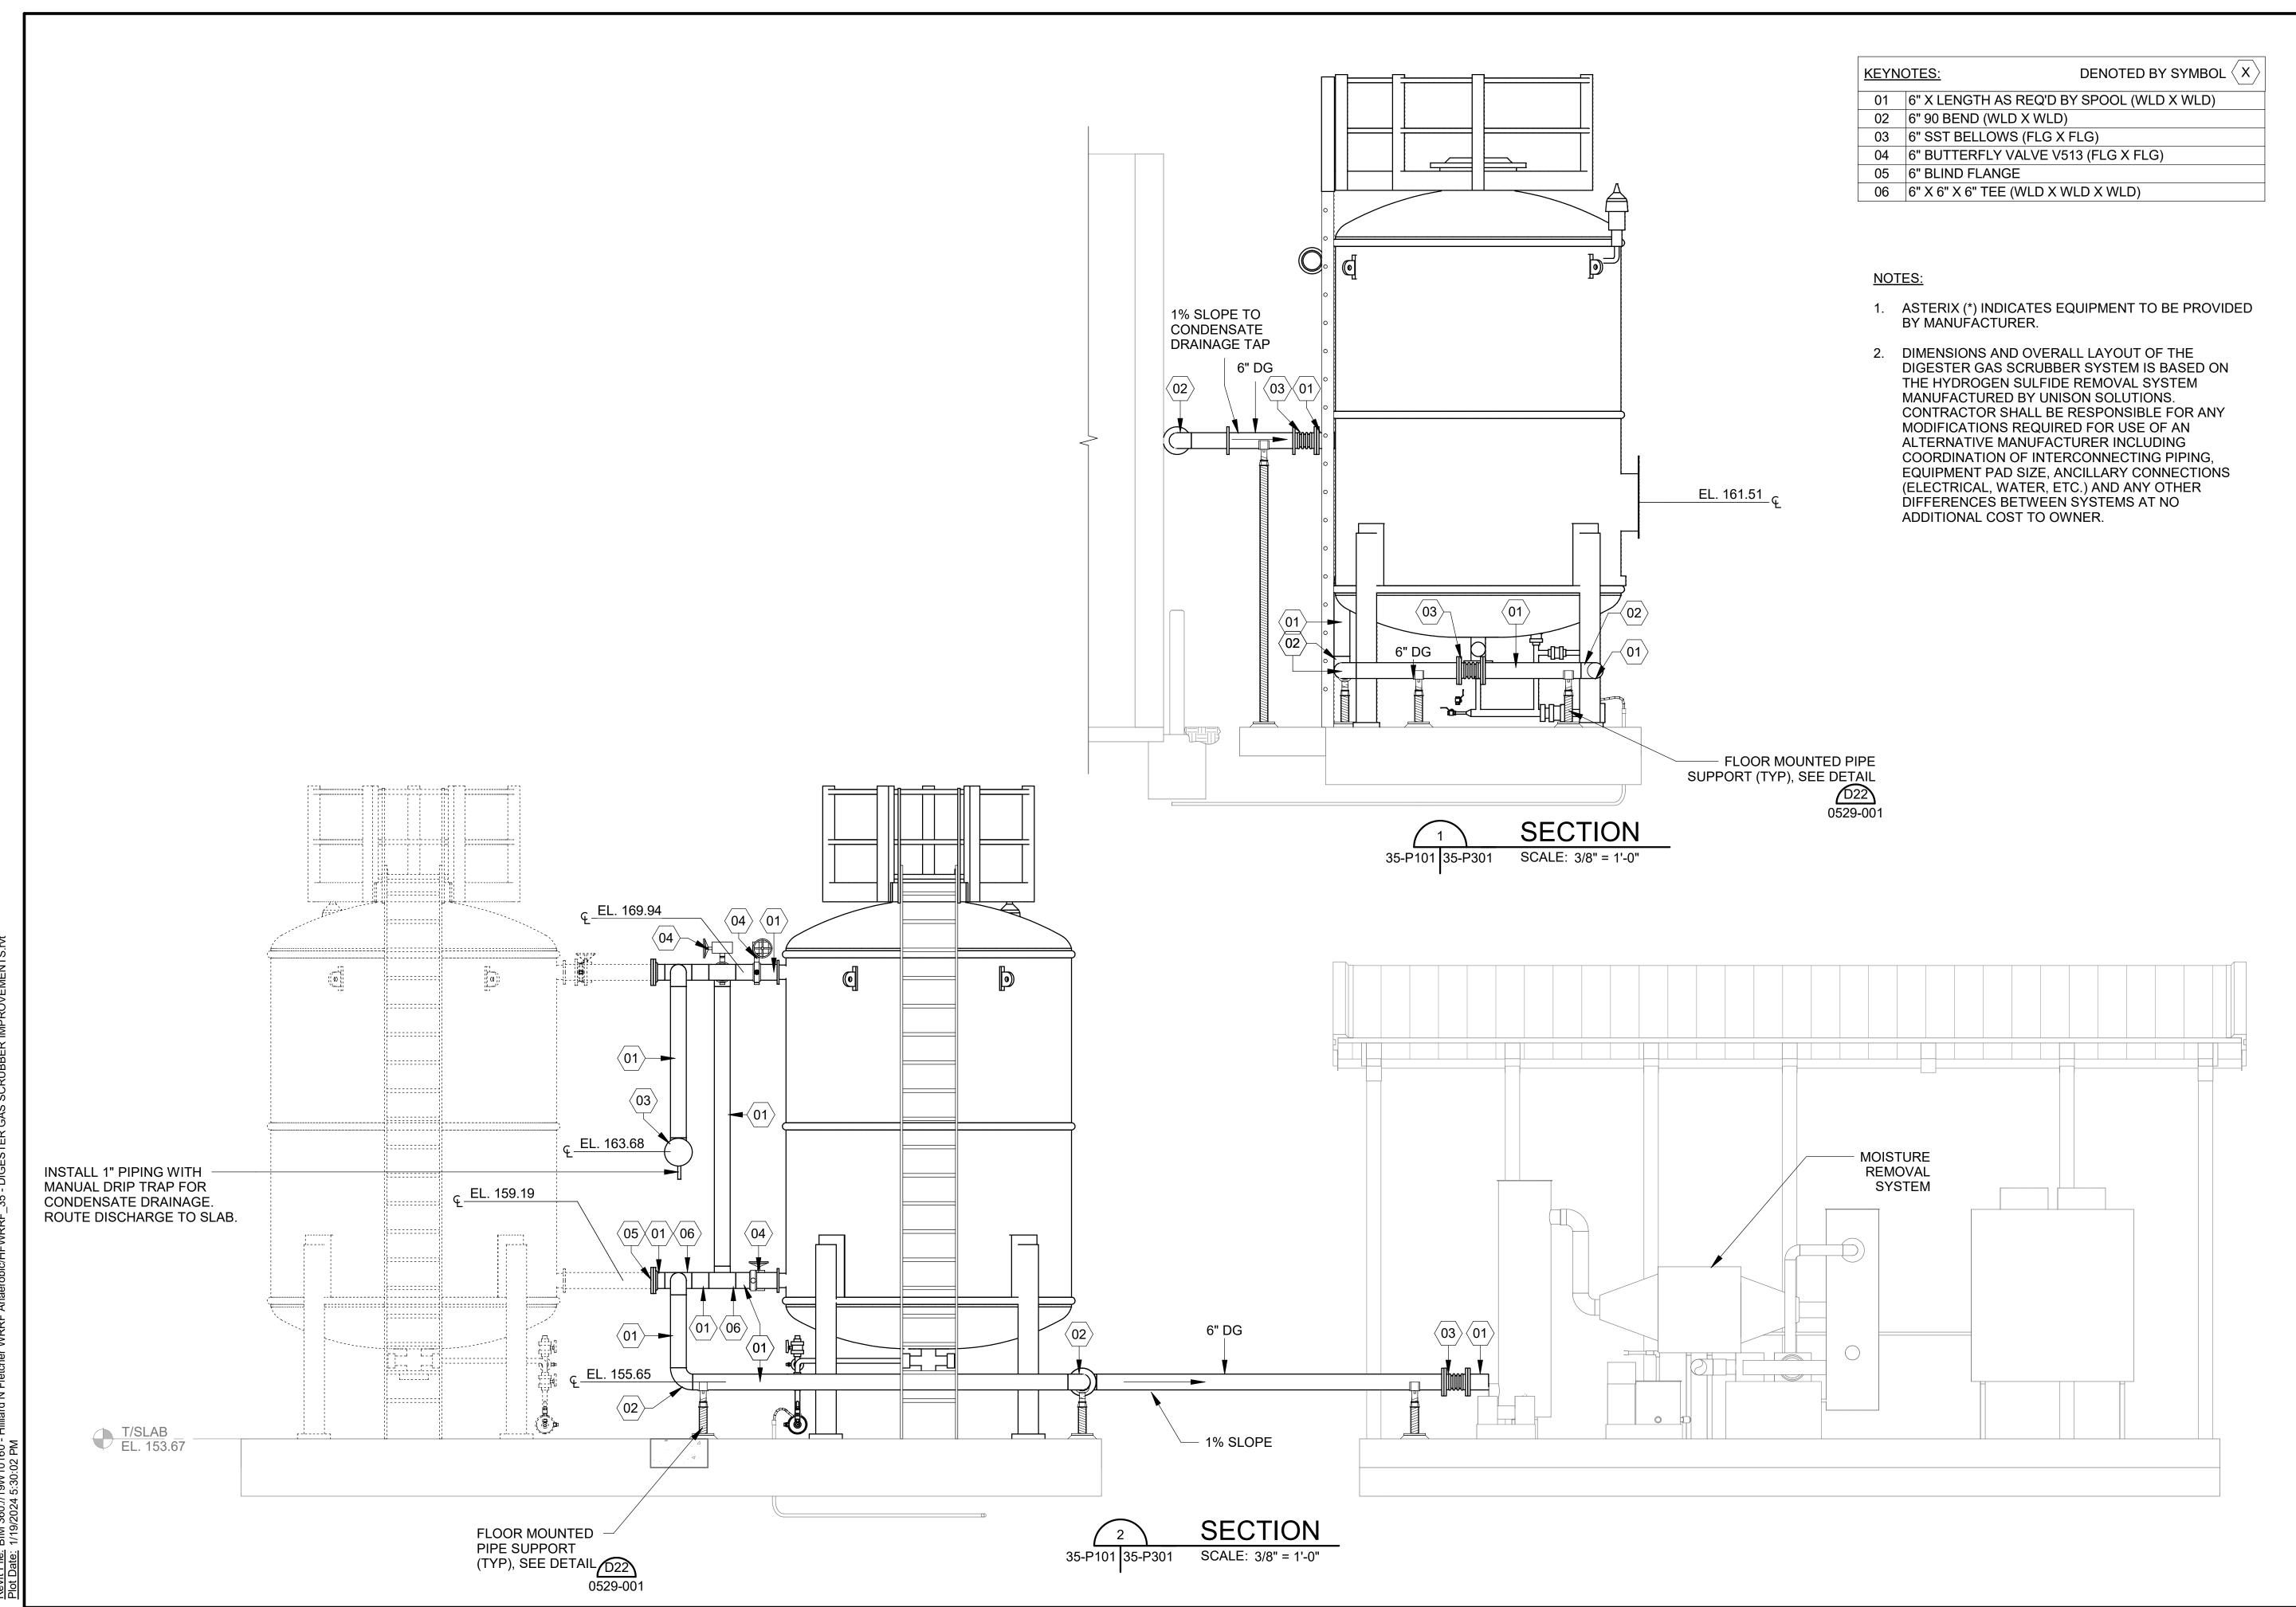


DRAIN PIPING DETAIL SCALE: 1/4" = 1'-0"

						 _ ^_					
		20	32	12	1	V	150			SCRUBBER HT	$\left\langle 1\right\rangle$
		20	34							SPARE	
		20	36							SPARE	
		30/	38				100				
			40	10	3/4			100		SPD-PPC1	
		3P	42						100		

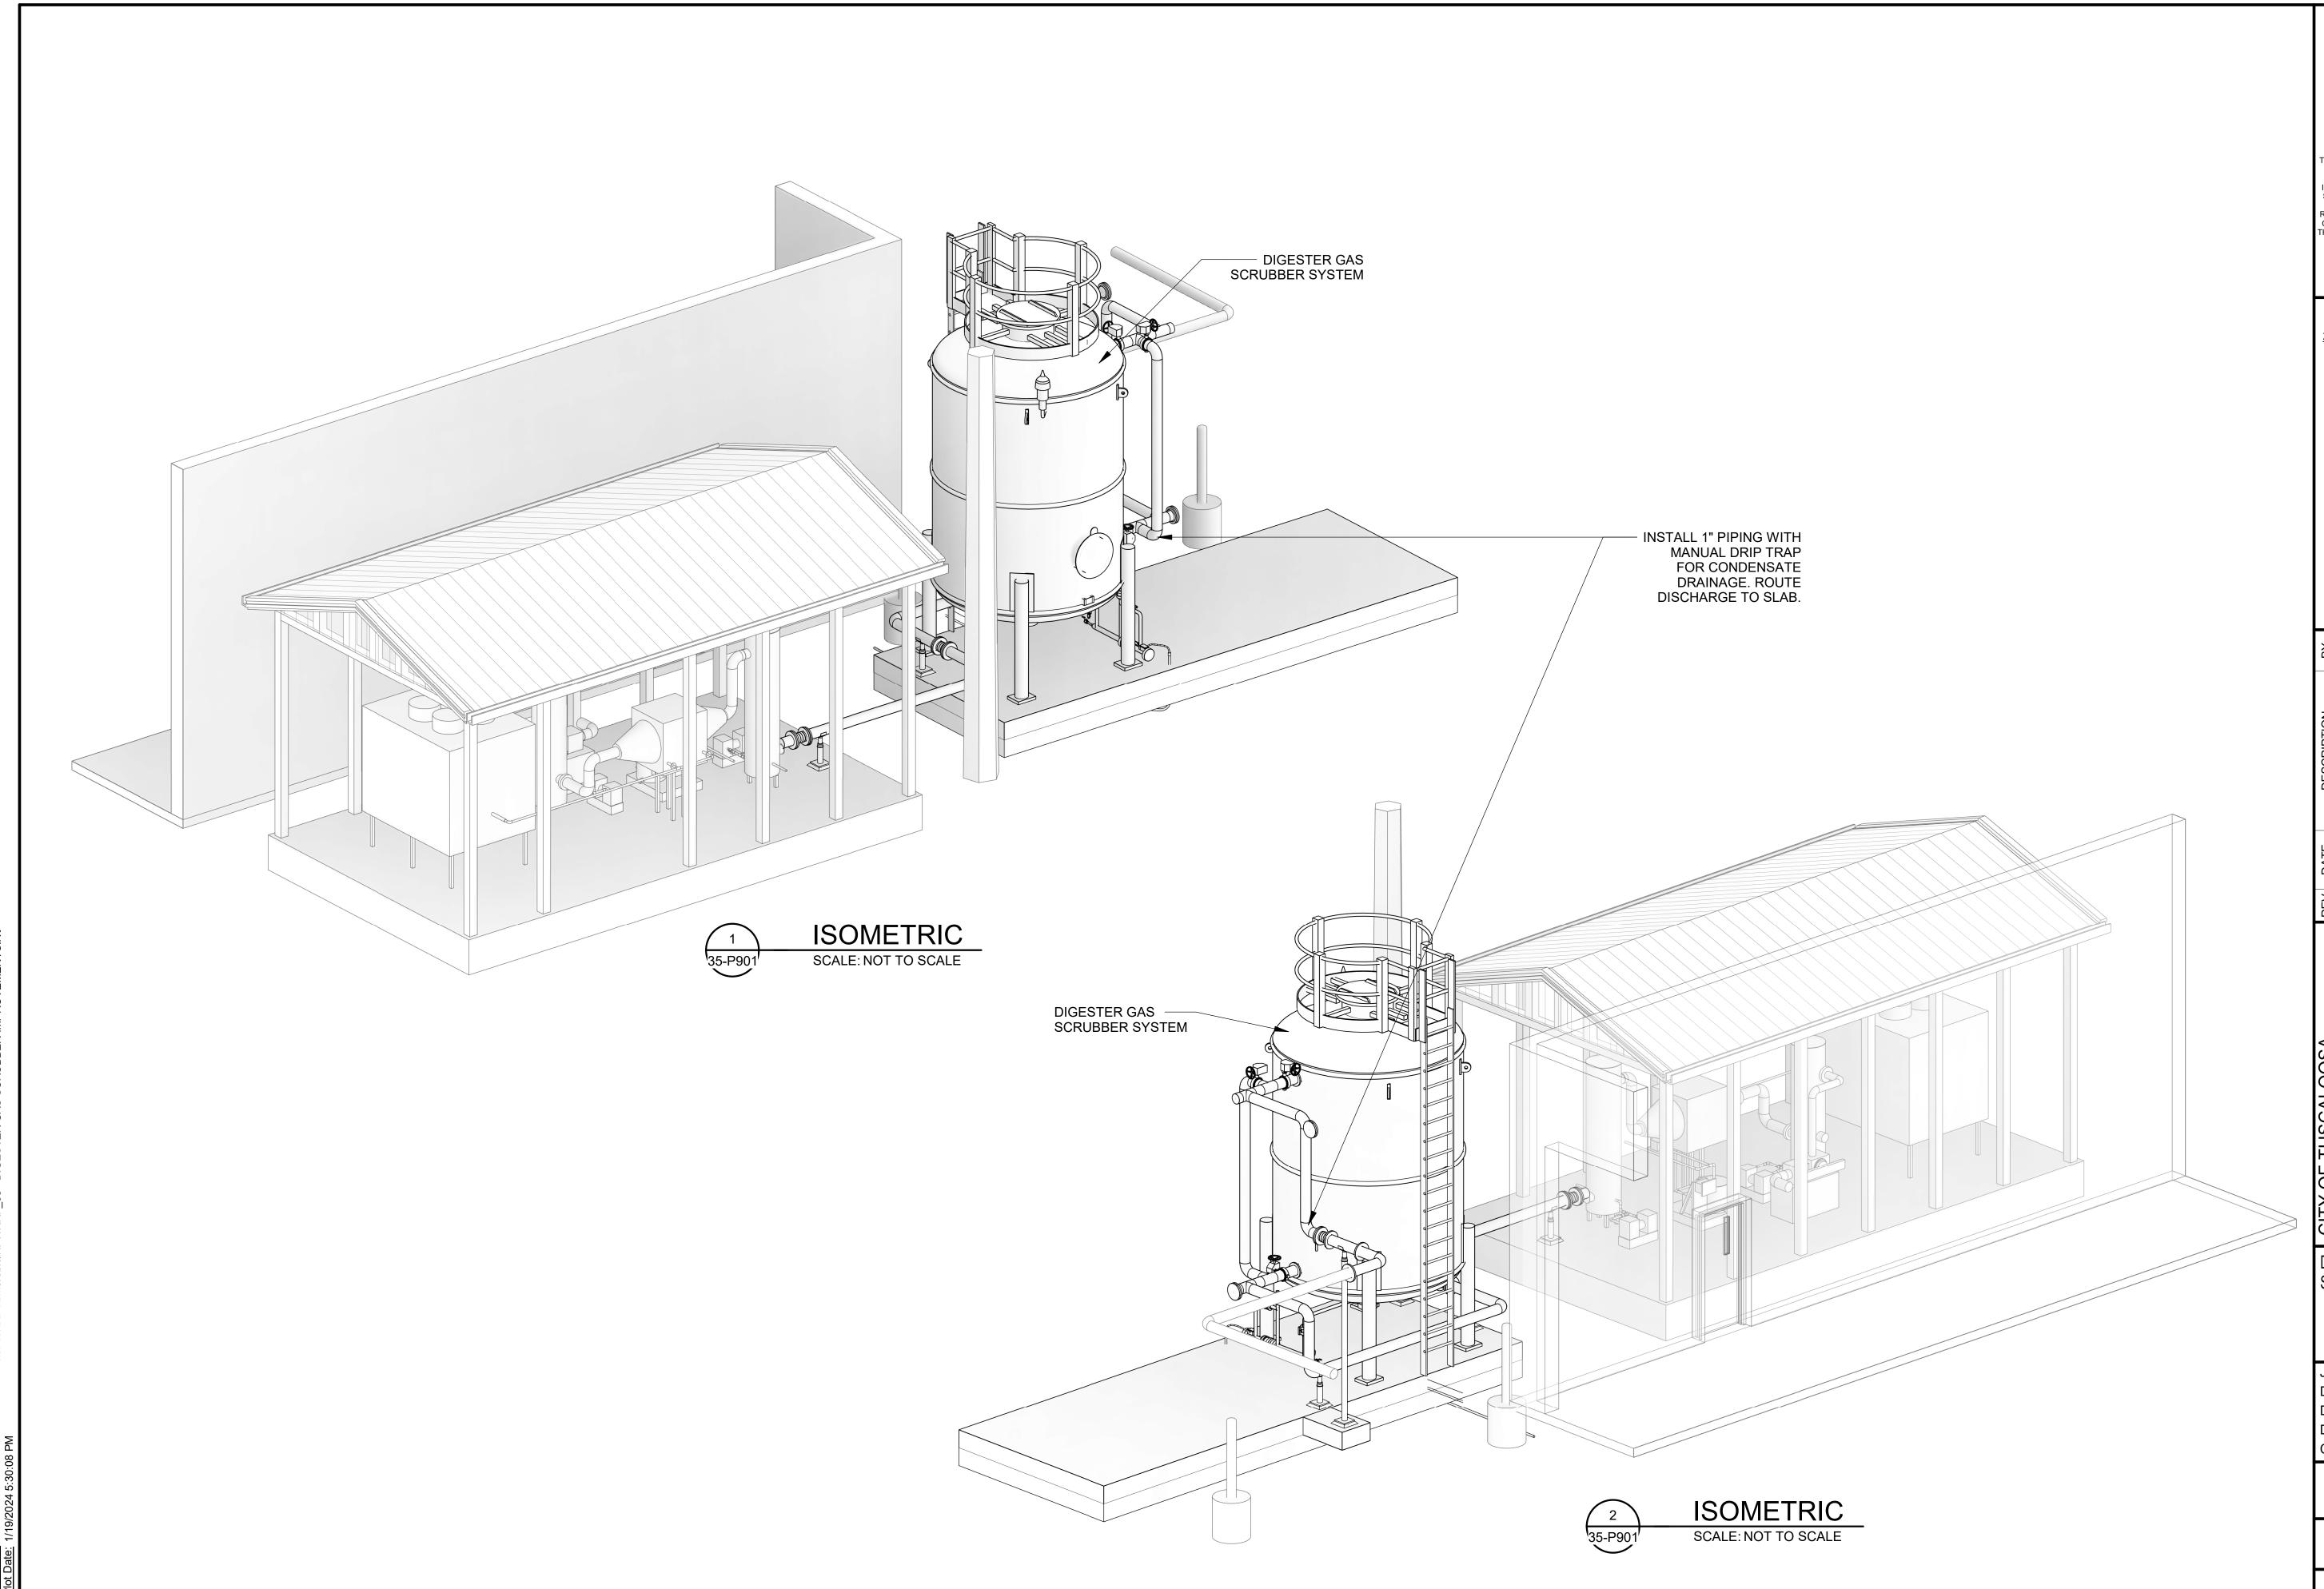
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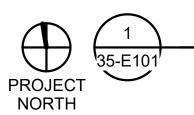
USE SPARE 20A/1P CIRCUIT IN EXISTING LIGHT PANEL LPC2 FOR HEAT TRACE 120VAC POWER. MAKE ALL REQUIRED PANEL MODIFICATIONS AND CONNECTIONS.

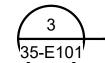

LIGHT PANEL LPC2 MODIFICATION

SCALE: NOT TO SCALE



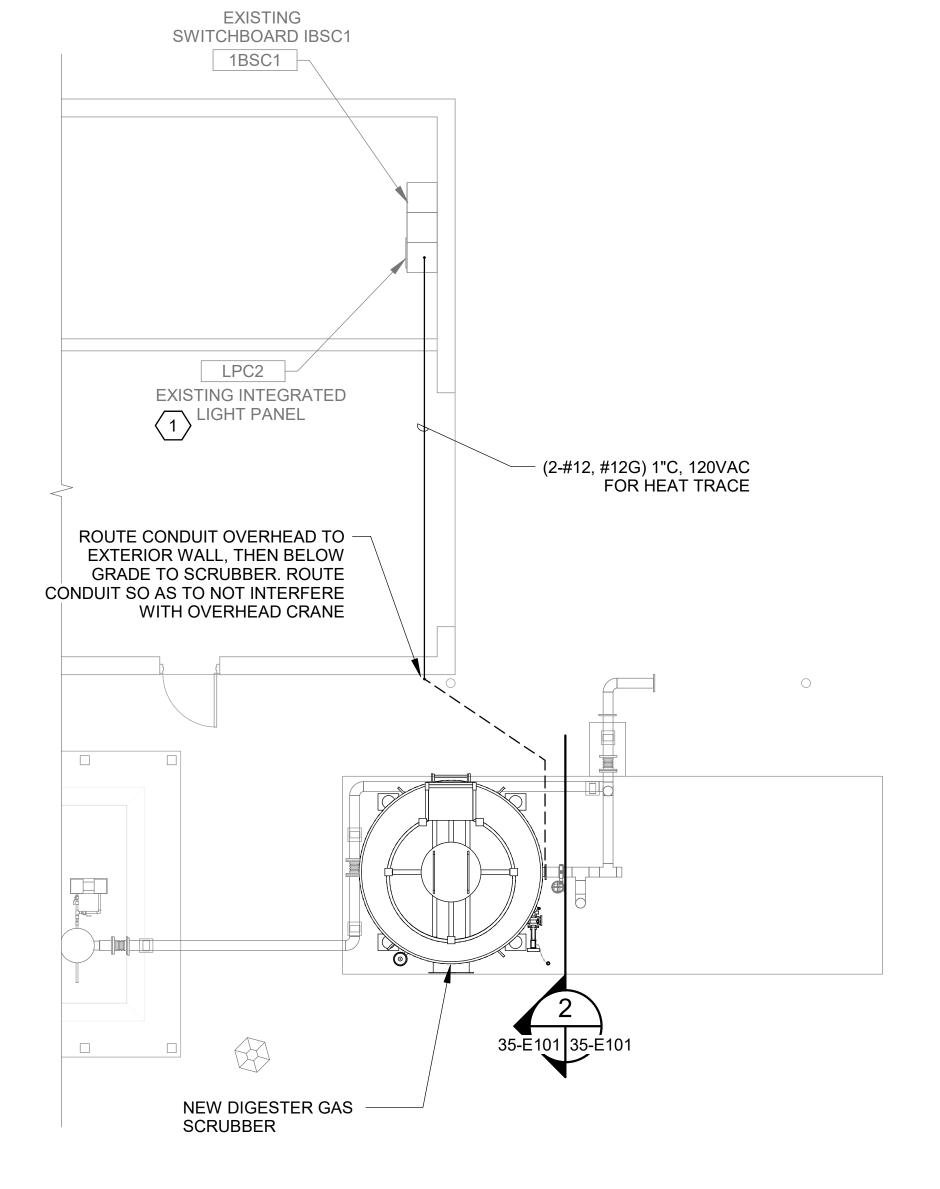

DIGESTER GAS SCRUBBER ELECTRICAL PLAN

SCALE: 3/16" = 1'-0"

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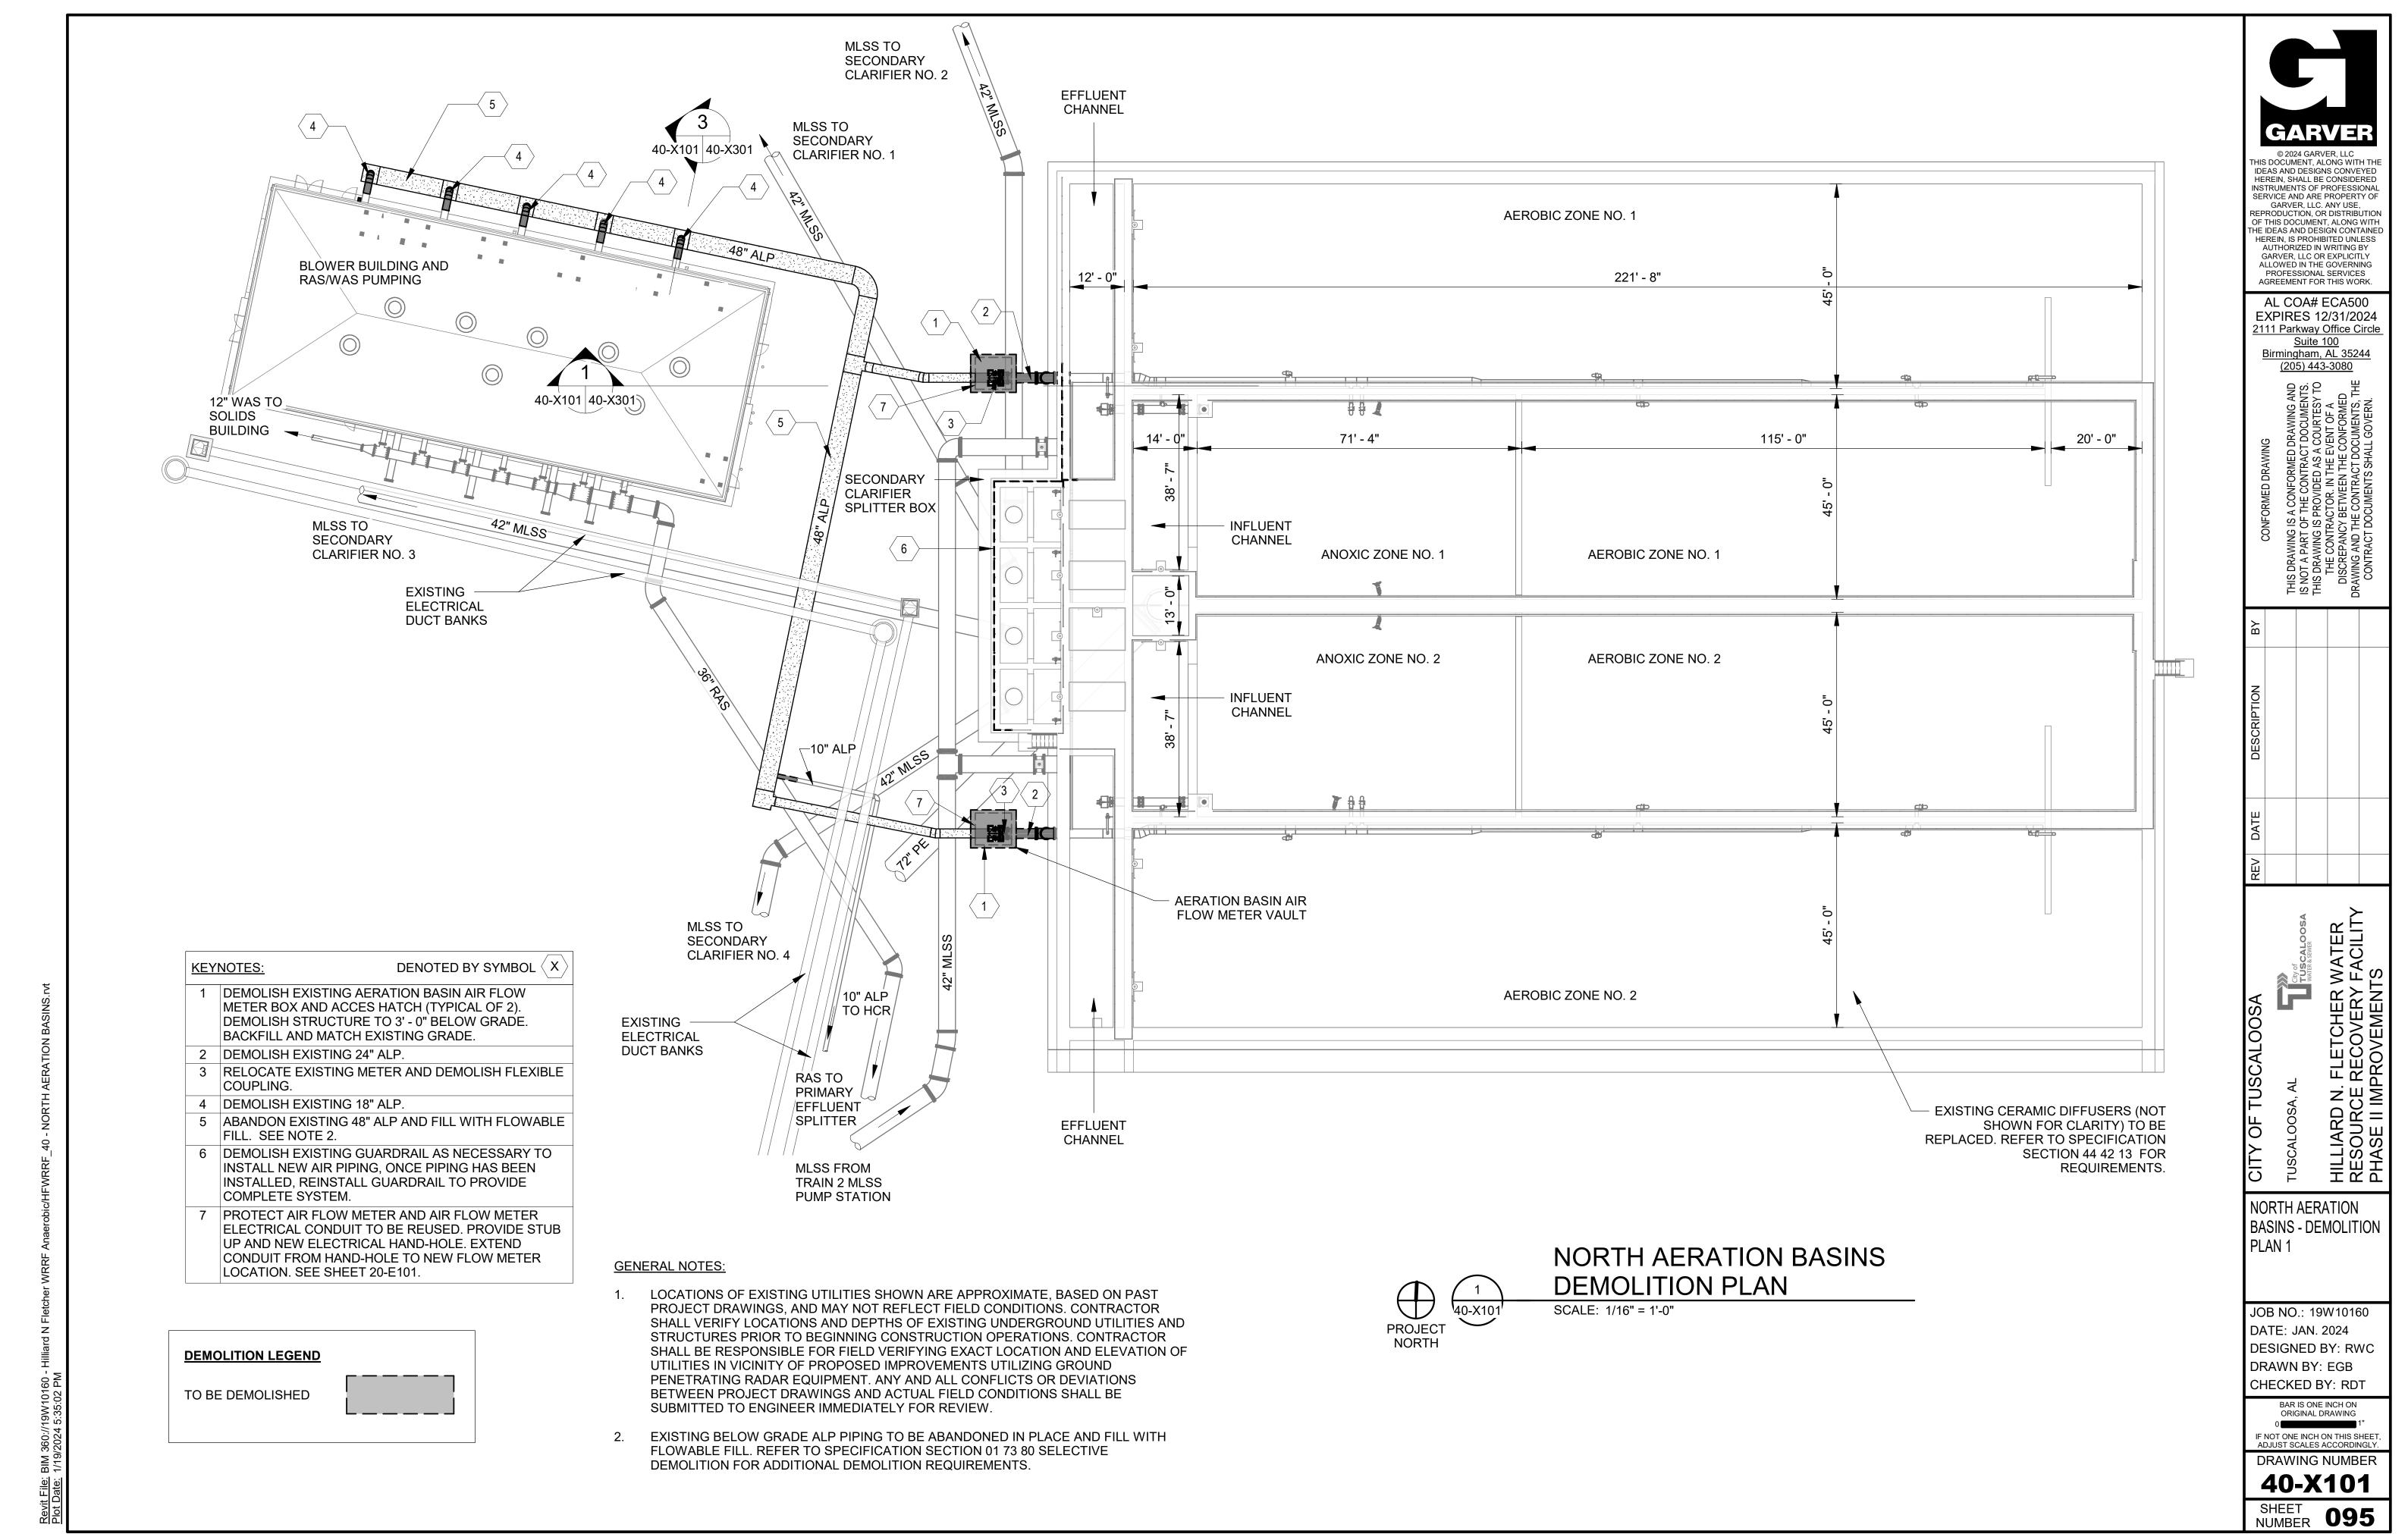
DIGESTER GAS SCRUBBER ELECTRICAL PLAN

JOB NO.: 19W10160 DATE: JAN. 2024 **DESIGNED BY: SAH** DRAWN BY: SAH CHECKED BY: JCW

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35-E101 SHEET 094



TO BE DEMOLISHED



GRID TYPE 1

2 TANKS

2 GRID PER TANK 17 AIR DISTRIBUTORS PER GRID 43 DIFFUSER ELEMENT PER AIR DISTRIBUTOR 731 DIFFUSER ELEMENTS PER GRID

2924 DIFFUSERS TOTAL THIS GRID TYPE

GRID TYPE 2

2 TANKS 1 GRIDS PER TANK 7 AIR DISTRIBUTOR PER GRID

3 AIR DISTRIBUTOR W/53 DIFFUSER ELEMENTS 4 AIR DISTRIBUTOR W/56 DIFFUSER ELEMENTS 383 DIFFUSER ELEMENTS PER GRID 766 DIFFUSER TOTAL THIS GRID TYPE

2 TANKS 3 GRIDS PER TANK 17 AIR DISTRIBUTOR PER GRID

31 DIFFUSER ELEMENTS PER AIR DISTRIBUTOR 527 DIFFUSER ELEMENTS PER GRID 3162 DIFFUSERS TOTAL THIS GRID TYPE

2'-0"

115'-0"

56'-9"

EXISTING DIFFUSERS, DIFFUSER AIR 221'-8" PIPING AND ALL OTHER COMPONENTS 200'-4" OF THE FINE BUBBLE DIFFUSER GRID IN AEROBIC ZONES AND EFFLUENT 34'-11" 63'-8" 30'-8" 67'-8" CHANNEL TO BE REMOVED (TYP) 1'-4" 3'-5" 62'-2" GRID AREA 62'-2" GRID AREA 62'-2" GRID AREA 2'-4" 4'-8" H.P. FLOOR 135.30 _GRID TYPE 3: GRID 3C __AEROBIC ZONE NO. 2 134.84 GRID TYPE 3: **GRID TYPE 3:** L.P. FLOOR TYPE 2 GRID 3A-GRID 3B H.P. FLOOR 40-X102 40-X302 135.30 40-X102 40-X302 RGE SUMP ASSEMBLY E DETAIL 80 PRESSURE MONITORING COLUMN, H.P. FLOOR BOX & EQUIPMENT SEE PAGE E-19 (TYP 1 PER DROPLEG) 15-8D 40-X102 40-X302 ANOXIC BASIN ZONE NO. 2 15-8D ANOXIC ZONE NO. 2 134.84 LP GRID TYPE 1:

GENERAL NOTES:

NEW AERATION BASIN

1 SHOWN

PLAN VIEW (39)

1 MIRROR IMAGE

- DRAWING BACKGROUND IS REPRODUCTION OF EXISTING AERATION SYSTEM SHOP DRAWINGS AND IS PROVIDED FOR INFORMATION ONLY. FIELD CONDITIONS HAVE NOT BEEN VERIFIED AND MAY DIFFER FROM THAT SHOWN HEREIN.
- 2. THIS PARTIAL DEMOLITION PLAN VIEW IS REPRESENTATIVE OF ONE NORTH AERATION BASIN. ALL NECESSARY DEMOLITION INDICATED SHALL BE REQUIRED AT REMAINING BASIN. THE REMAINING BASIN LAYOUT IS A MIRROR IMAGE OF THE PLAN VIEW SHOWN.
- CONTRACTOR BASE BID SHALL BE BASED ON DEMOLITION INDICATED HEREIN AND SPECIFIED IN SPECIFICATION SECTION 44 42 13. FOR DEDUCTIVE ALTERNATE A, SCOPE OF DEMOLITION SHALL BE IN SPECIFICATION SECTION 01 11 20.
- 4. EXISTING COARSE BUBBLE AERATION SYSTEMS IN ANOXIC ZONES SHALL REMAIN.

PROJECT NORTH

28'-6"

NORTH AERATION BASINS - PARTIAL DEMOLITION PLAN VIEW SCALE: 1" = 1'-0"

GRID 1A

H.P. FLOOR 135.30-

29'-9"

54'- 9" GRID AREA

ISSUED FOR CONSTRUCTION

GRID TYPE 1: GRID 1B

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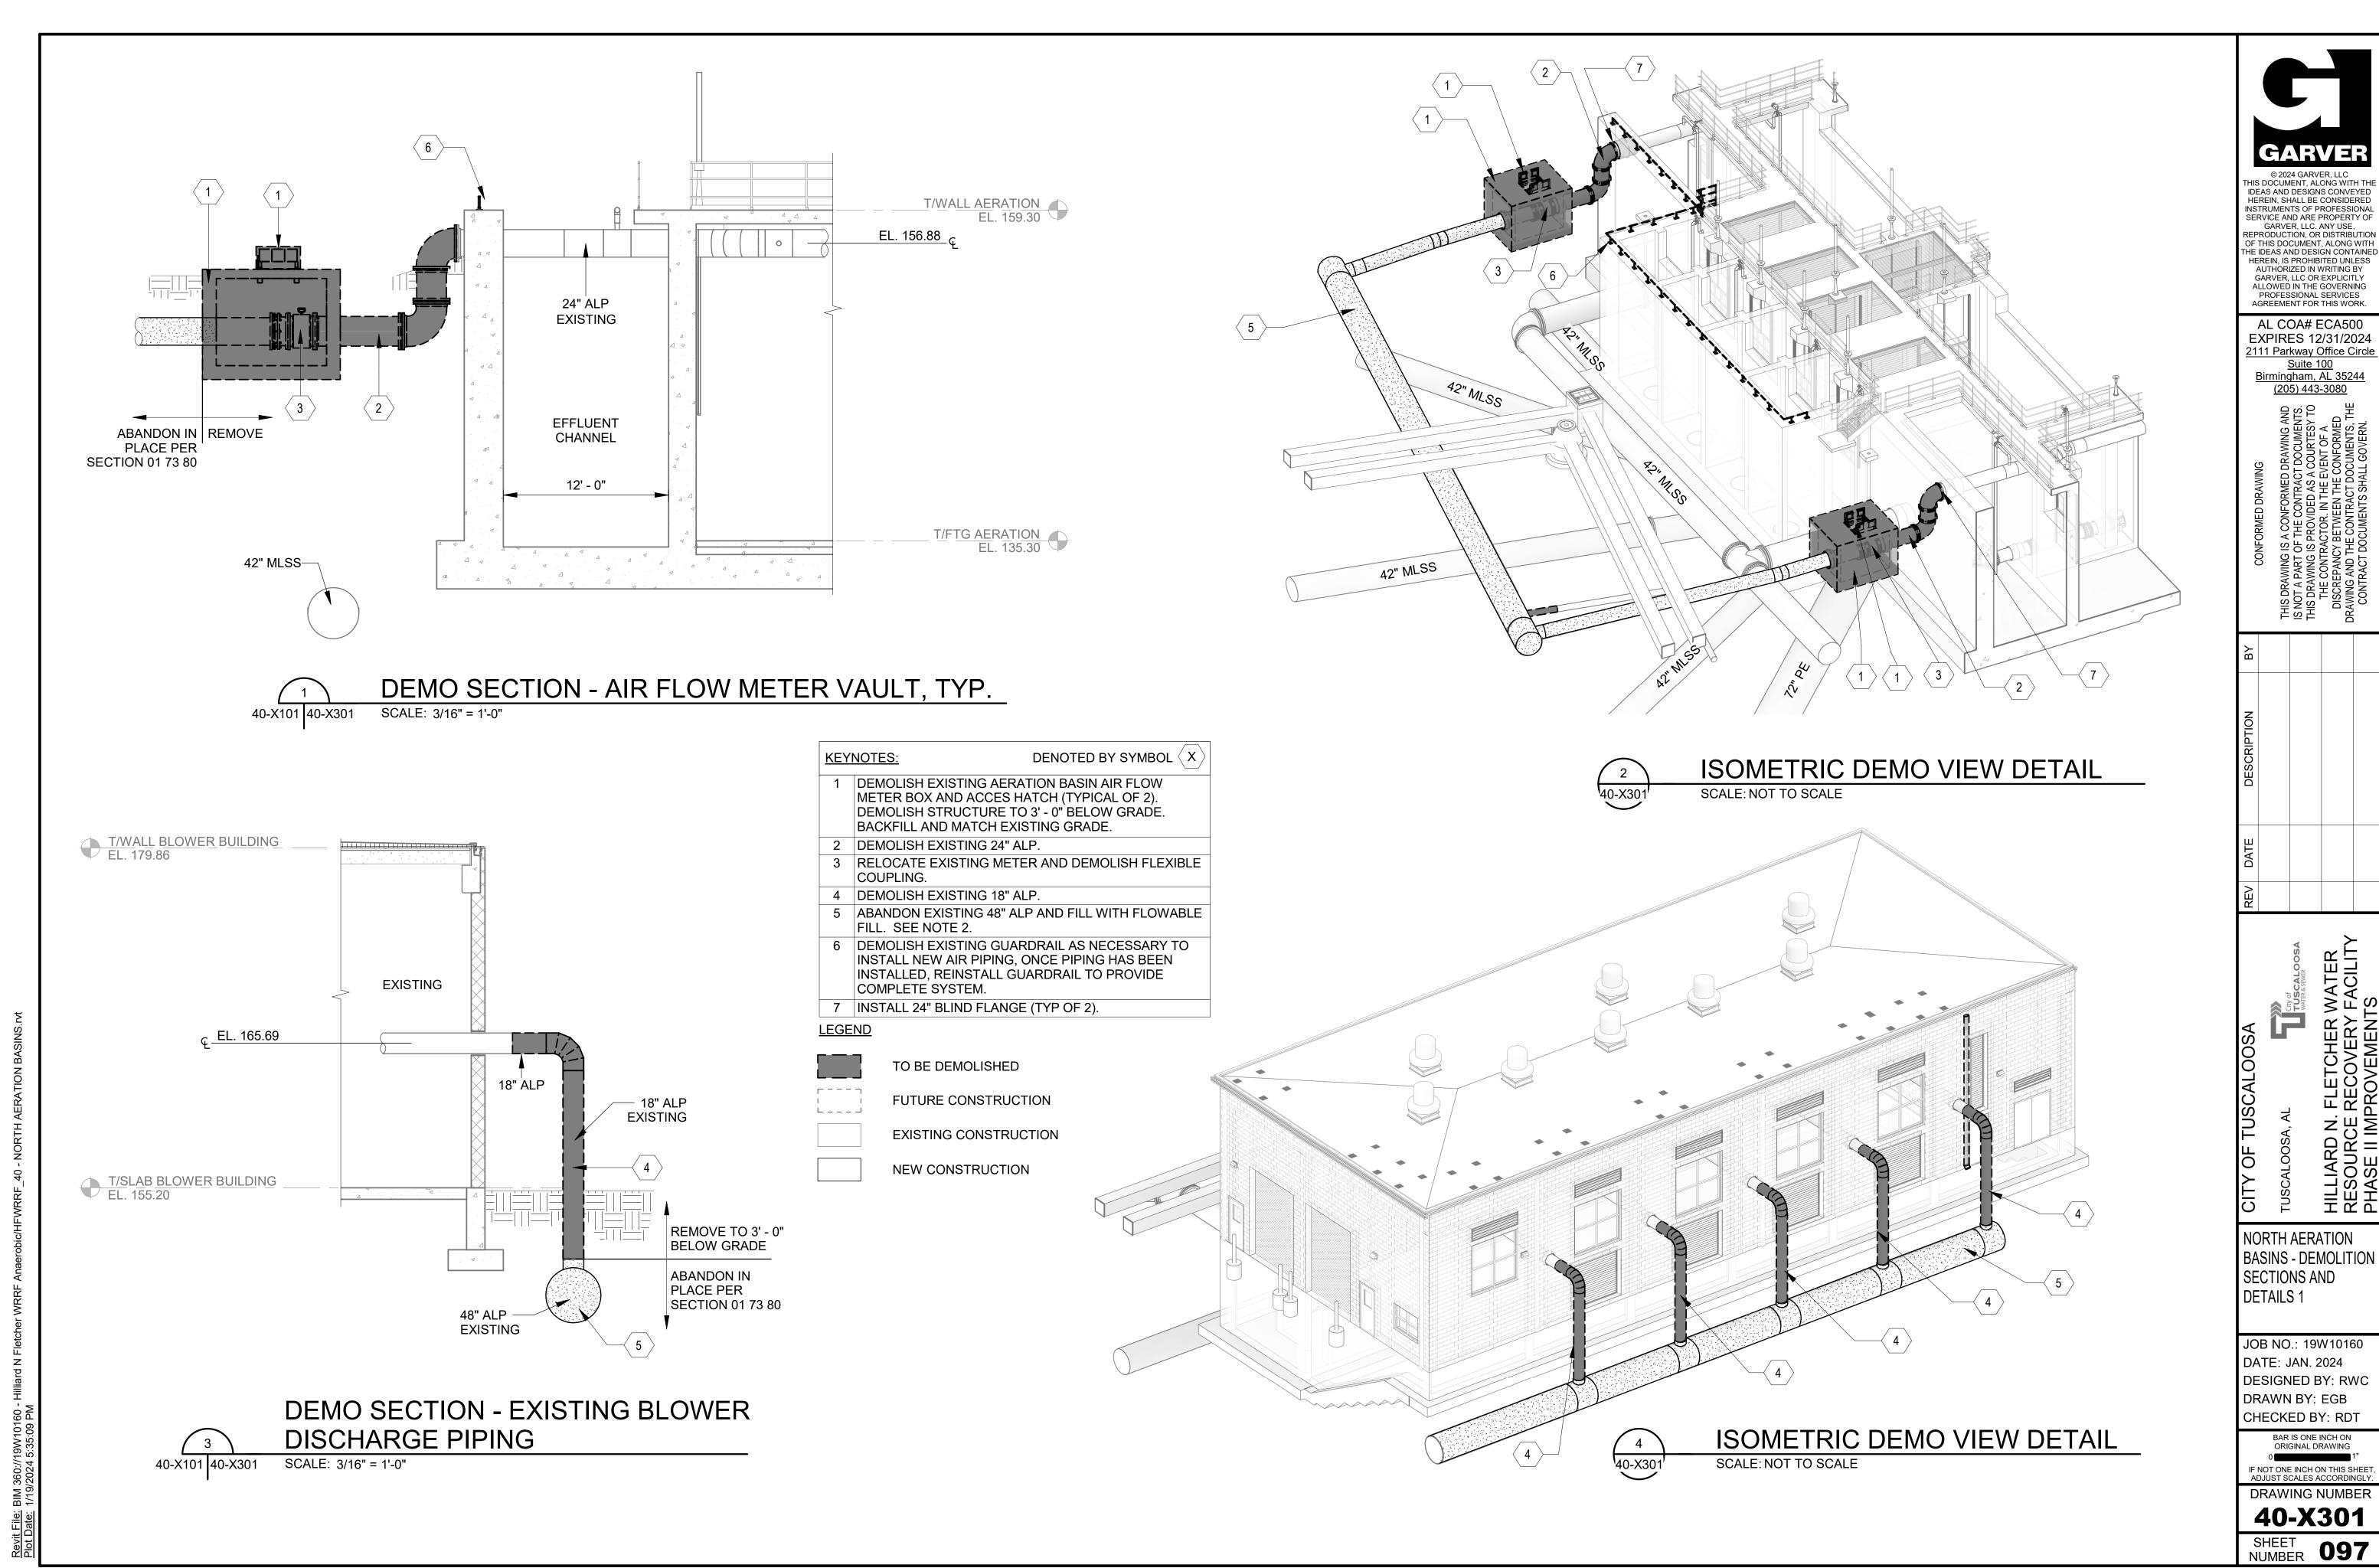
NORTH AERATION **BASINS - DEMOLITION** PLAN 2


JOB NO.: 19W10160 DATE: JAN. 2024 **DESIGNED BY: RWC** DRAWN BY: JAS CHECKED BY: RDT

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40-X102 SHEET 096





40-X102 40-X302 SCALE: NOT TO SCALE 6"ø FOLLOWER FLANGE STD 150# DRILLING - 1/4"ø COUPLING T.O.W. & DROPLEG CONN. EL, 159.30 2'-0" 2'-7" 1'-2" 1'-2" 1'-0" 1'-6" 10" 1'-8" MIDDLE 1'-4" 2'-11" **EXISTING STAINLESS STEEL** 2'-1" 1'-1" 1'-11" 3'-6" WEST DROP LEGS TO REMAIN — 6 5/8"ø x SCH 10 316L STN. STL. DROPLEG 69-1 43'-6" OF 6"Ø SCH 40 PVC PIPE 20'-11 1/8" 22'-6 7/8" 2'-1" 2'-6" 7 SPACES @ 2'-9" = 19'-3" 6 SPACES @ 2'-6"= 15'-0" EXISTING DIFFUSERS, - 6"ø SCH 40 PVC DROPLEG SEE NOTE #2 6"ø SCH 40 PVC COUPLING -DIFFUSER AIR PIPING AND ALL OTHER COMPONENTS TO BE 73-1 REPLACED OF THE FINE BUBBLE DIFFUSER GRID TO BE ⊈MANIFOLD EL. 135.80 H.P. FLOOR EL. 135.30 REMOVED (TYP) L.P. FLOOR EL. 134.83 -SIMPLE SUPPORT SEE DETAIL 96 **GENERAL NOTES:** 5'-6" 5'-7" 6'-0" CLAMP COUPLING DRAWING BACKGROUND IS REPRODUCTION OF EXISTING AERATION SYSTEM SEE DETAIL (32) PURGE SUMP ASSEMBLY SHOP DRAWINGS AND IS PROVIDED FOR INFORMATION ONLY. FIELD CONDITIONS SEE DETAIL 80 HAVE NOT BEEN VERIFIED AND MAY DIFFER FROM THAT SHOWN HEREIN. GRID TYPE 3 MANIFOLD

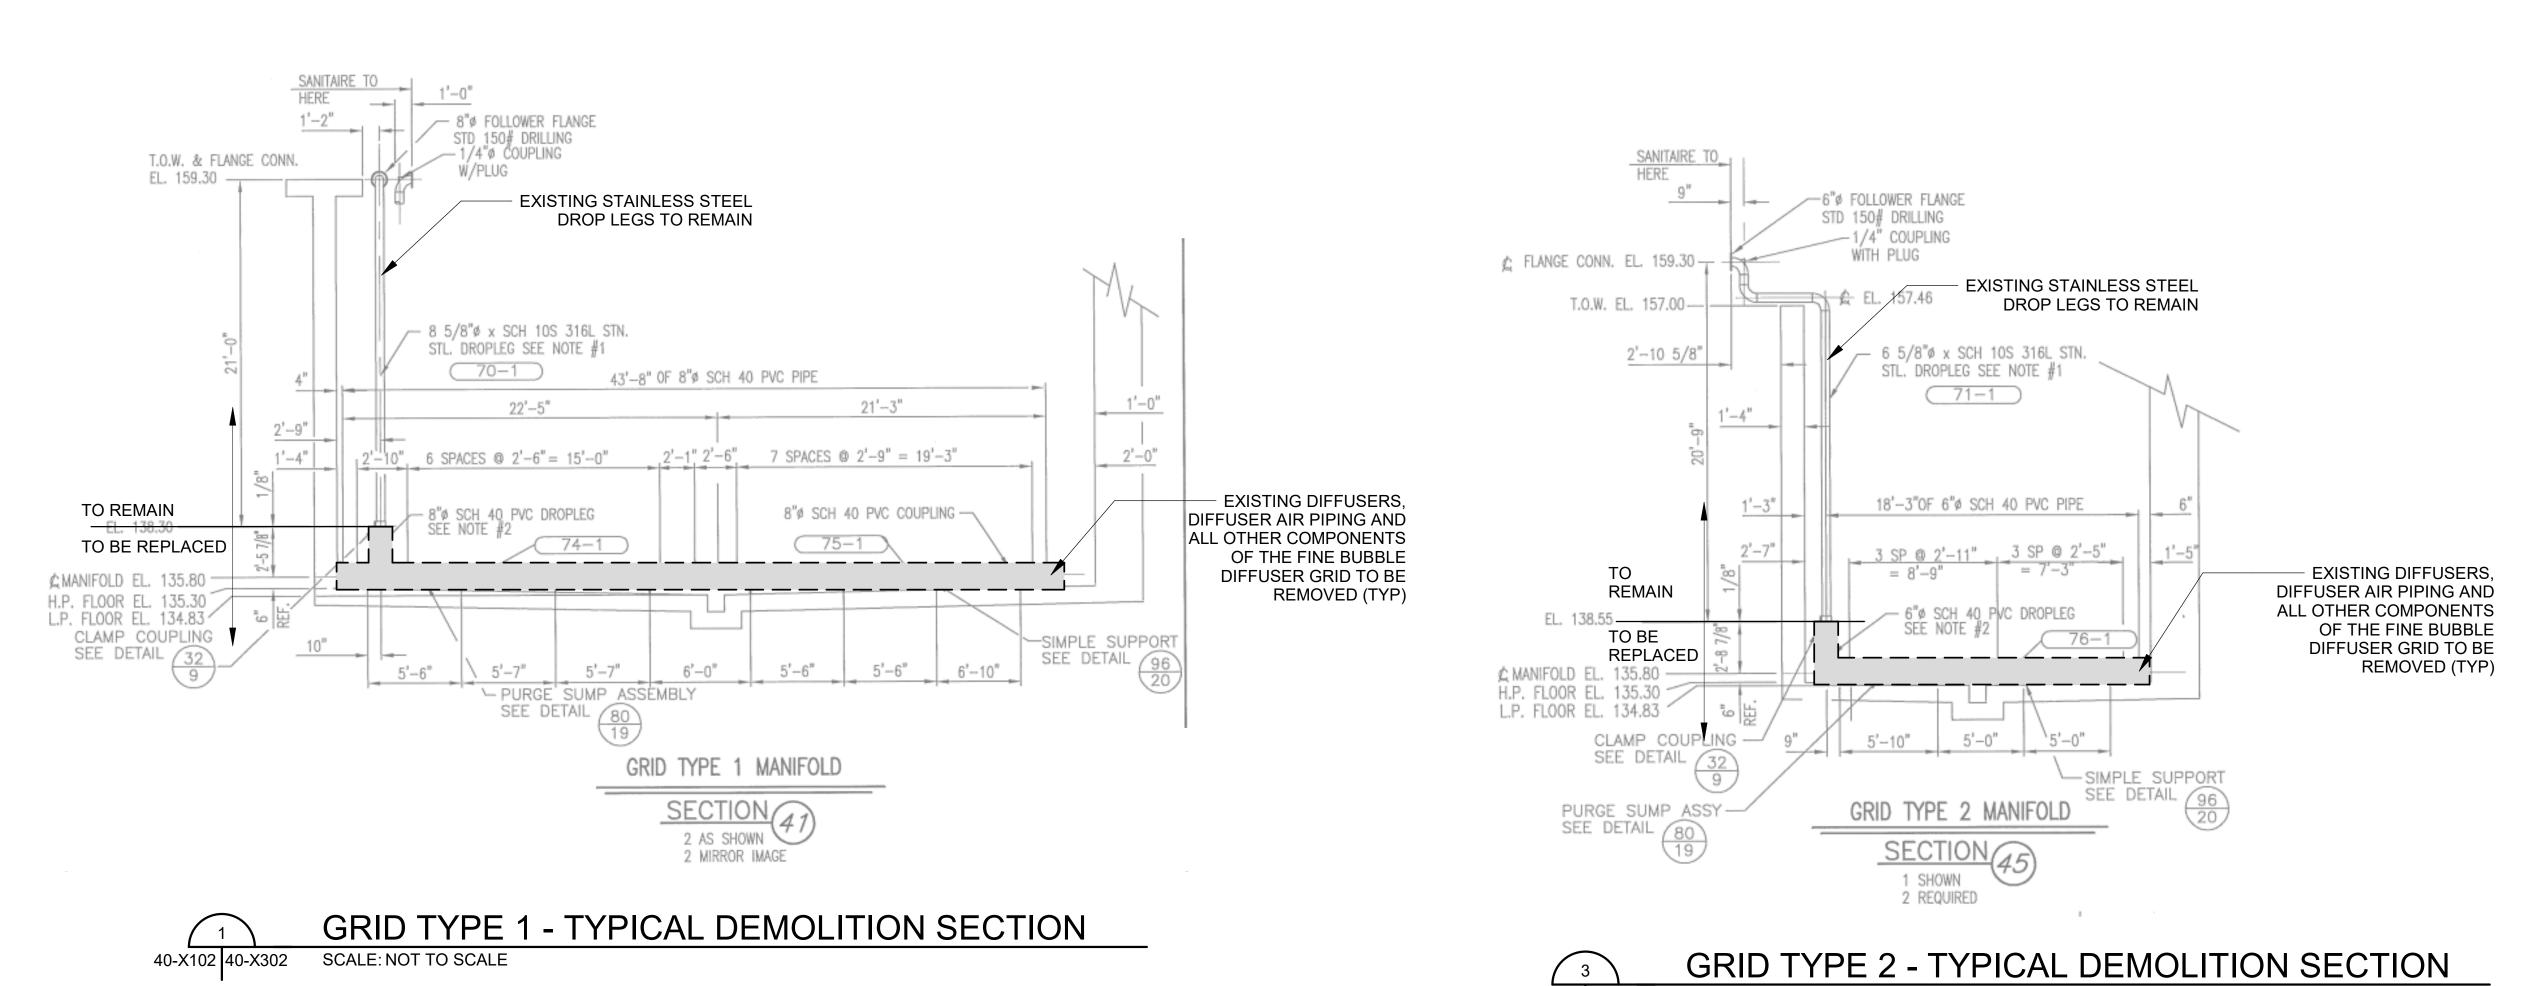GRID TYPE 3 - TYPICAL DEMOLITION SECTION
40-X102 40-X302 SCALE: NOT TO SCALE

3 AS SHOWN

3 MIRROR IMAGE

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NORTH AERATION BASINS - DEMOLITION SECTIONS AND DETAILS 2

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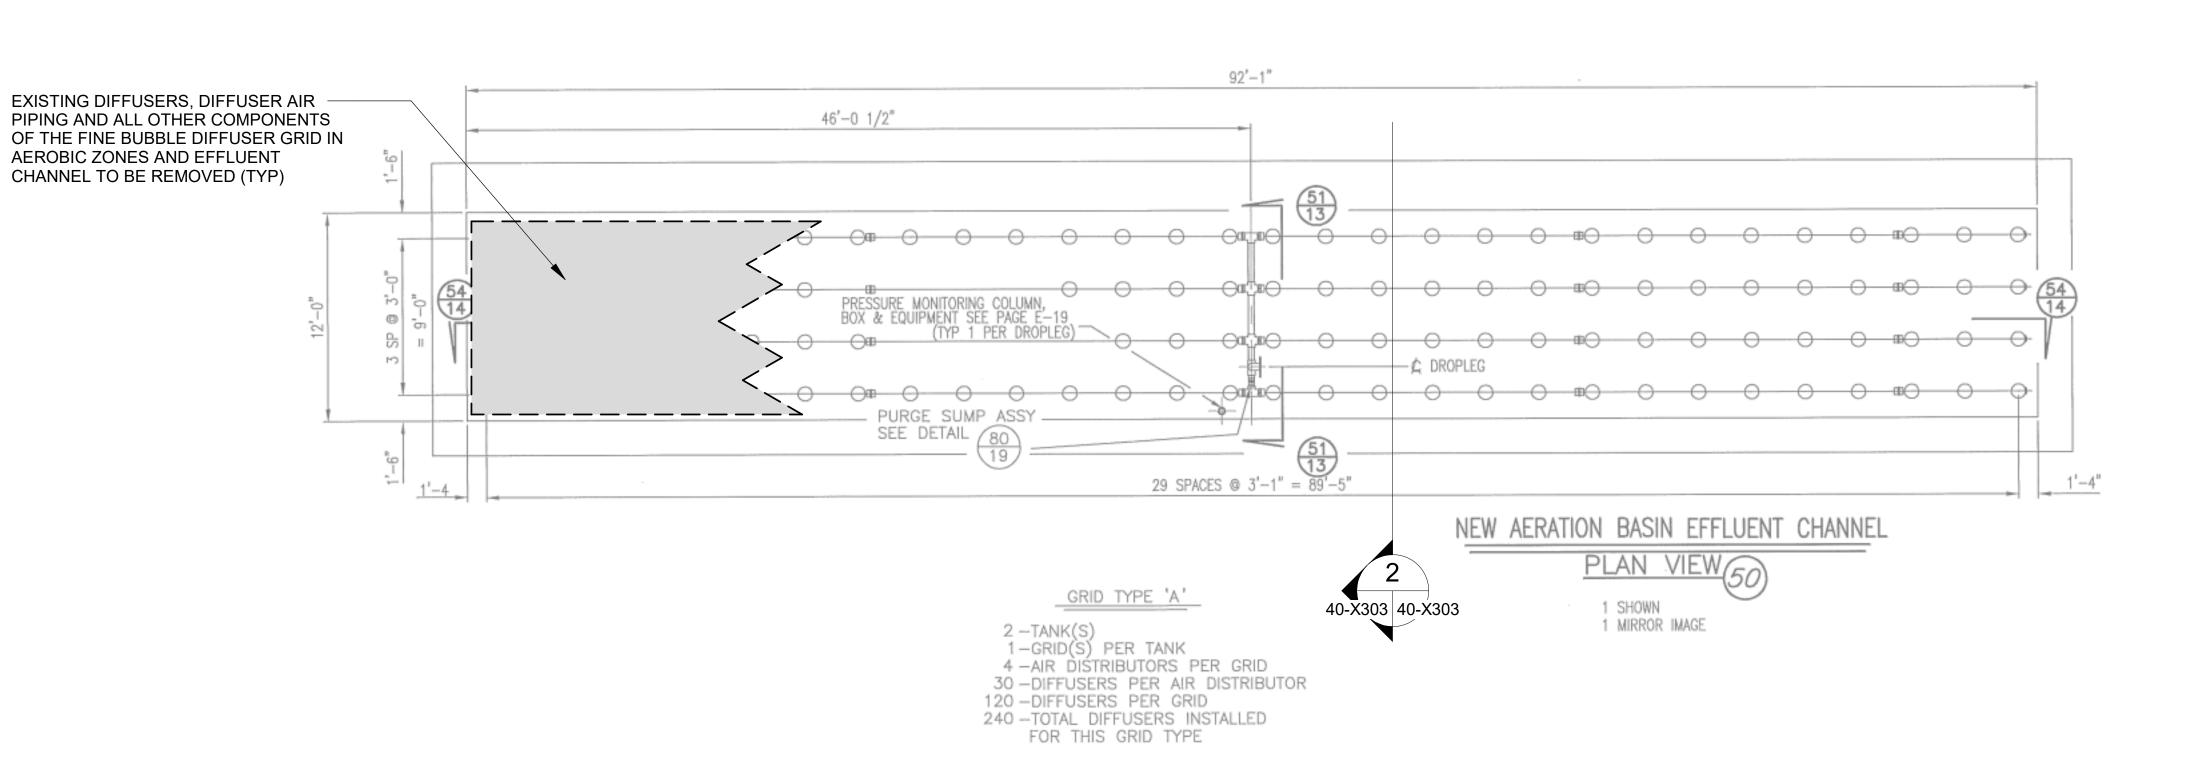
SHEET 098

CONTRACTOR BASE BID SHALL BE BASED ON DEMOLITION INDICATED HEREIN AND

SPECIFIED IN SPECIFICATION SECTION 44 42 13. FOR DEDUCTIVE ALTERNATE A,


SCOPE OF DEMOLITION SHALL BE LIMITED TO EXISTING CERAMIC DIFFUSER

HEADS ONLY AS DESCRIBED IN SPECIFICATION SECTION 01 11 20.



NORTH AERATION BASINS EFFLUENT CHANNEL - PARTIAL DEMOLITION PLAN VIEW

SCALE: NOT TO SCALE

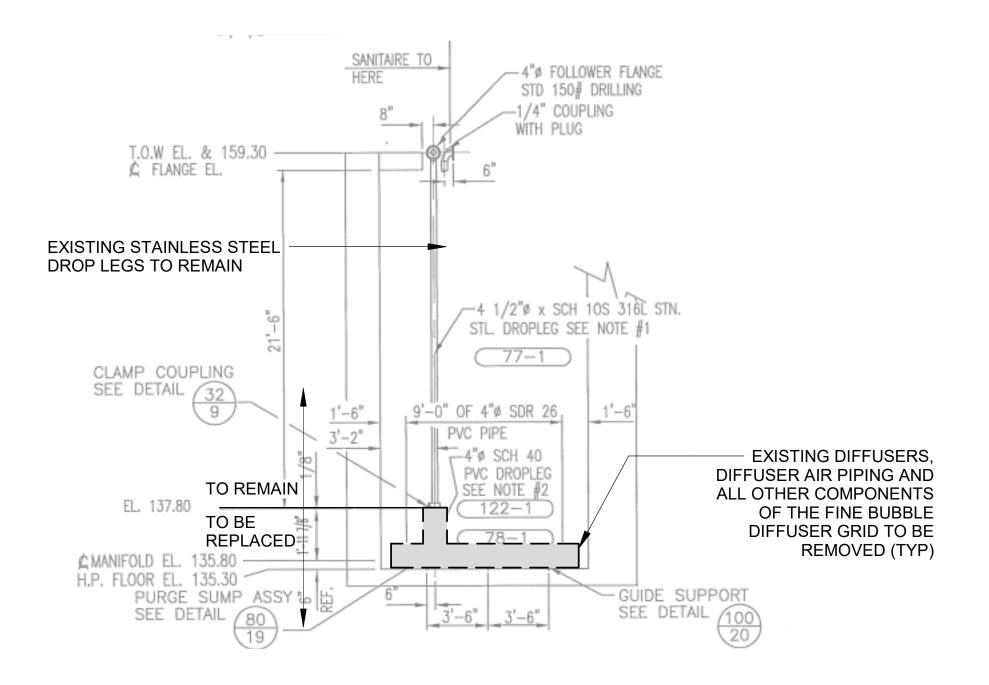

EFFLUENT CHANNEL - TYPICAL DEMOLITION SECTION
40-X303 | 40-X303 | SCALE: NOT TO SCALE



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NORTH AERATION BASINS - DEMOLITION SECTIONS AND DETAILS 3

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DRAWING NUMBER 40-X303

SHEET NUMBER 099

40-X303

GENERAL NOTES:

THAT SHOWN HEREIN.

THE PLAN VIEW SHOWN.

SPECIFICATION SECTION 01 11 20.

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SYSTEM SHOP DRAWINGS AND IS PROVIDED FOR INFORMATION ONLY.

FIELD CONDITIONS HAVE NOT BEEN VERIFIED AND MAY DIFFER FROM

THIS PARTIAL DEMOLITION PLAN VIEW IS REPRESENTATIVE OF ONE

DEMOLITION INDICATED SHALL BE REQUIRED AT REMAINING CHANNEL.

THE REMAINING EFFLUENT CHANNEL LAYOUT IS A MIRROR IMAGE OF


CONTRACTOR BASE BID SHALL BE BASED ON DEMOLITION INDICATED


DEDUCTIVE ALTERNATE A, SCOPE OF DEMOLITION SHALL BE LIMITED

HEREIN AND SPECIFIED IN SPECIFICATION SECTION 44 42 13. FOR

TO EXISTING CERAMIC DIFFUSER HEADS ONLY AS DESCRIBED IN

NORTH AERATION BASIN EFFLUENT CHANNEL. ALL NECESSARY

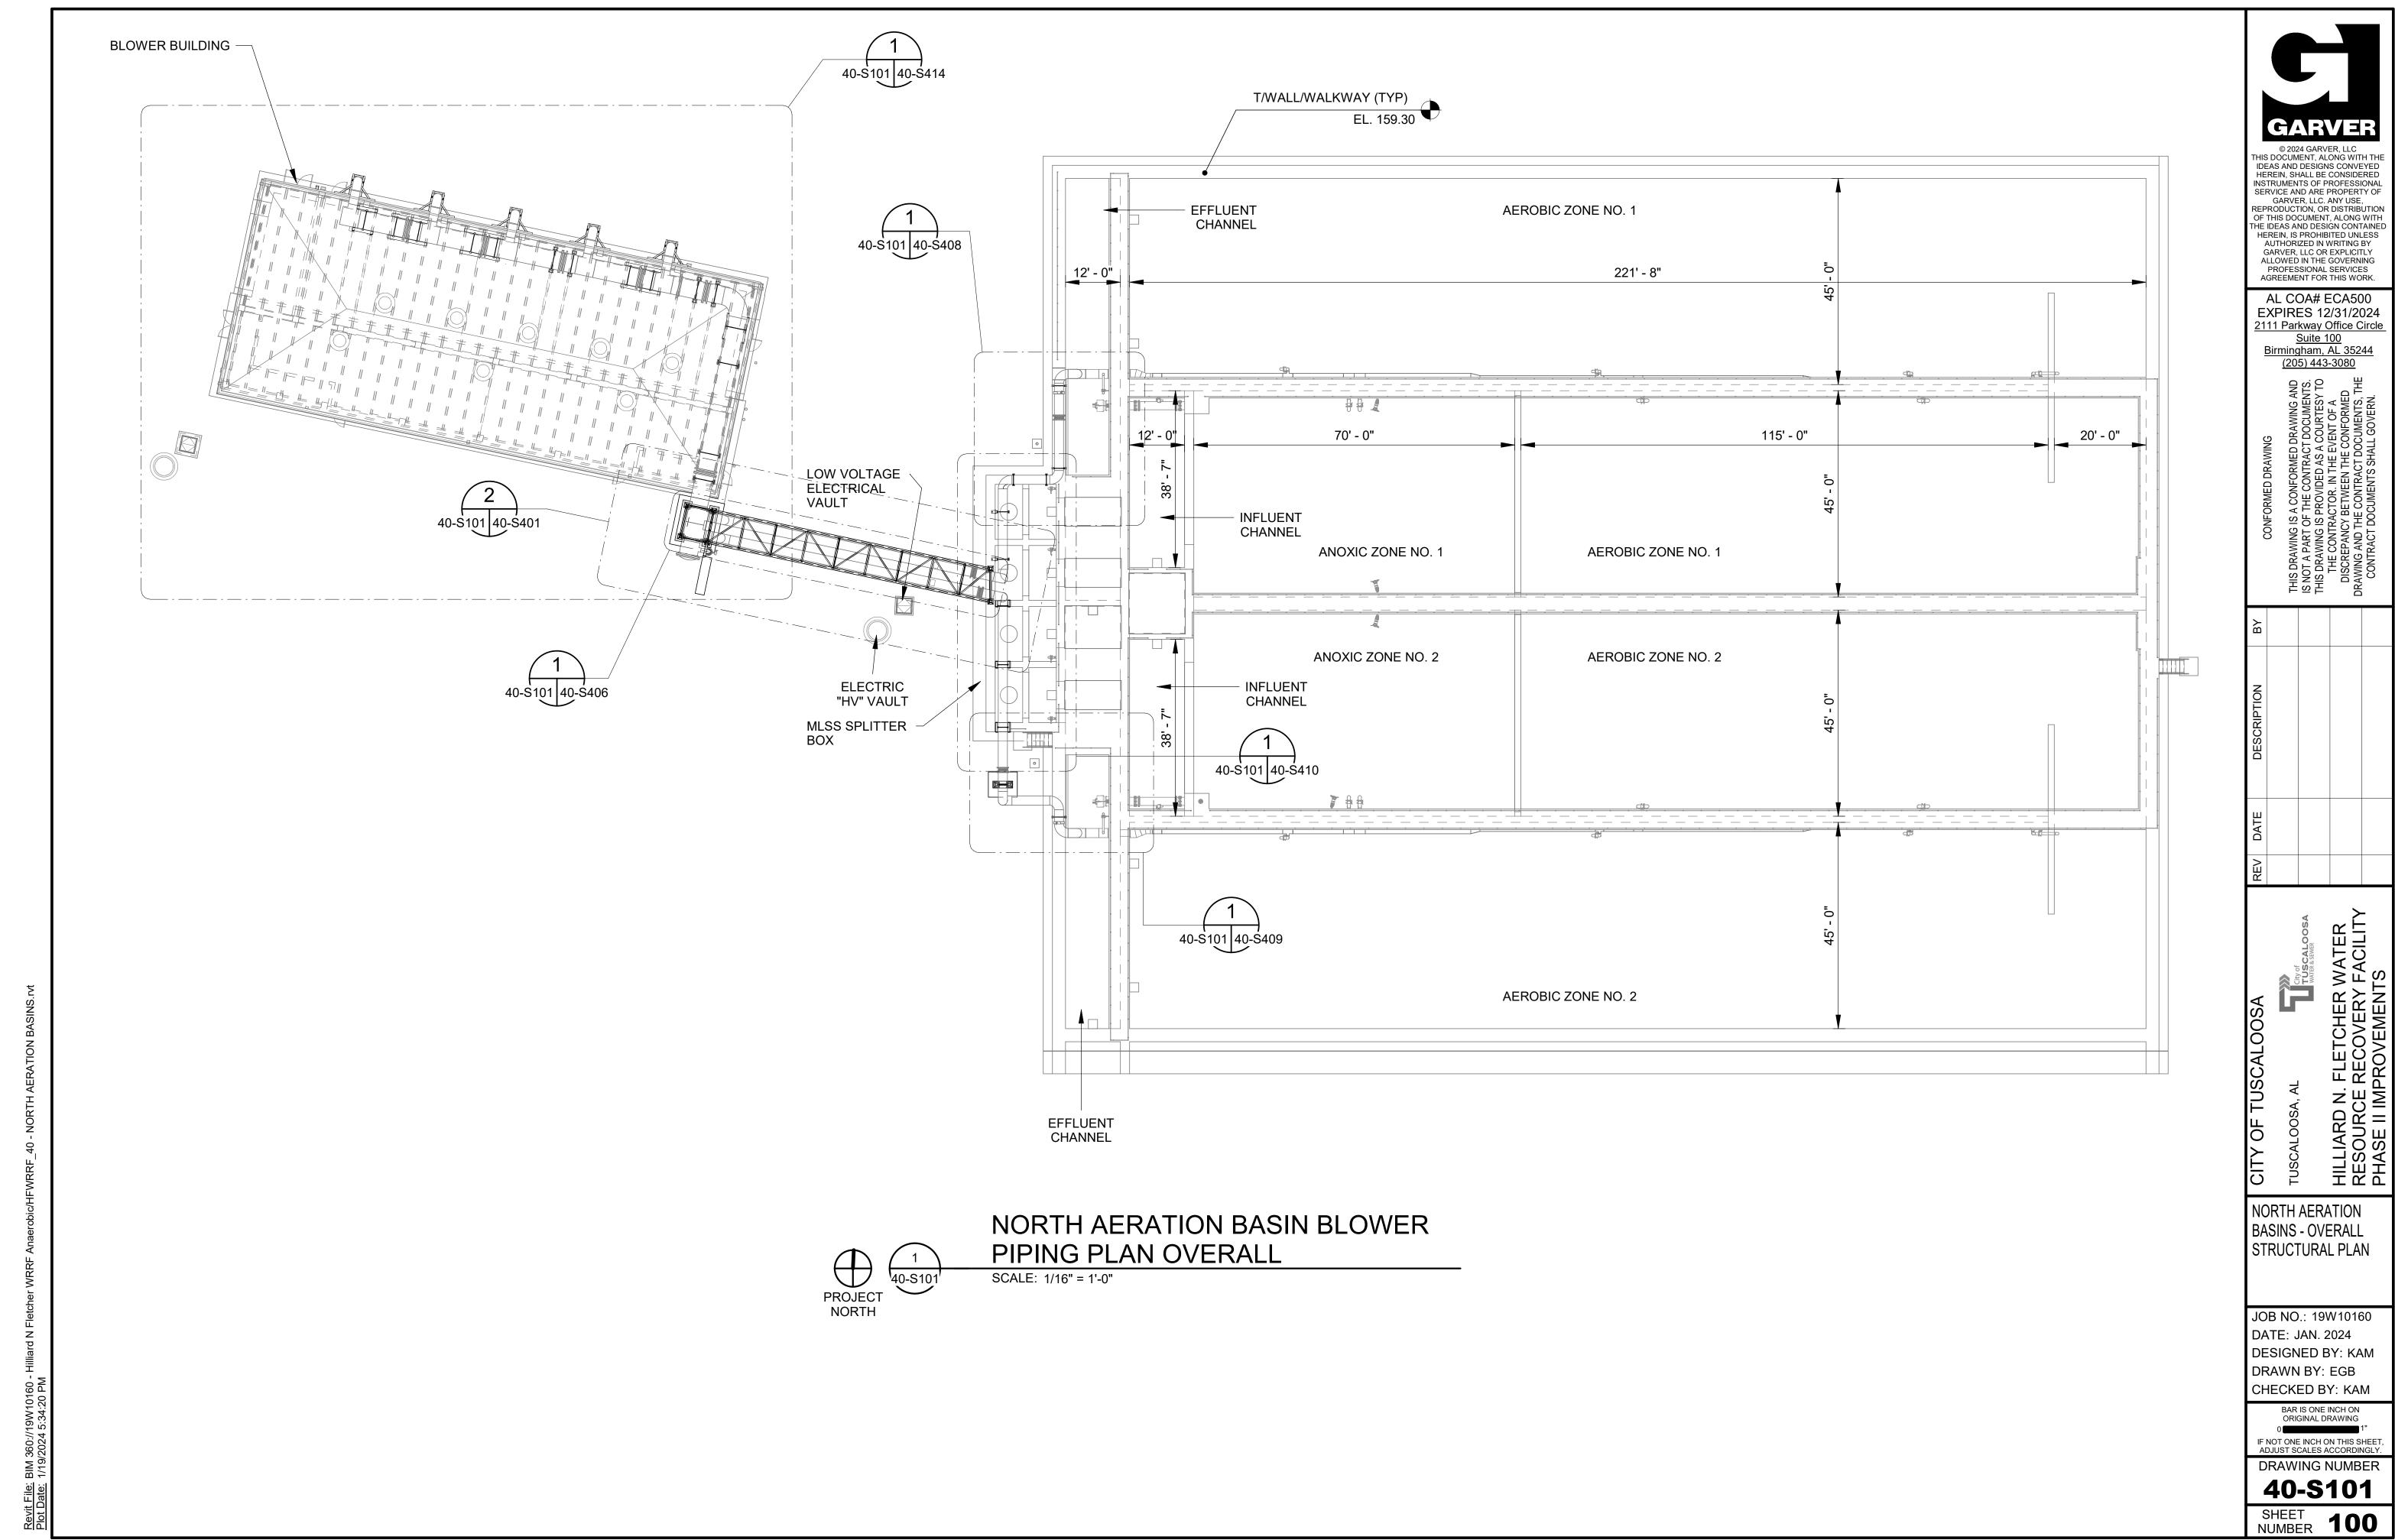

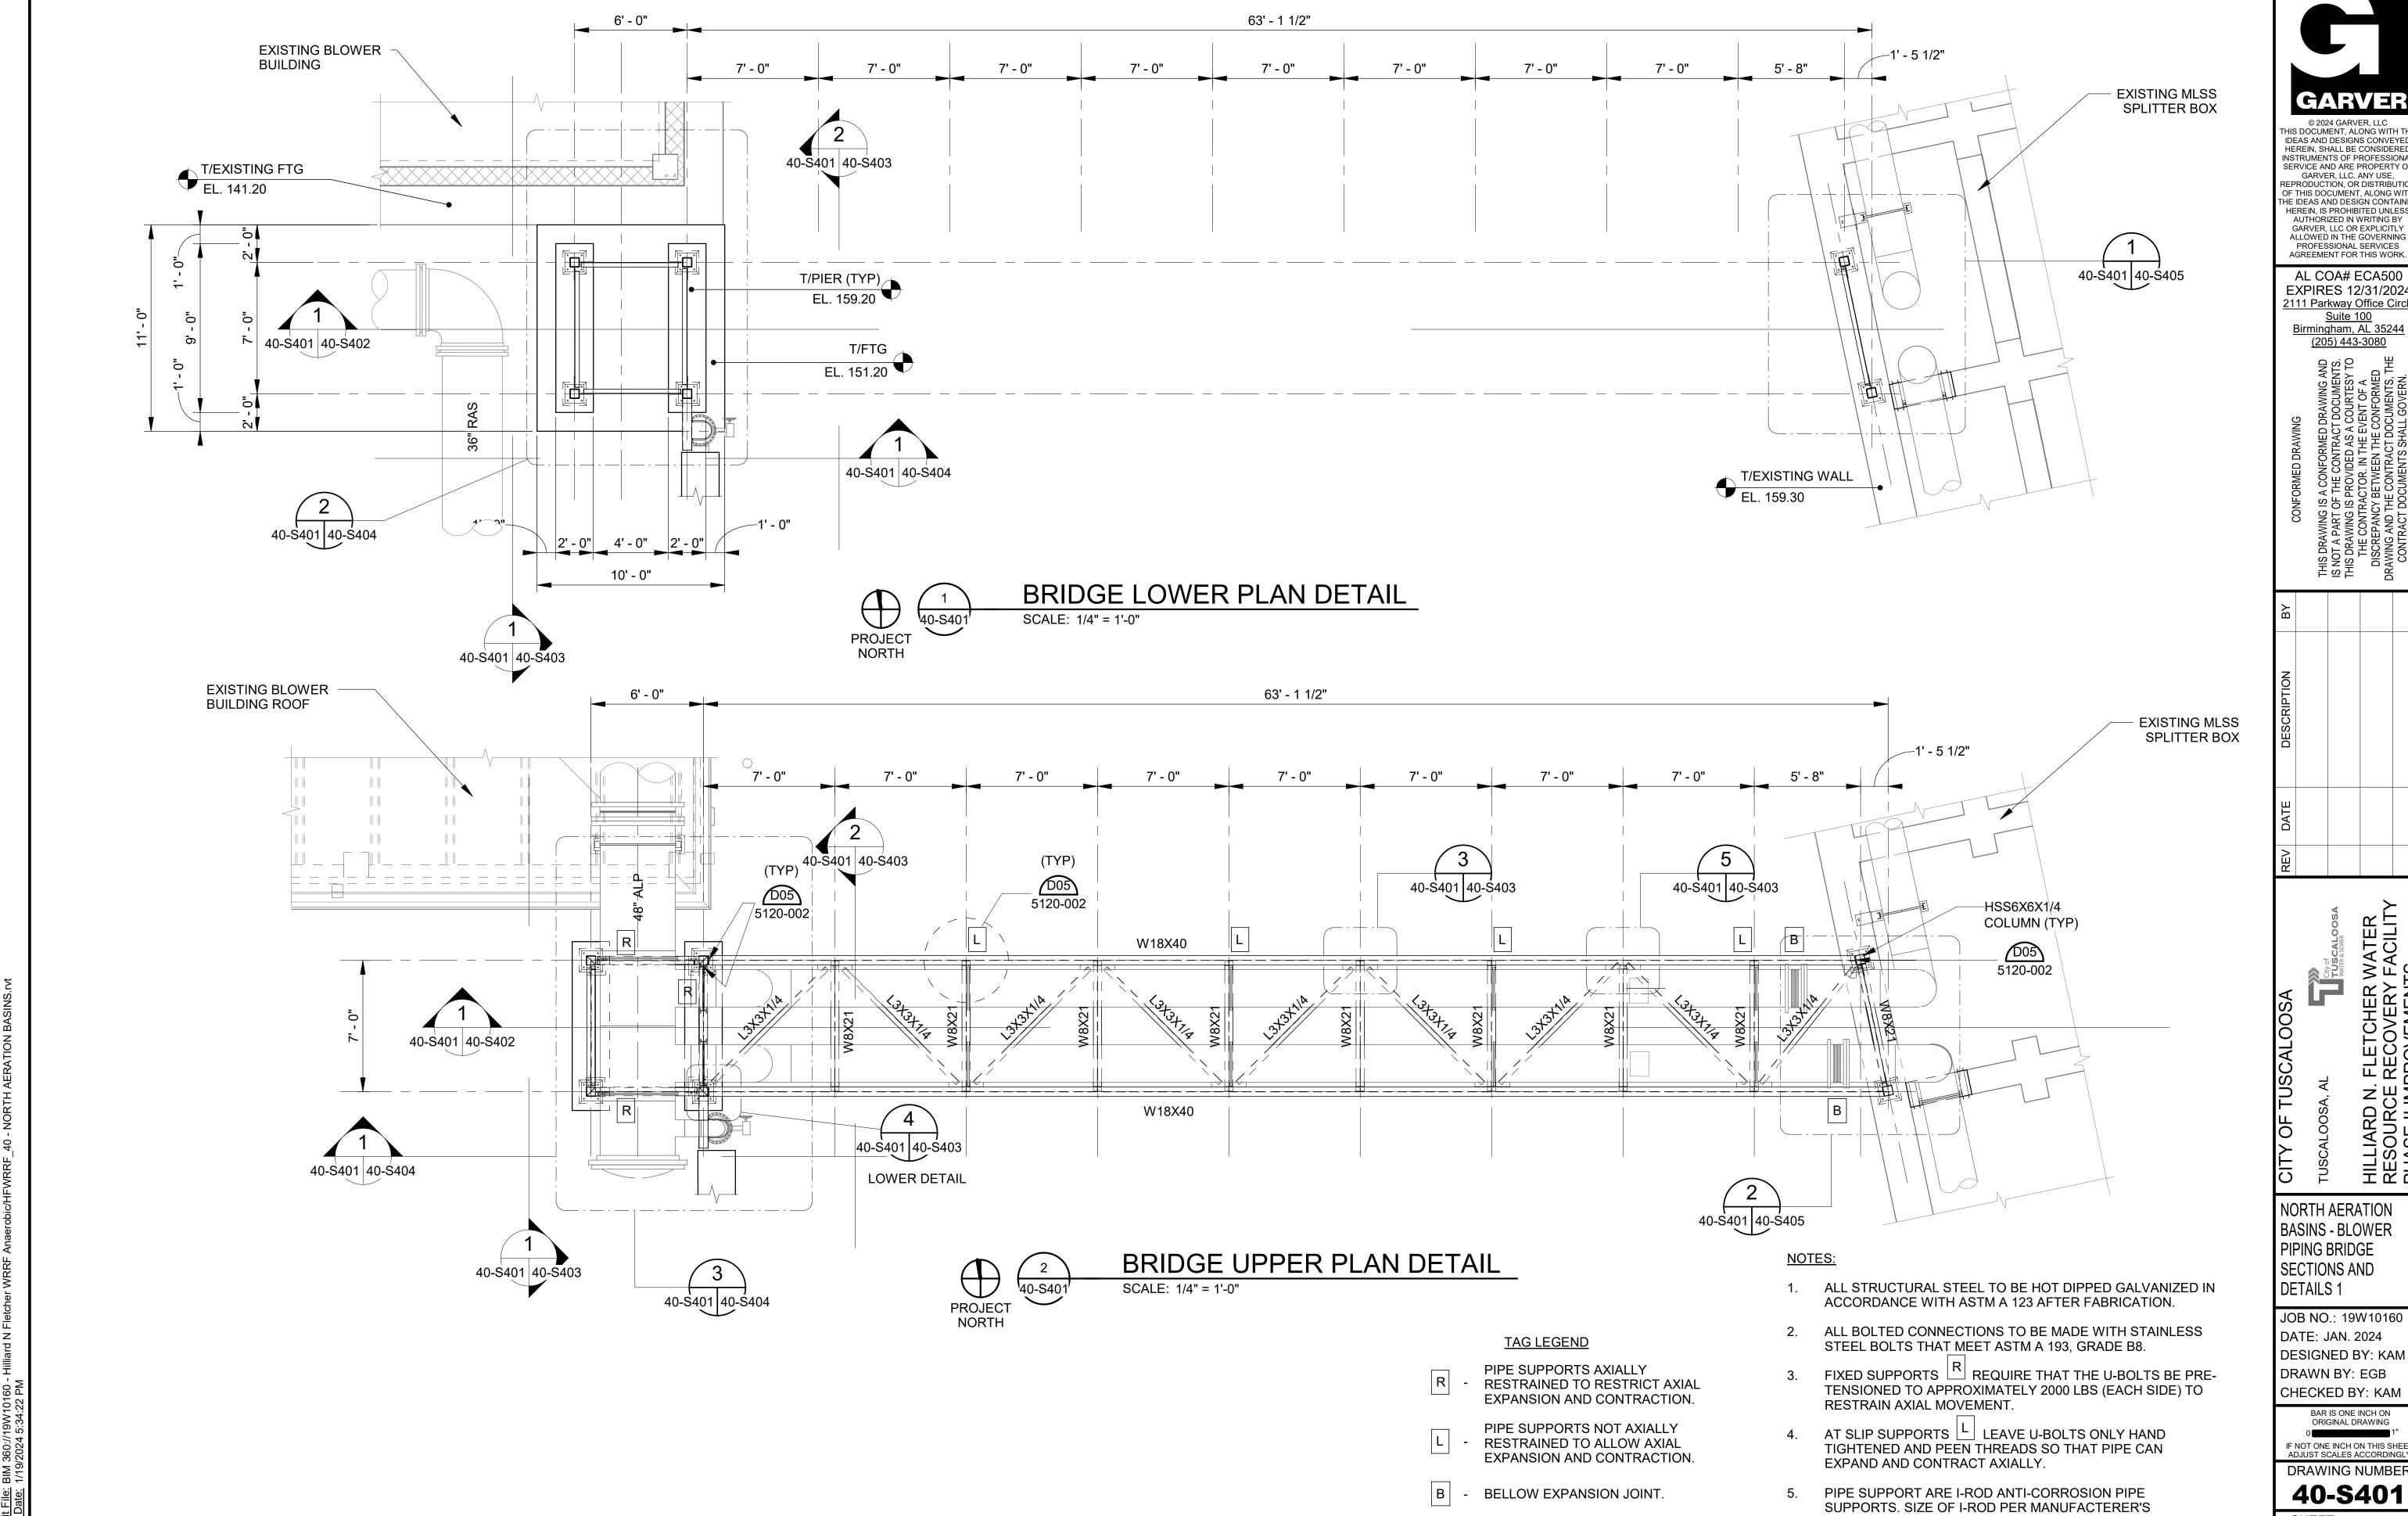

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NORTH AERATION BASINS - BLOWER PIPING BRIDGE SECTIONS AND

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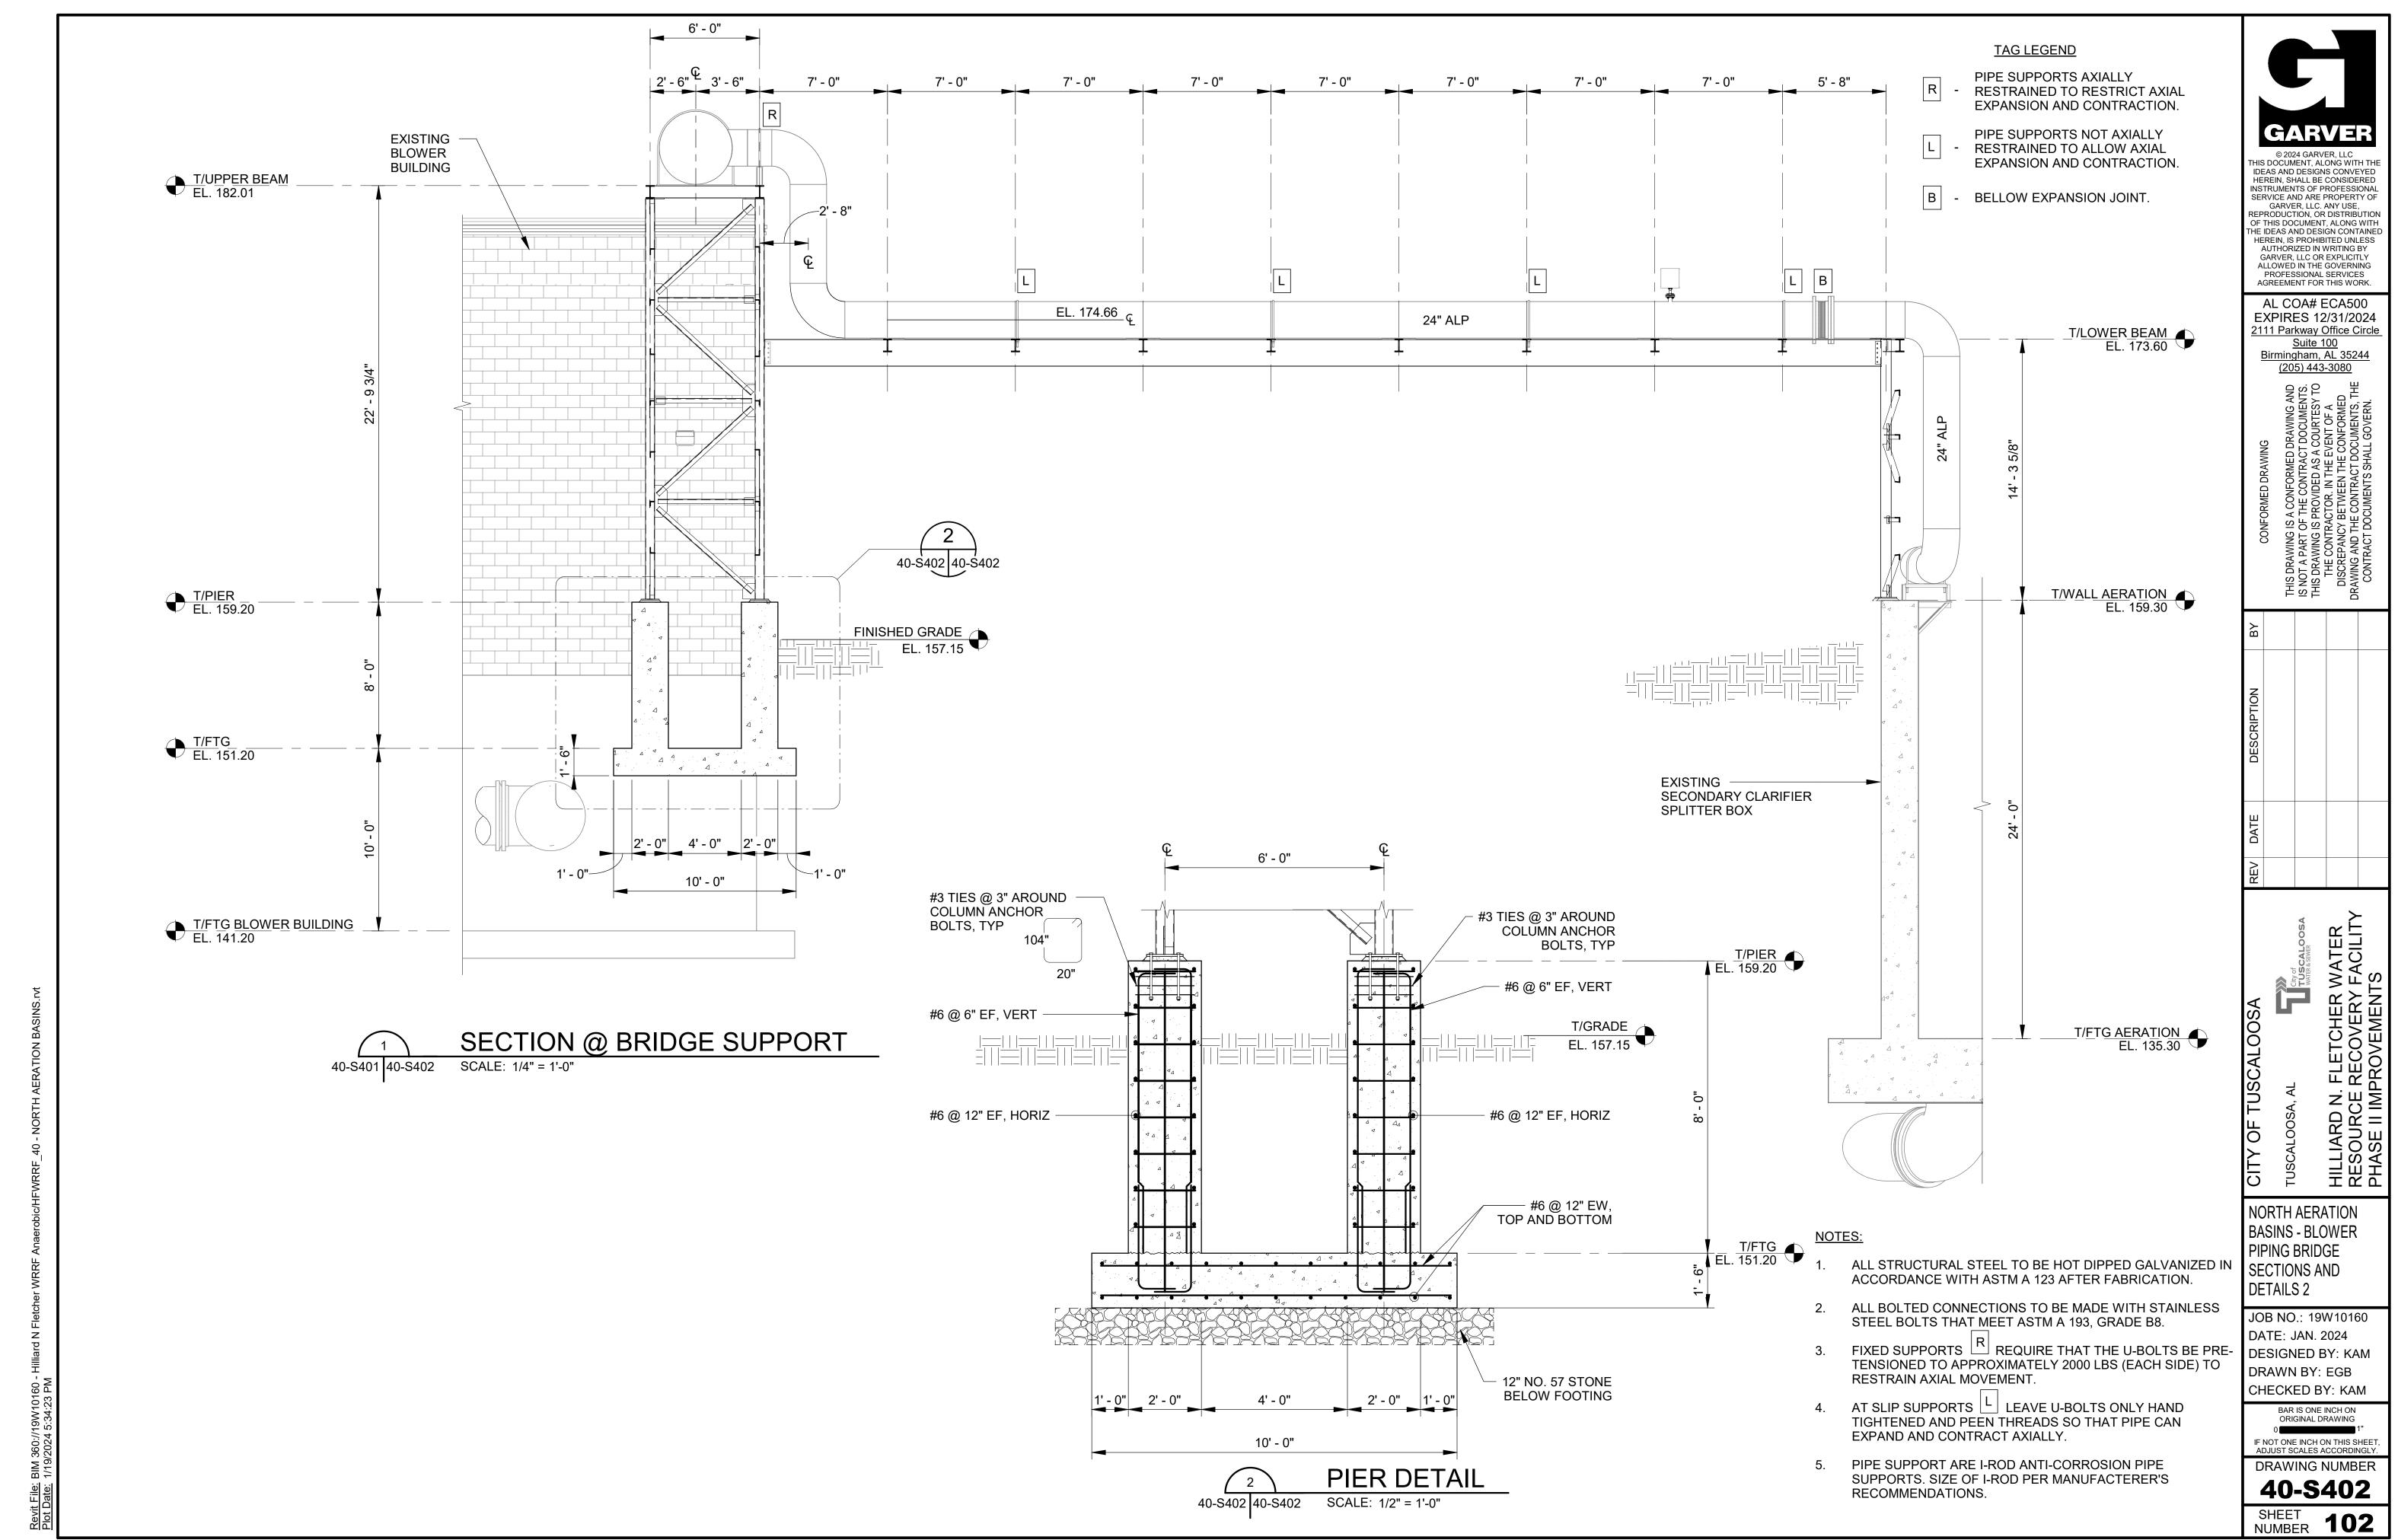
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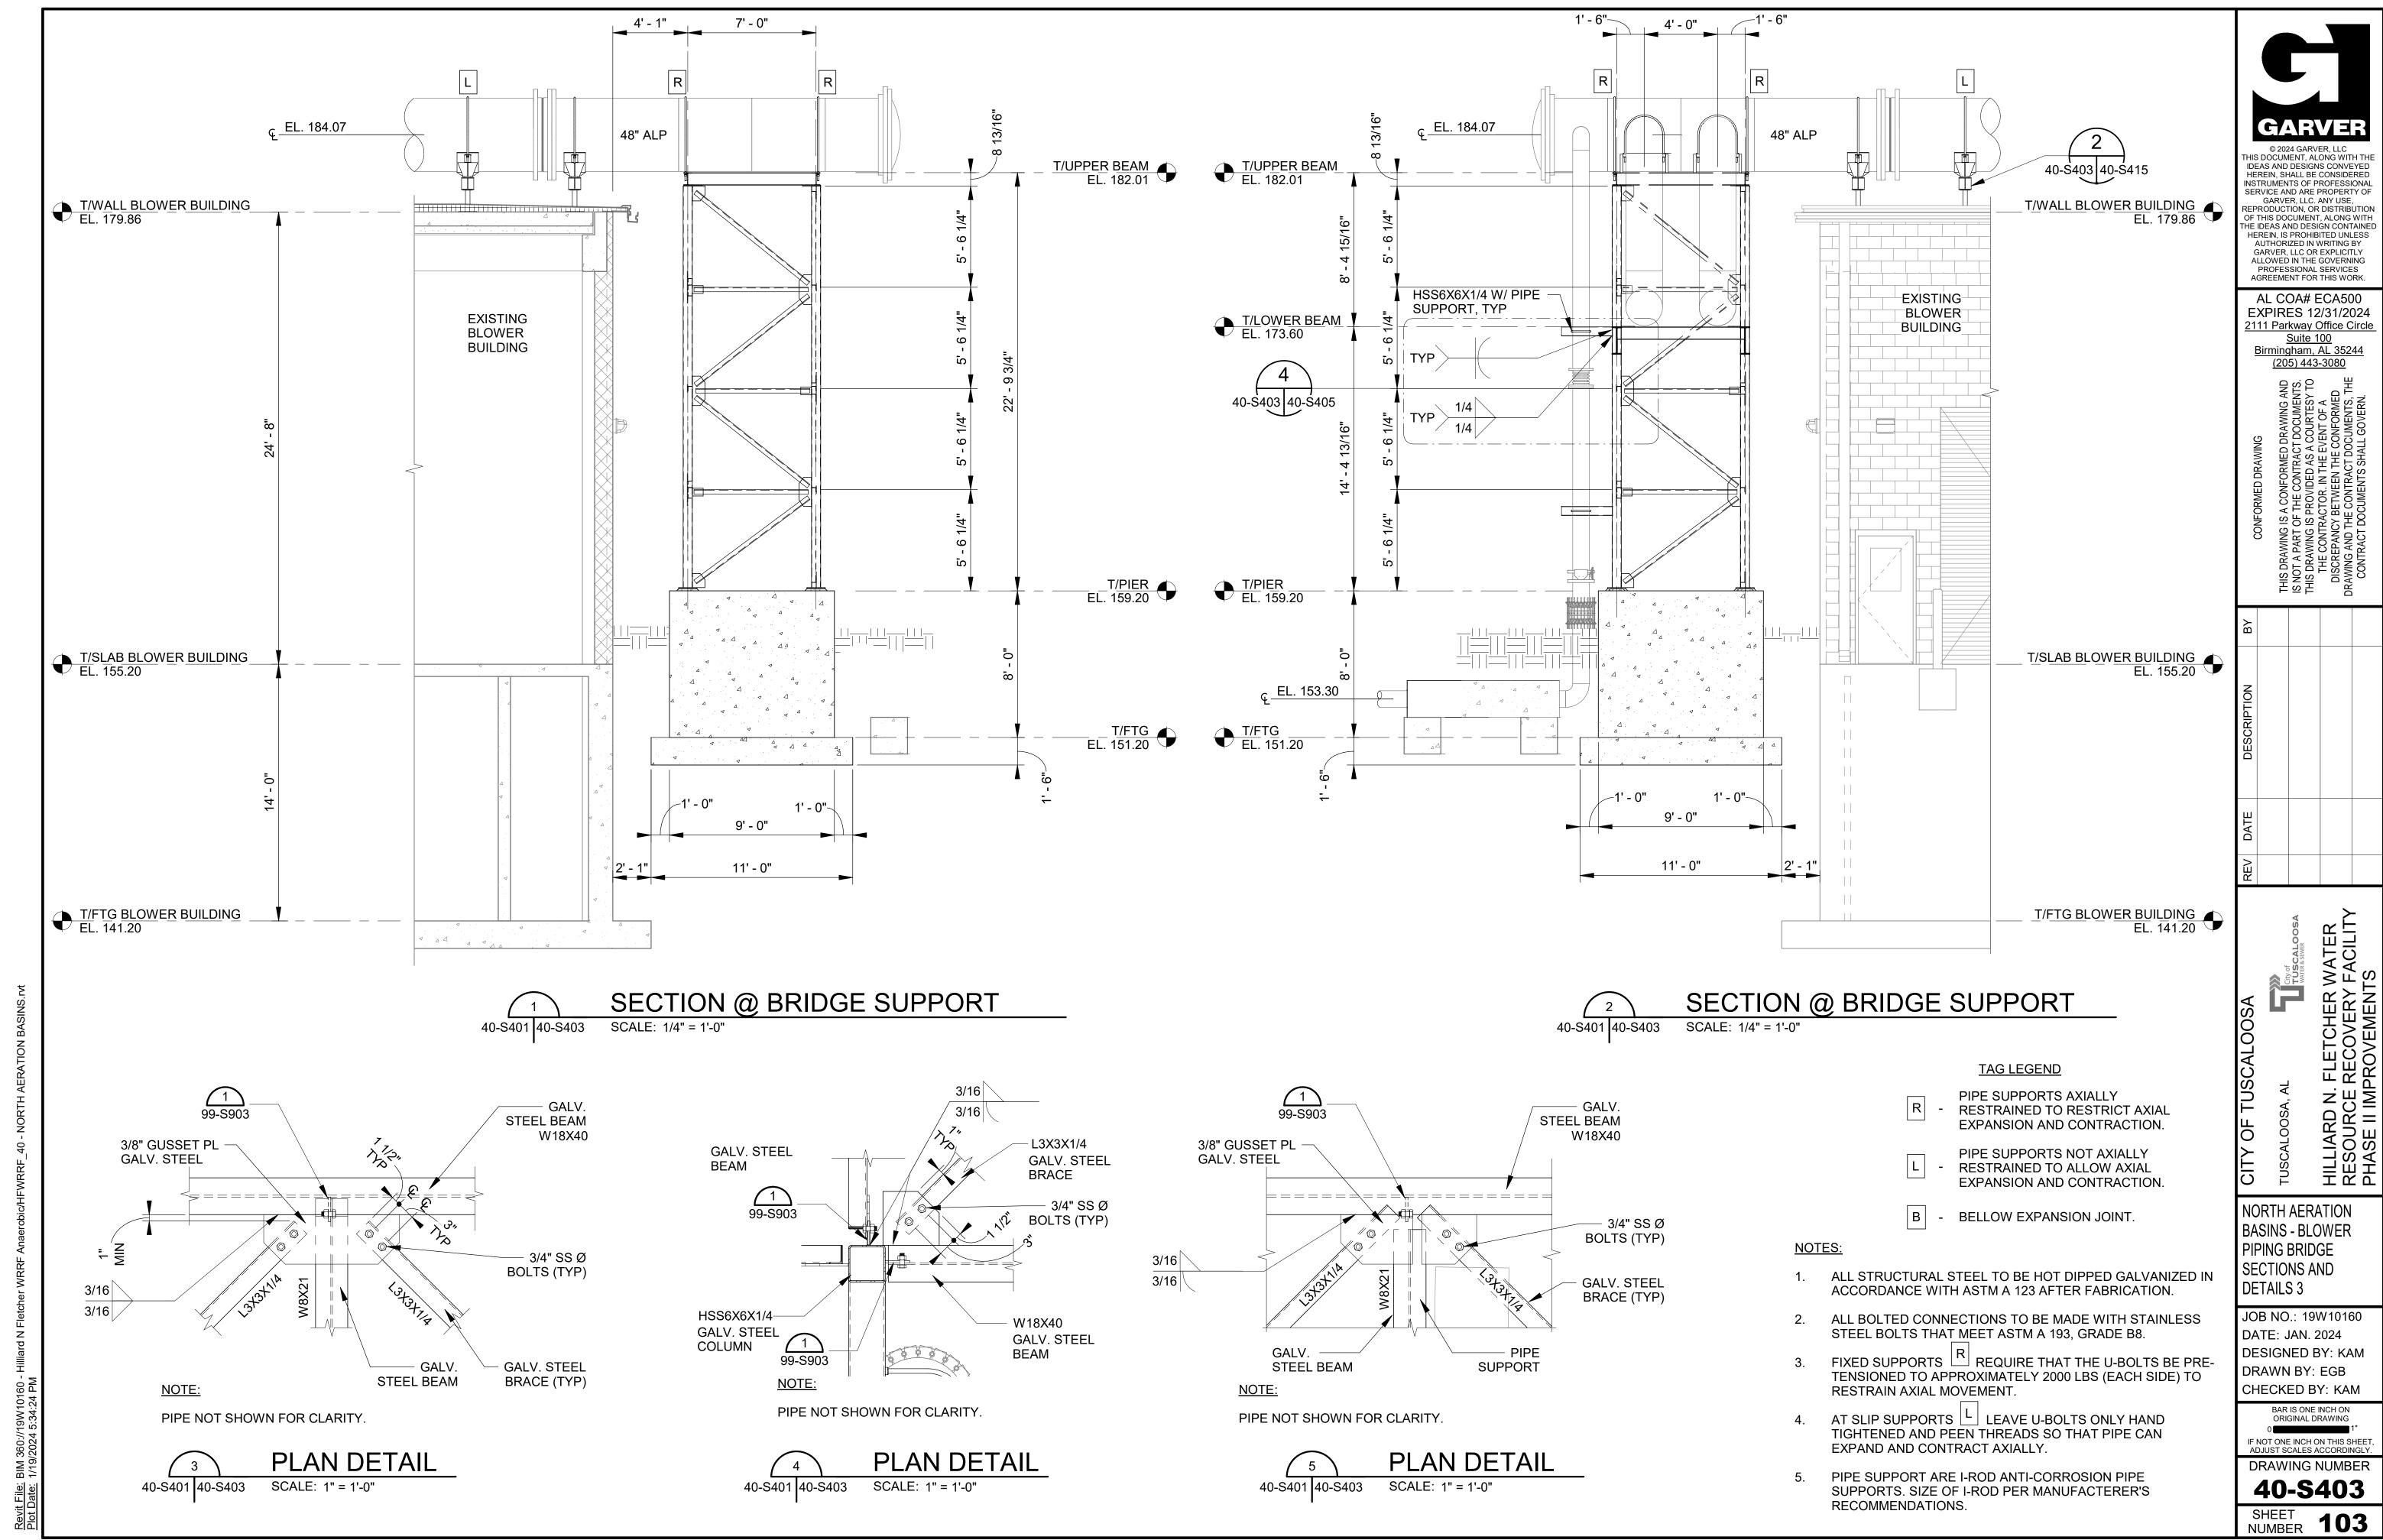
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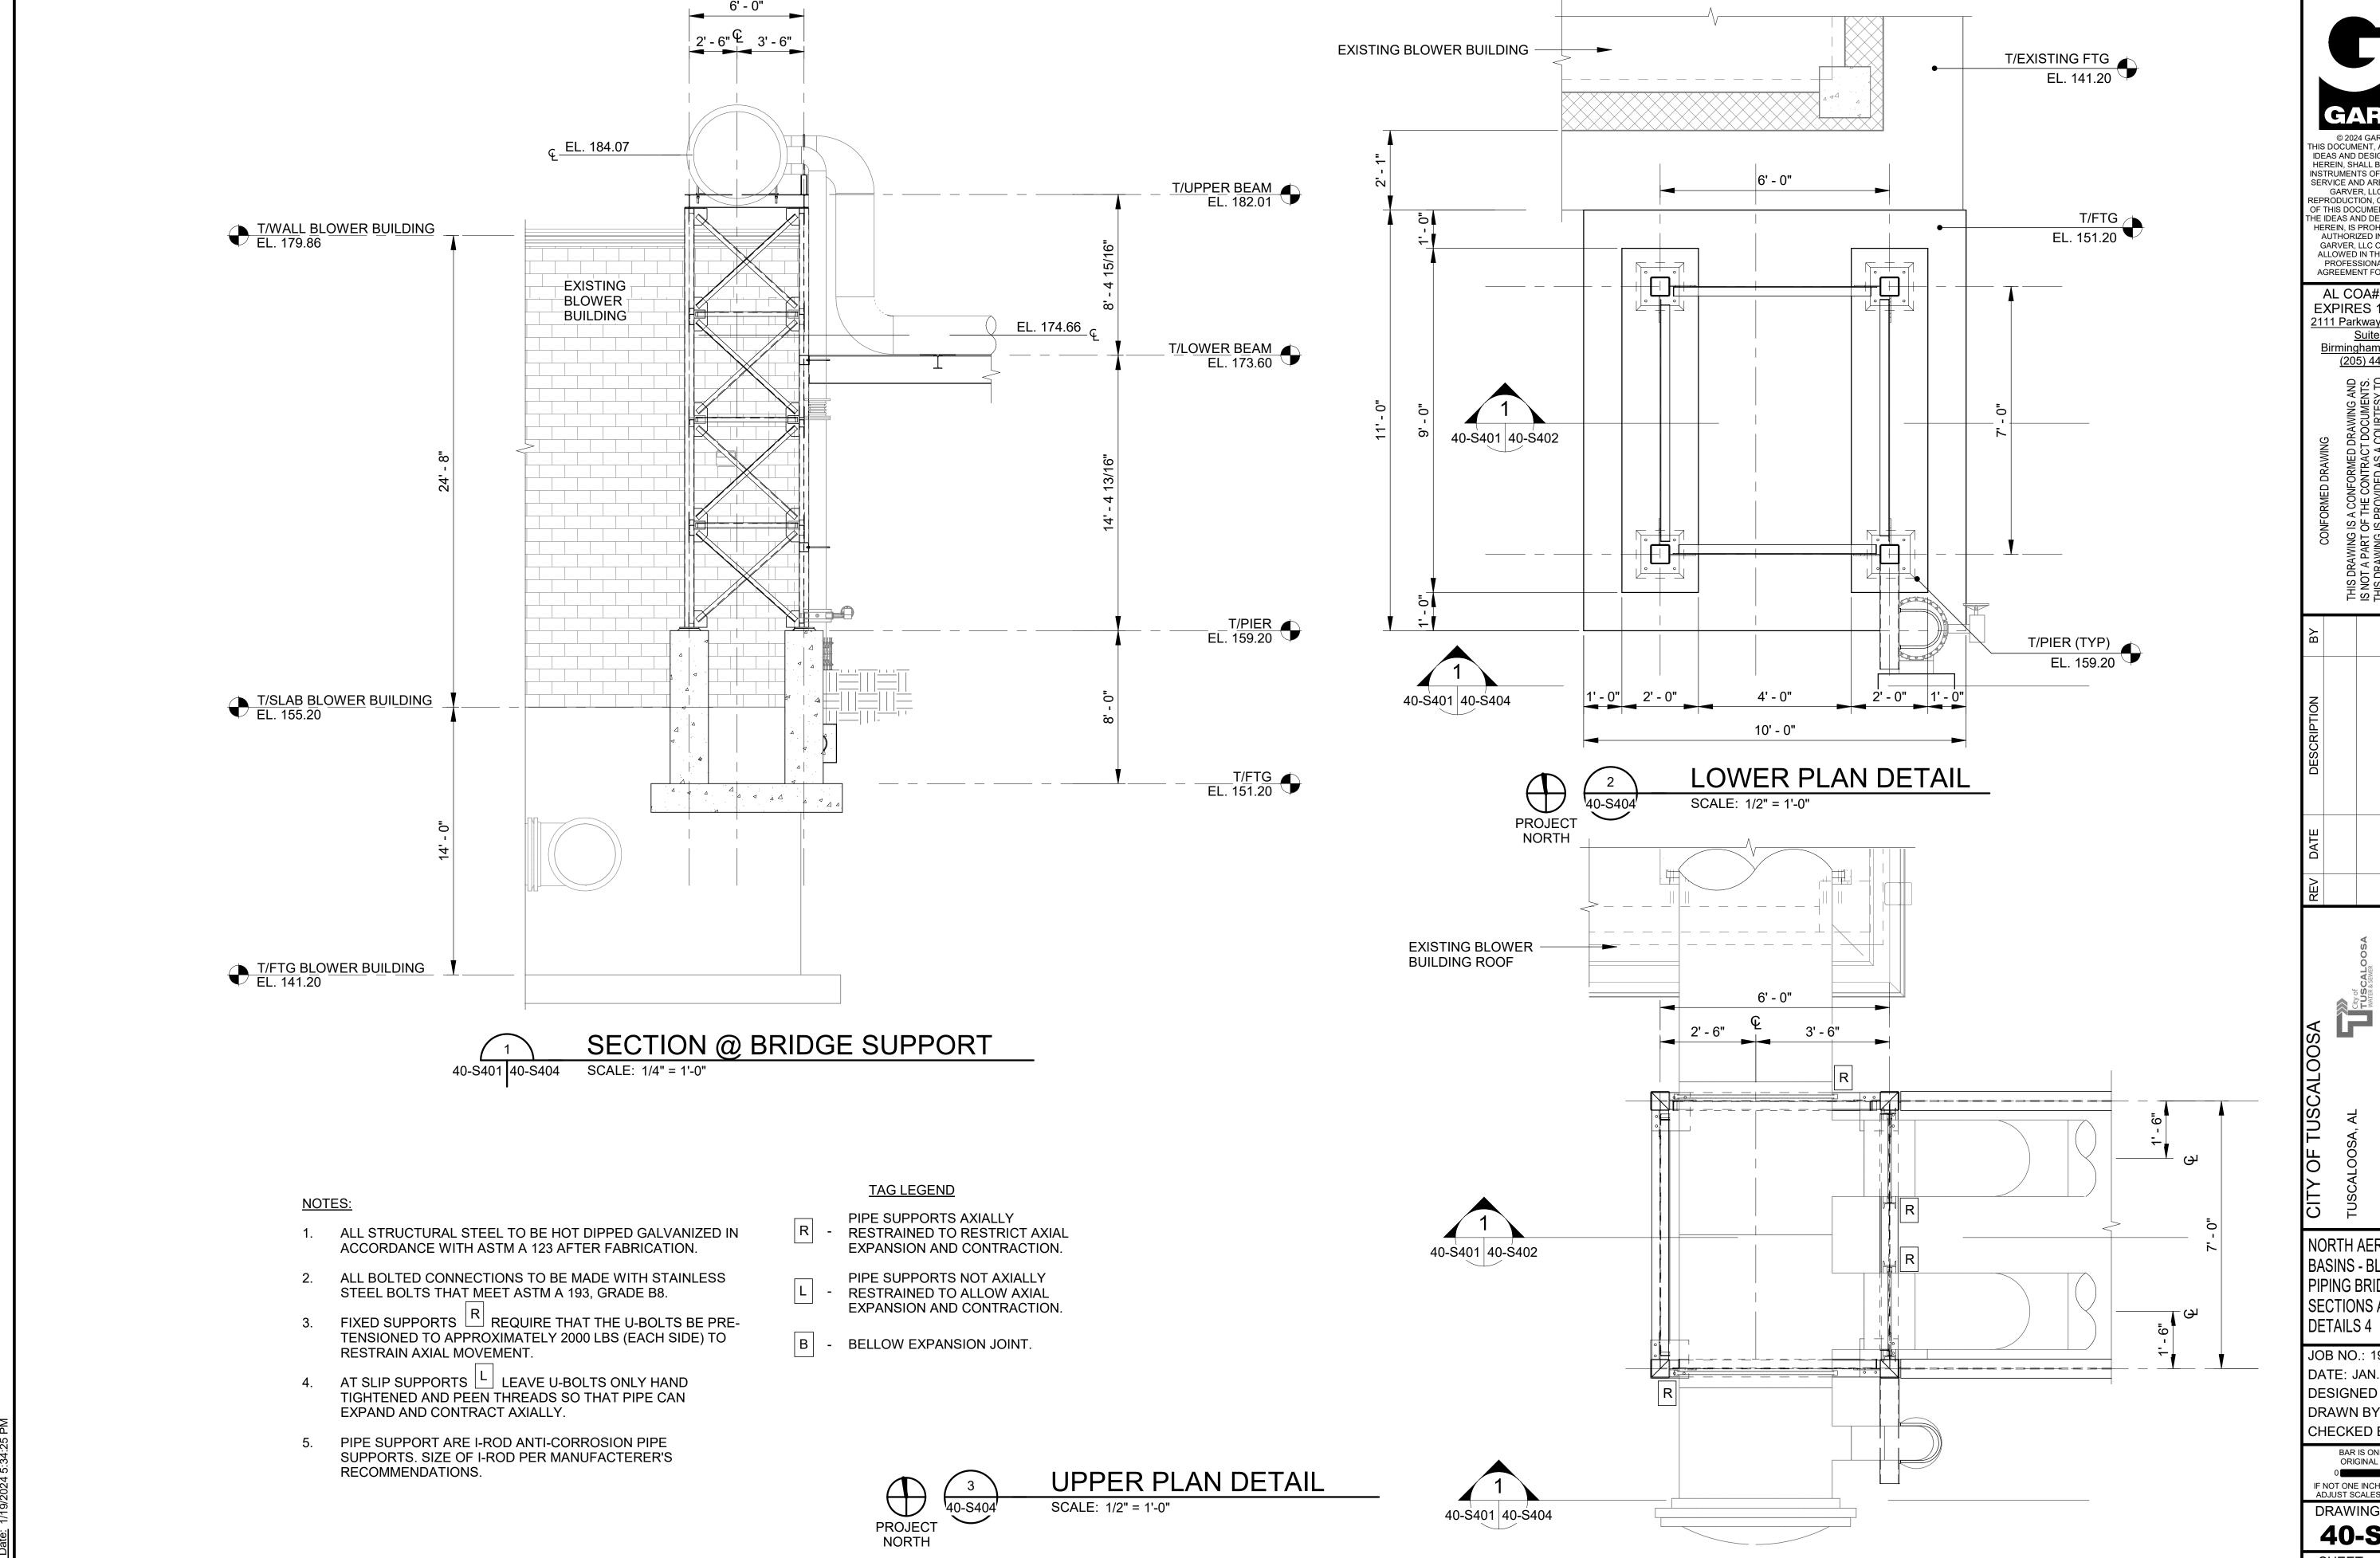
DRAWING NUMBER 40-\$401

SHEET 101

RECOMMENDATIONS.







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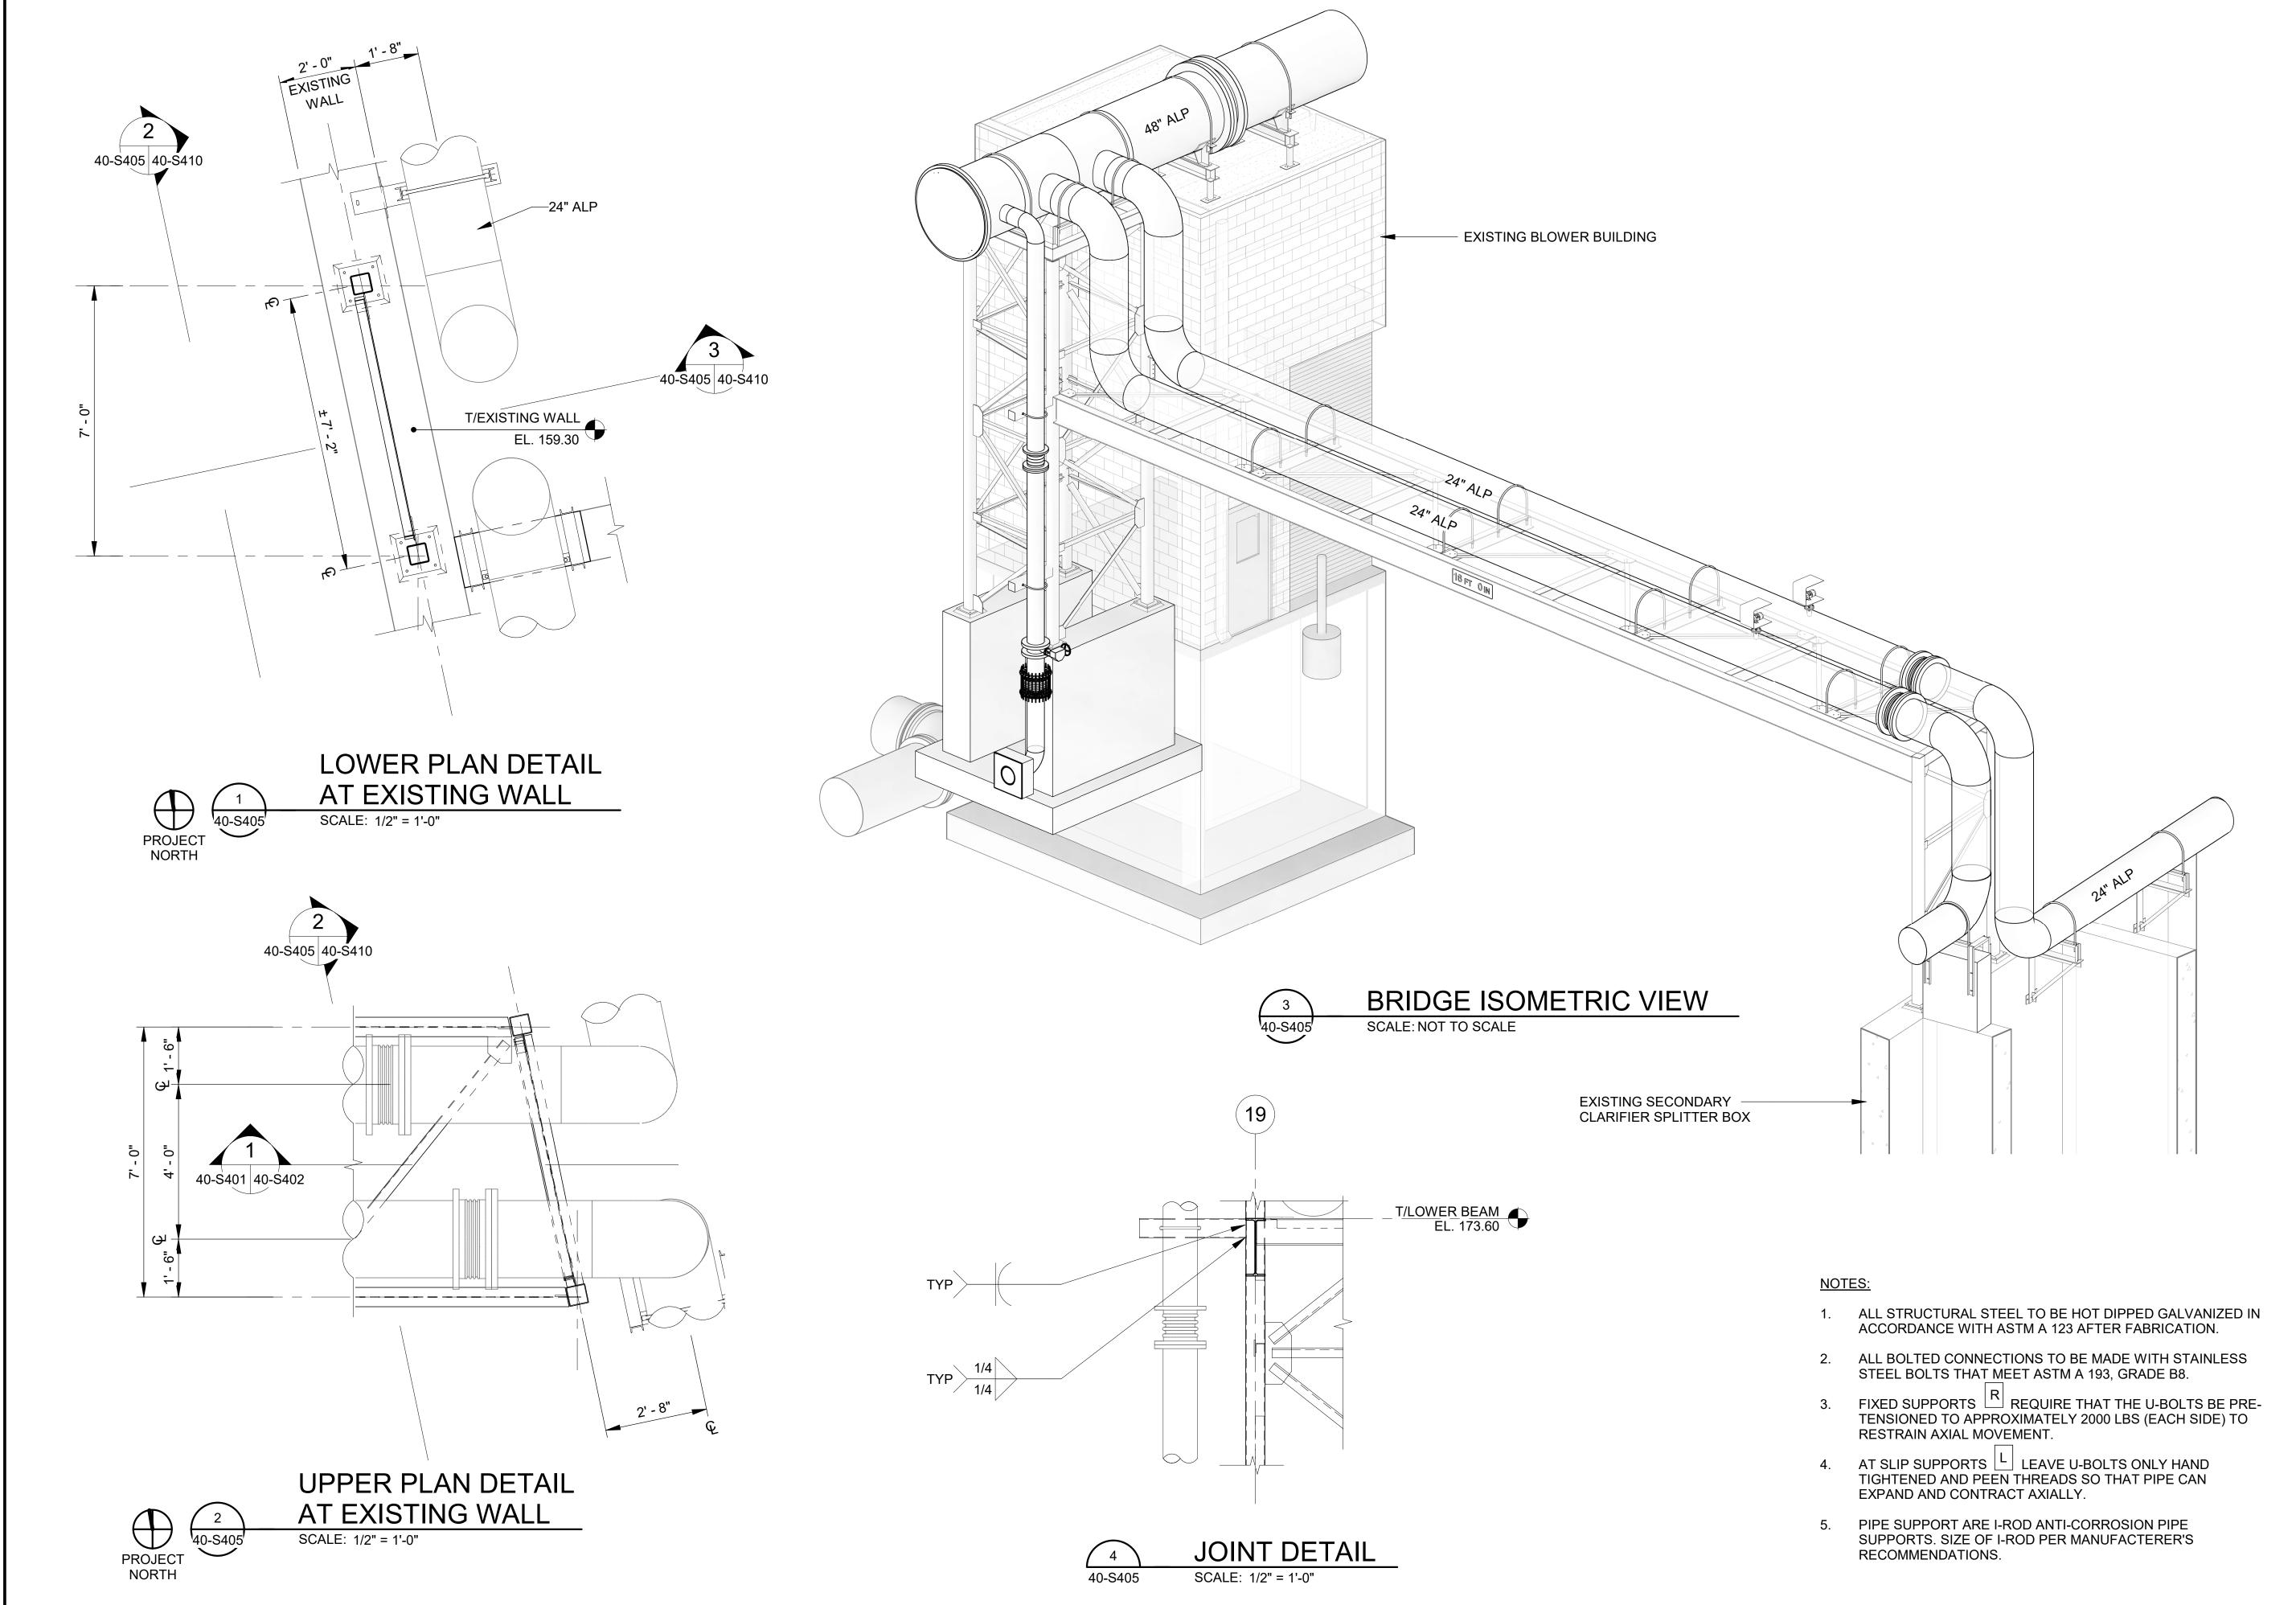
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NORTH AERATION BASINS - BLOWER

PIPING BRIDGE

SECTIONS AND

JOB NO.: 19W10160

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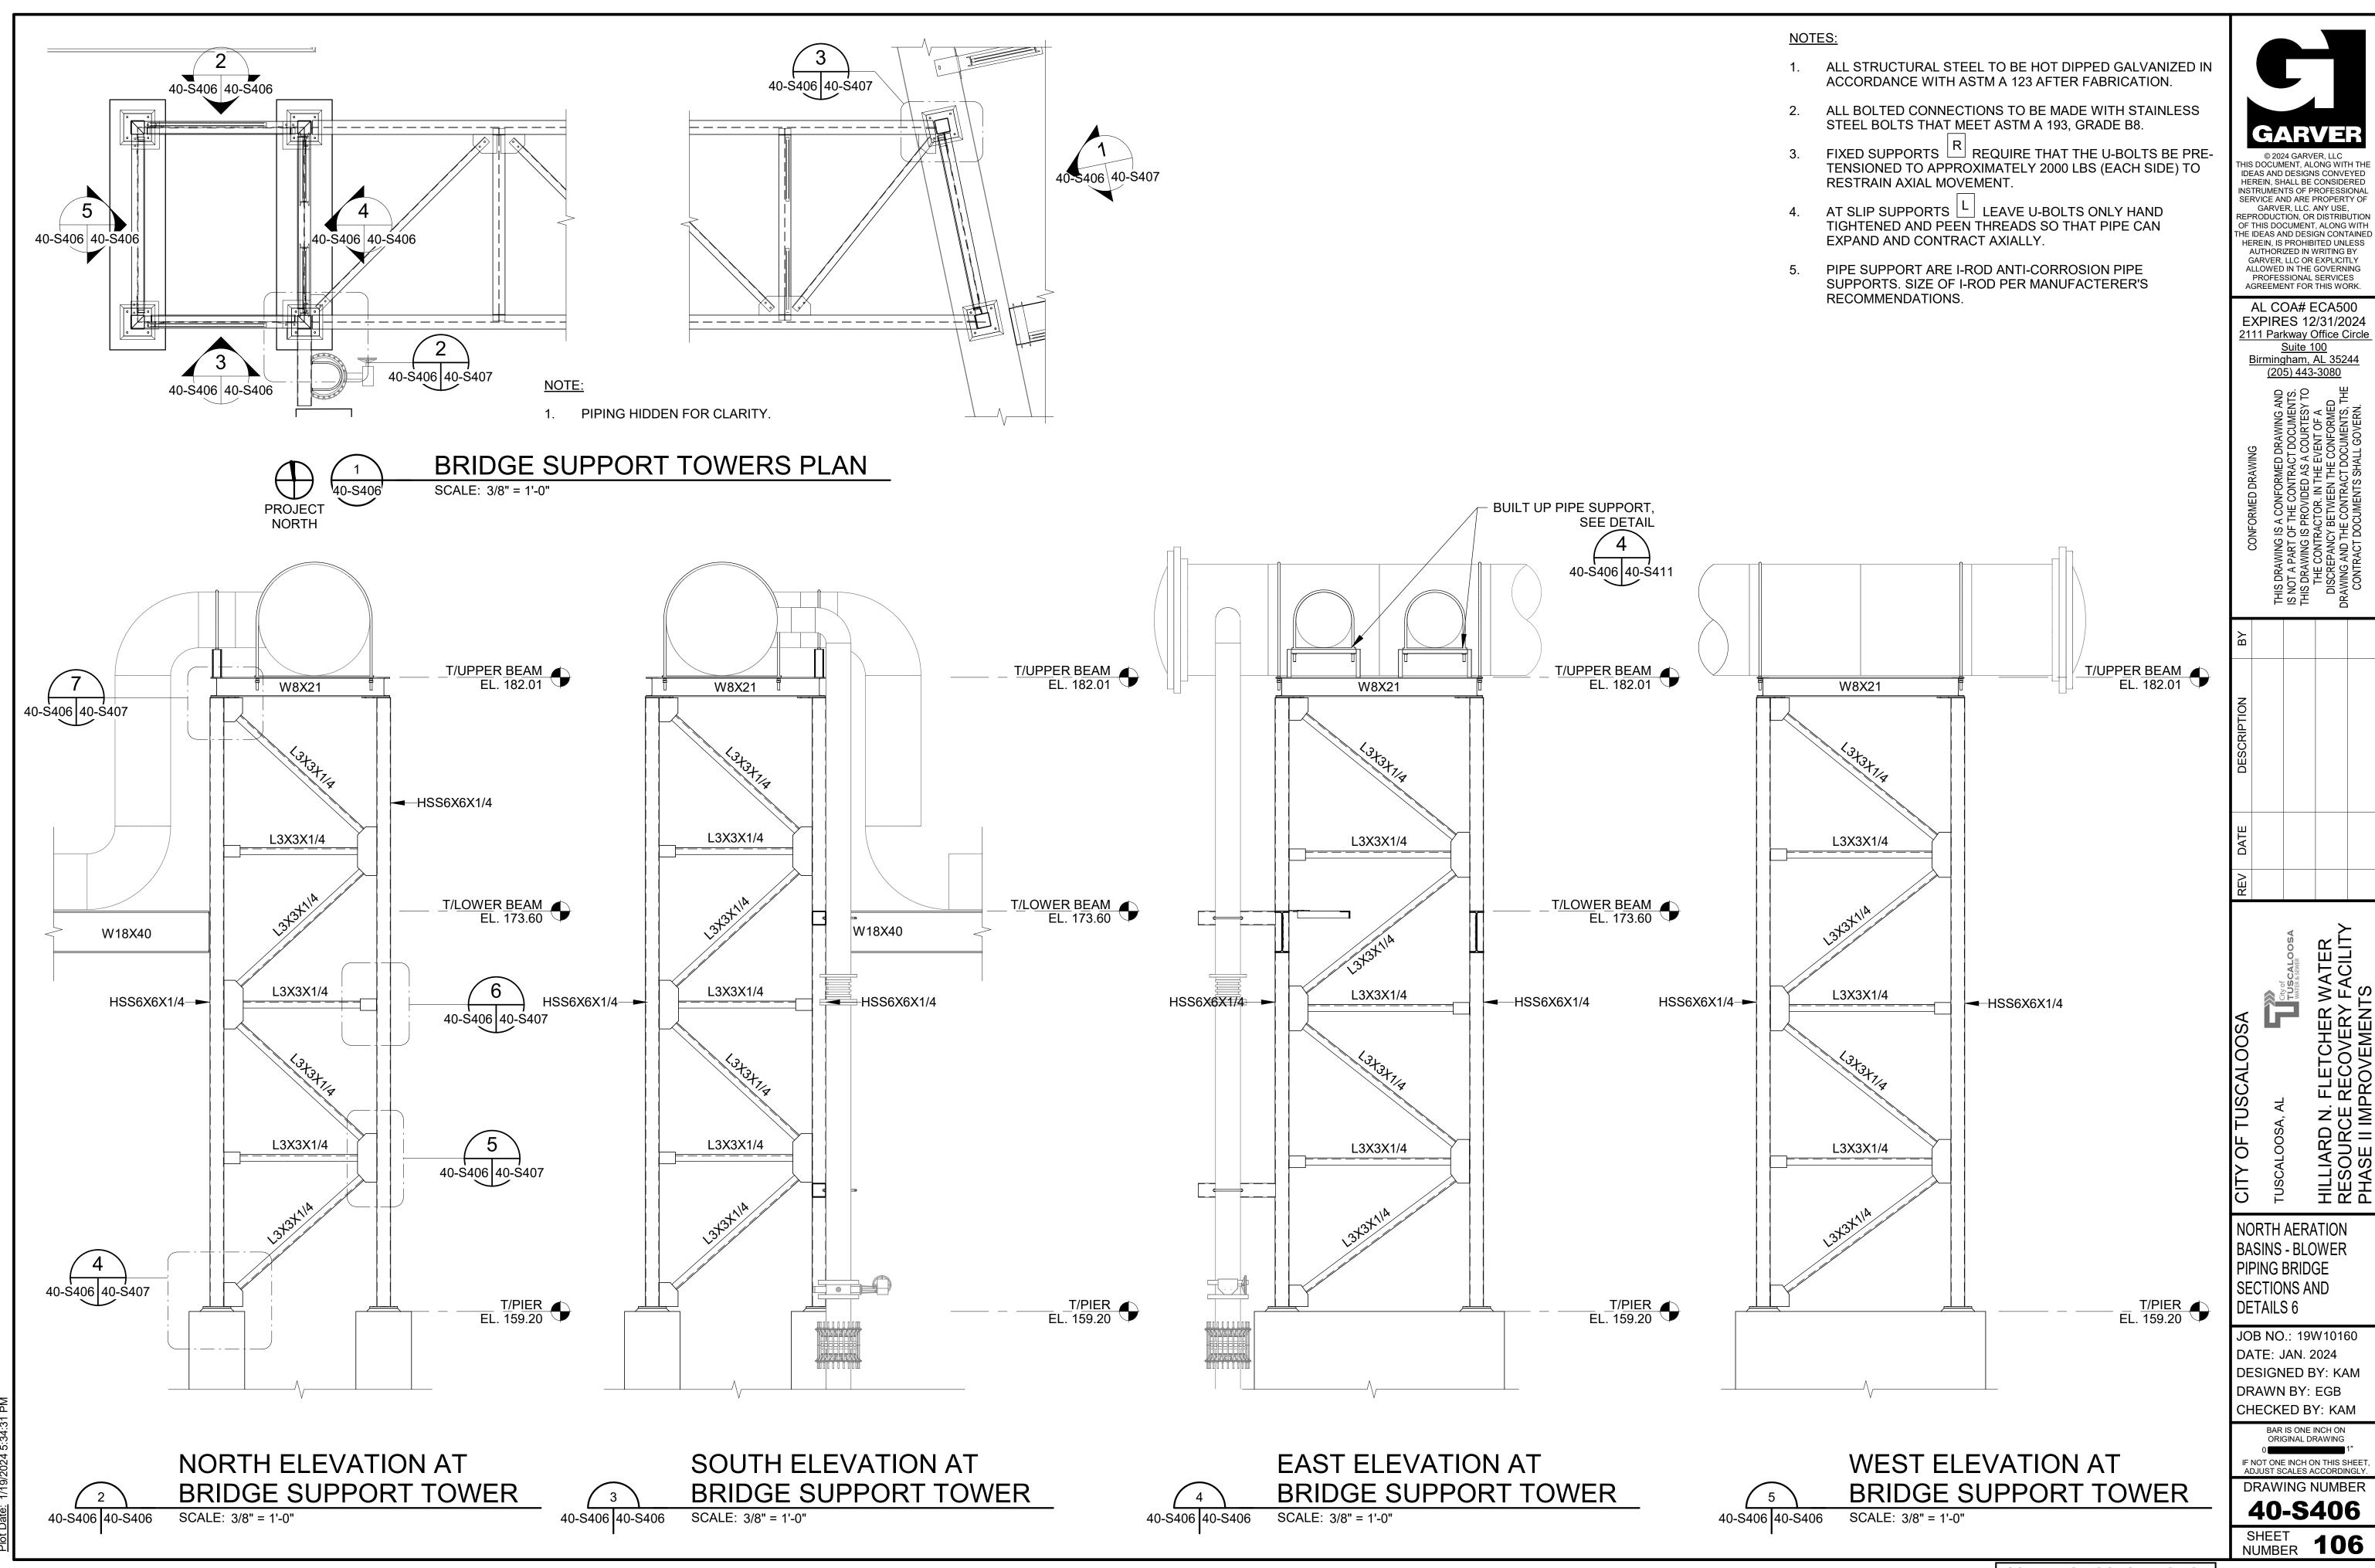
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DETAILS 5



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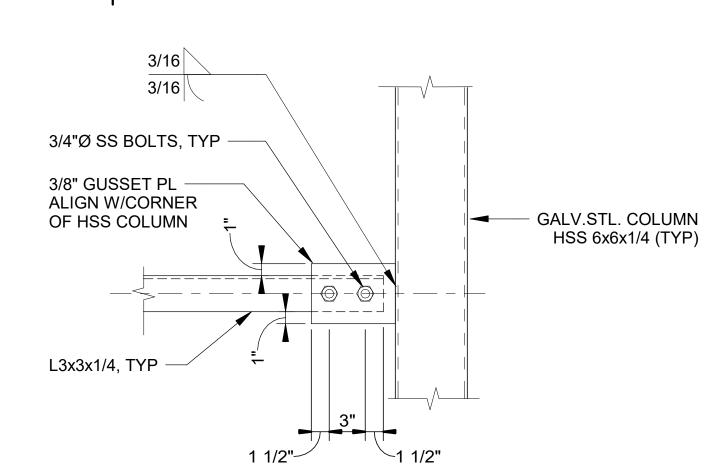
NORTH AERATION BASINS - BLOWER PIPING BRIDGE SECTIONS AND DETAILS 6

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ELEVATION VIEW BRIDGE SUPPORT TOWER AT AERATION BASIN




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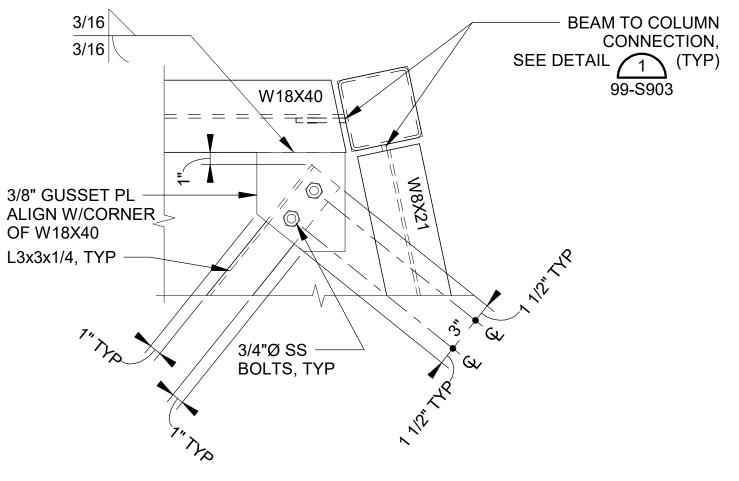
NOTES:

40-S406 40-S407


- 1. ALL STRUCTURAL STEEL TO BE HOT DIPPED GALVANIZED IN ACCORDANCE WITH ASTM A 123 AFTER FABRICATION.
- 2. ALL BOLTED CONNECTIONS TO BE MADE WITH STAINLESS STEEL BOLTS THAT MEET ASTM A 193, GRADE B8.
- 3. FIXED SUPPORTS REQUIRE THAT THE U-BOLTS BE PRE-TENSIONED TO APPROXIMATELY 2000 LBS (EACH SIDE) TO RESTRAIN AXIAL MOVEMENT.
- 4. AT SLIP SUPPORTS LEAVE U-BOLTS ONLY HAND TIGHTENED AND PEEN THREADS SO THAT PIPE CAN EXPAND AND CONTRACT AXIALLY.
- 5. PIPE SUPPORT ARE I-ROD ANTI-CORROSION PIPE SUPPORTS. SIZE OF I-ROD PER MANUFACTERER'S RECOMMENDATIONS.






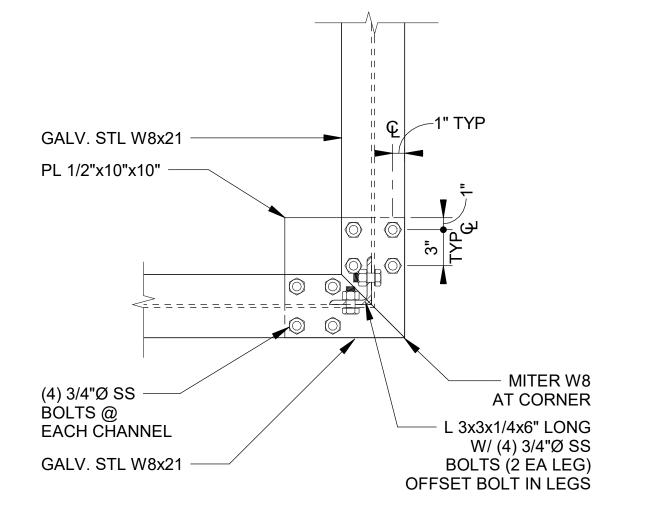


BRIDGE SUPPORT DETAIL 40-S406 40-S407 SCALE: 1 1/2" = 1'-0"

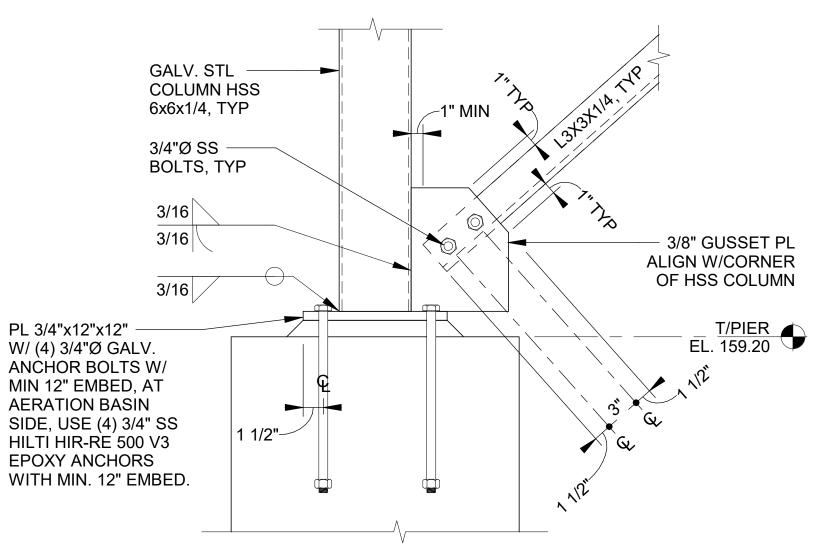



BRIDGE SUPPORT DETAIL 40-S406 40-S407 SCALE: 1 1/2" = 1'-0"

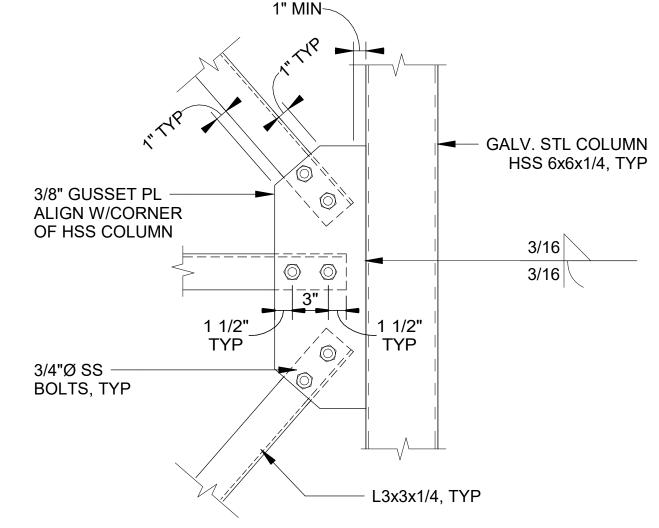

BRIDGE SUPPORT DETAIL SCALE: 1 1/2" = 1'-0" 40-S406 40-S407

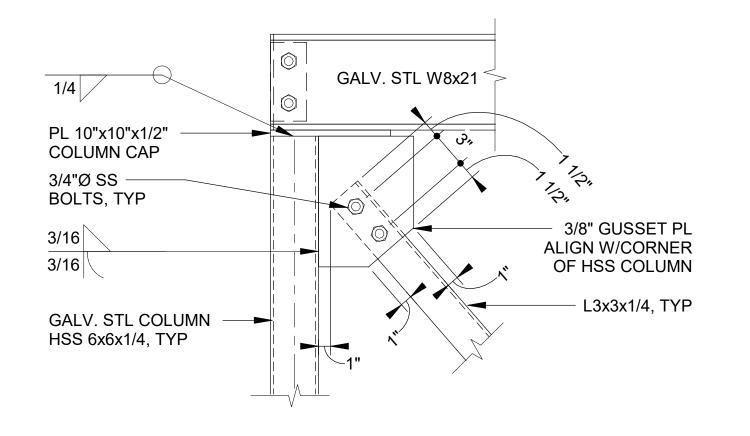

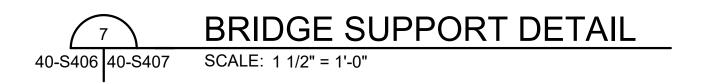

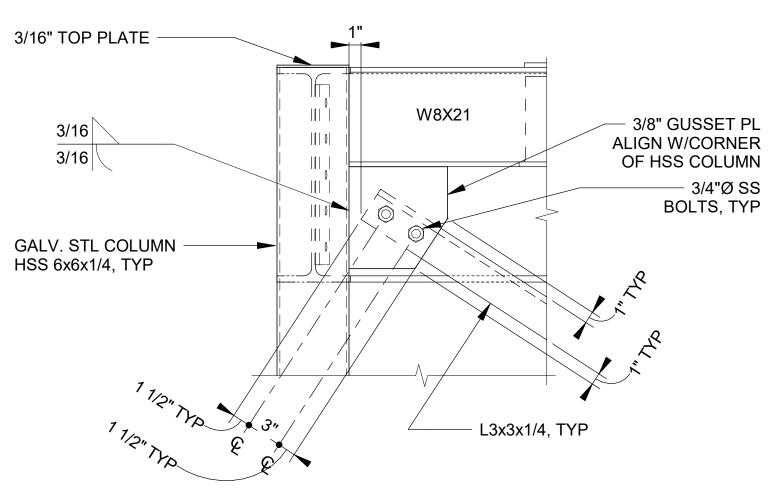


BRIDGE SUPPORT DETAIL 40-S407 40-S407 SCALE: 1 1/2" = 1'-0"

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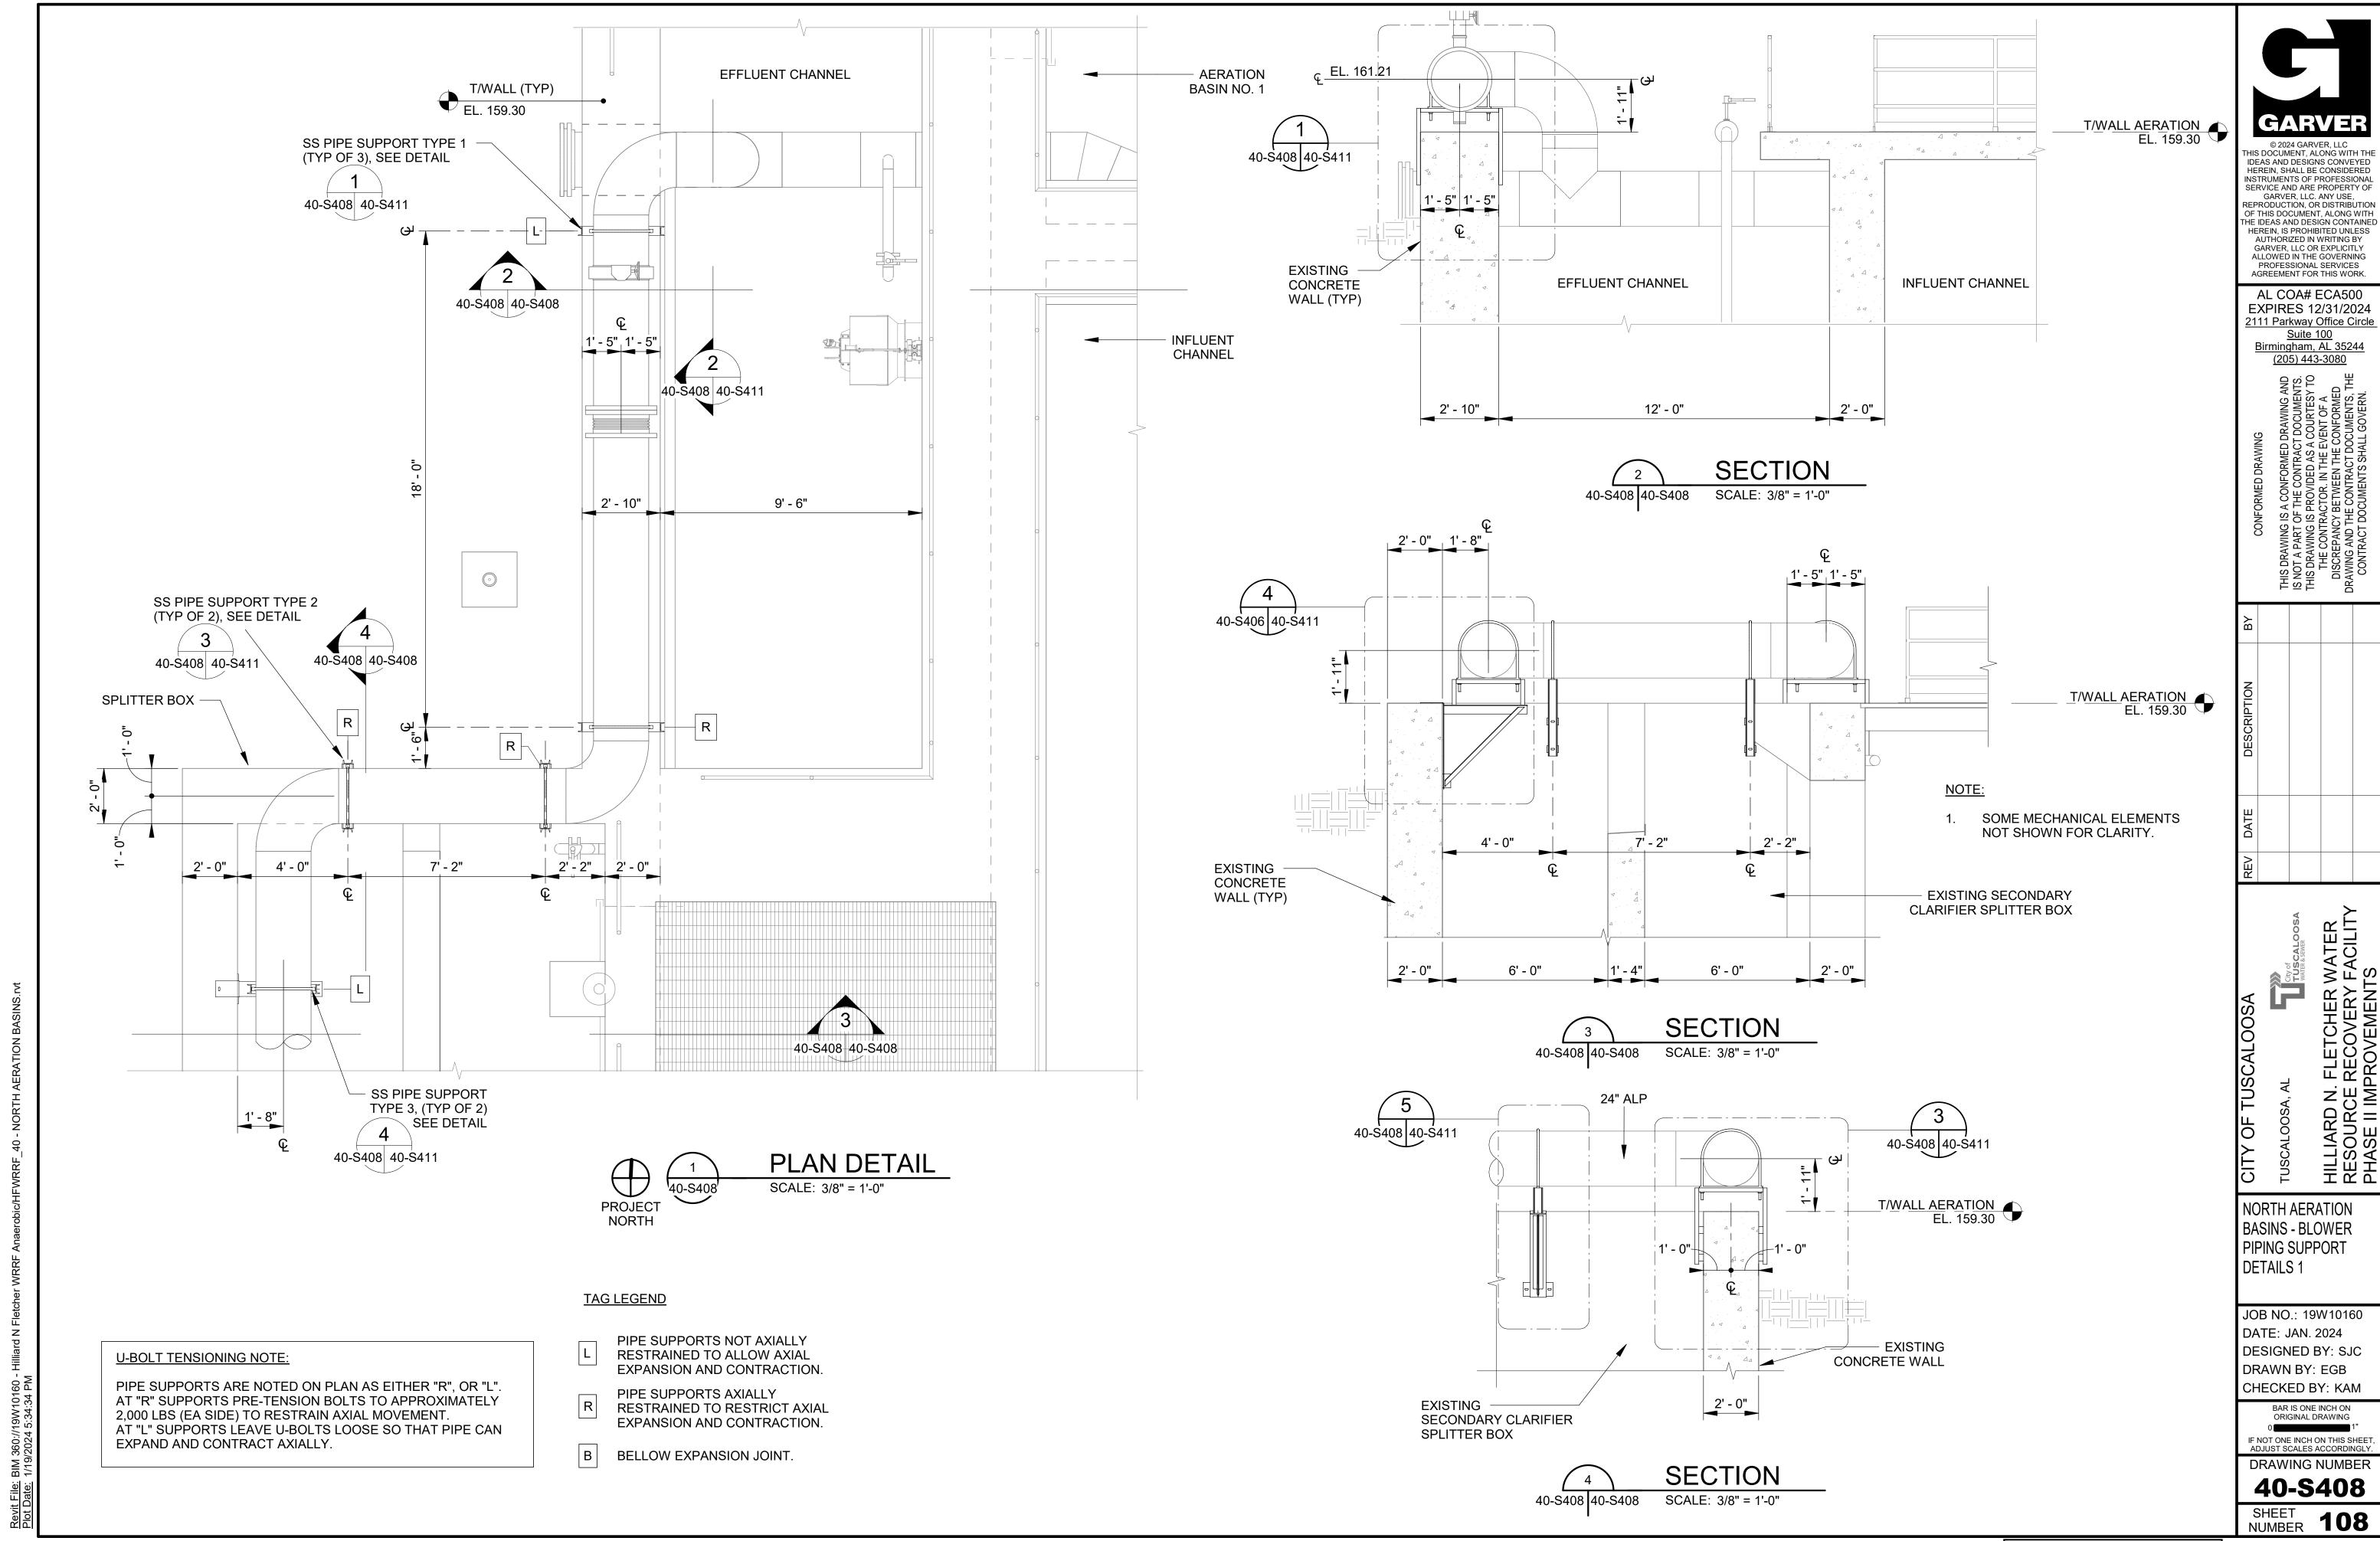
NORTH AERATION BASINS - BLOWER PIPING BRIDGE SECTIONS AND DETAILS 7


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40-\$407 SHEET 107



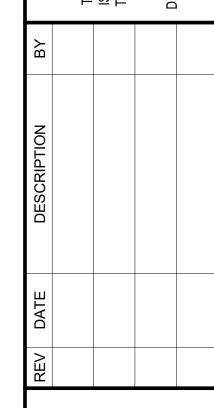

U-BOLT TENSIONING NOTE:

PIPE SUPPORTS ARE NOTED ON PLAN AS EITHER "R", OR "L". AT "R" SUPPORTS PRE-TENSION BOLTS TO APPROXIMATELY 2,000 LBS (EA SIDE) TO RESTRAIN AXIAL MOVEMENT. AT "L" SUPPORTS LEAVE U-BOLTS LOOSE SO THAT PIPE CAN EXPAND AND CONTRACT AXIALLY.

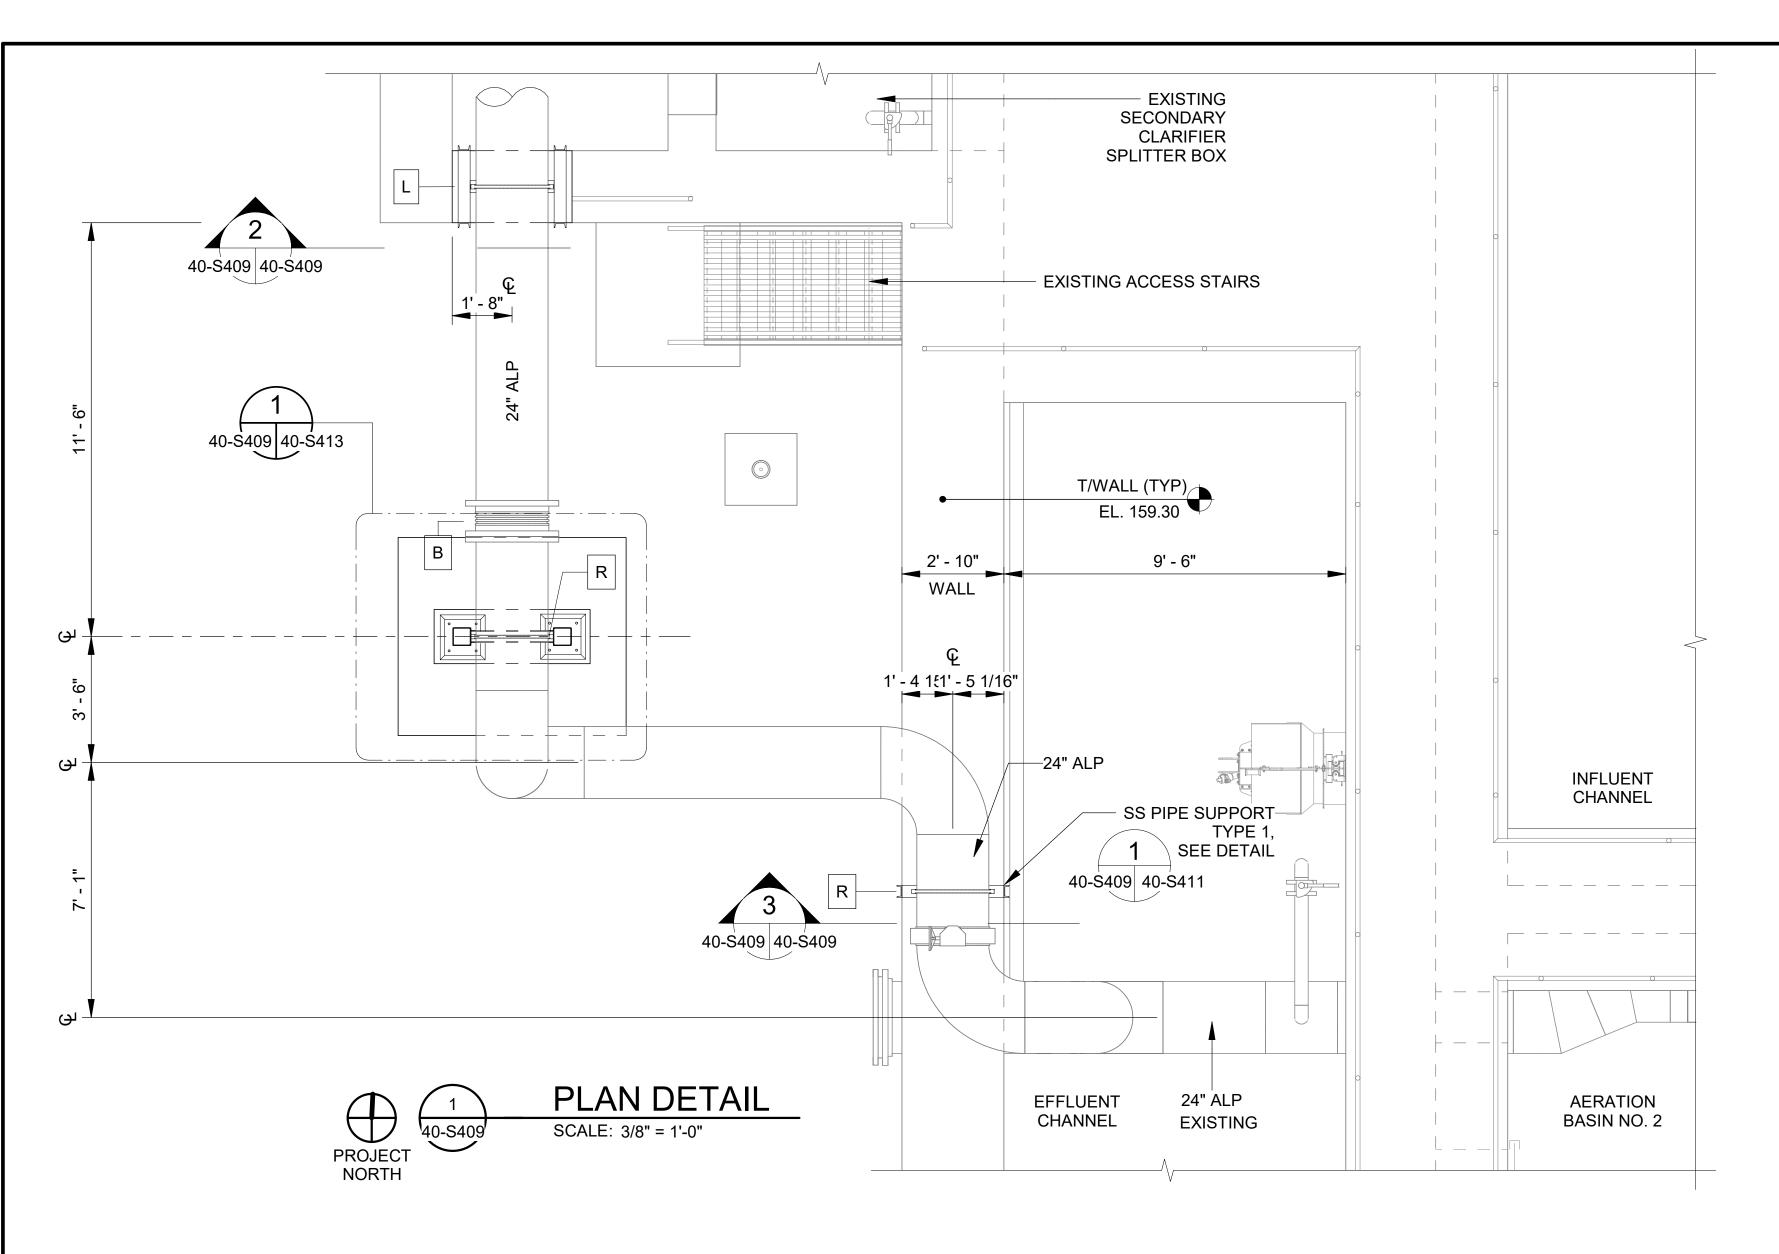TAG LEGEND

- PIPE SUPPORTS NOT AXIALLY RESTRAINED TO ALLOW AXIAL EXPANSION AND CONTRACTION.
- PIPE SUPPORTS AXIALLY RESTRAINED TO RESTRICT AXIAL EXPANSION AND CONTRACTION.
- BELLOW EXPANSION JOINT.



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NORTH AERATION BASINS - BLOWER PIPING SUPPORT DETAILS 2

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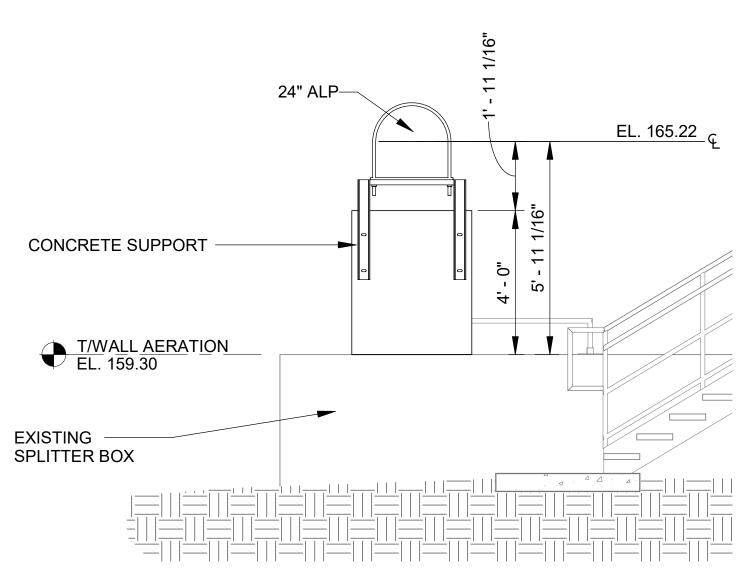
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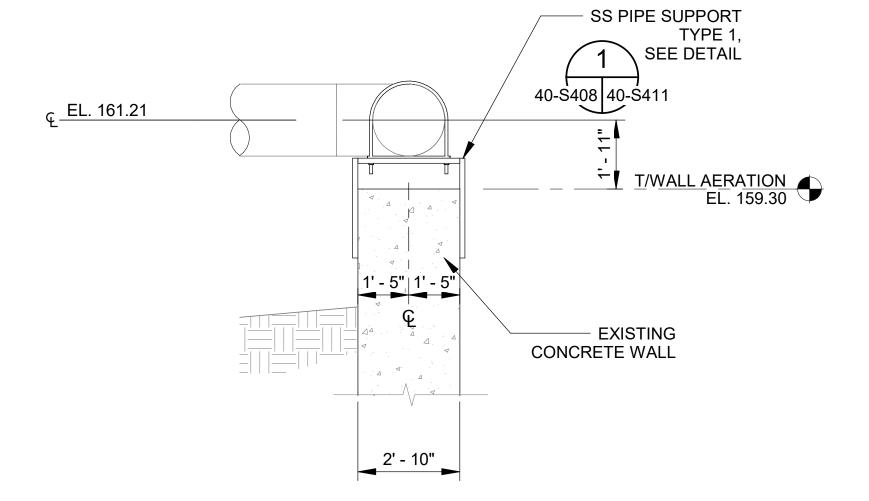
DRAWING NUMBER 40-\$409


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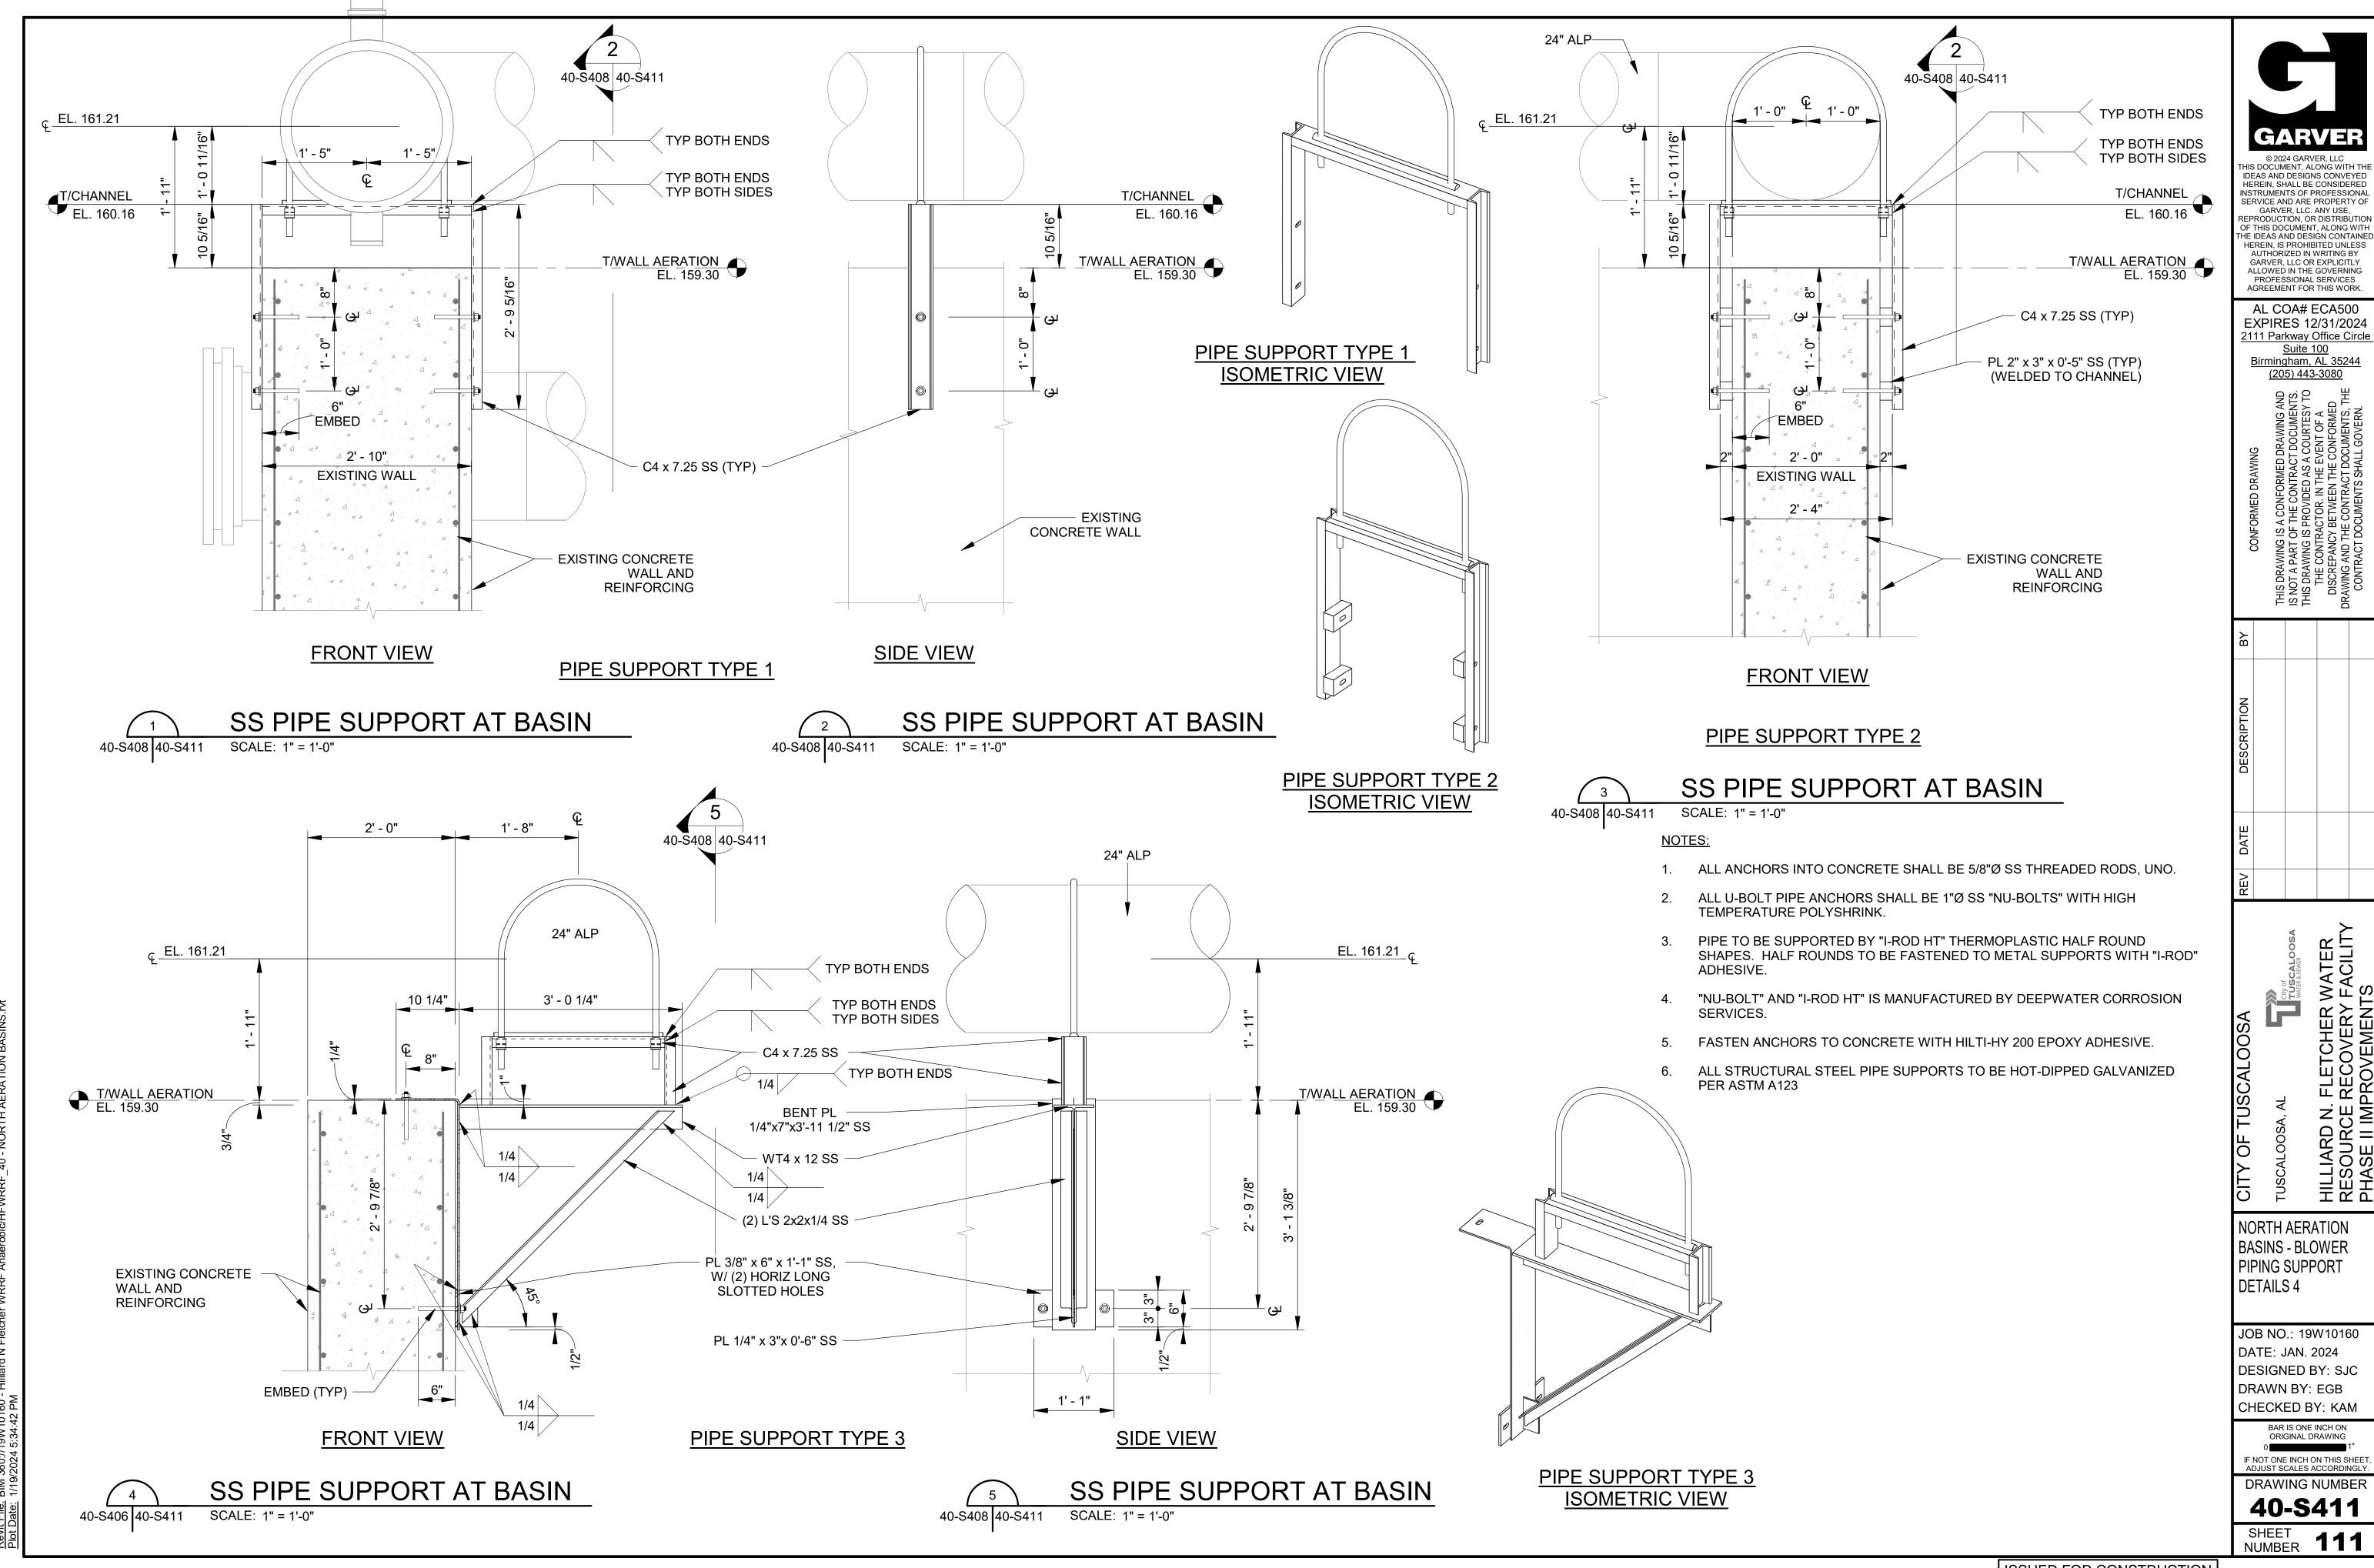



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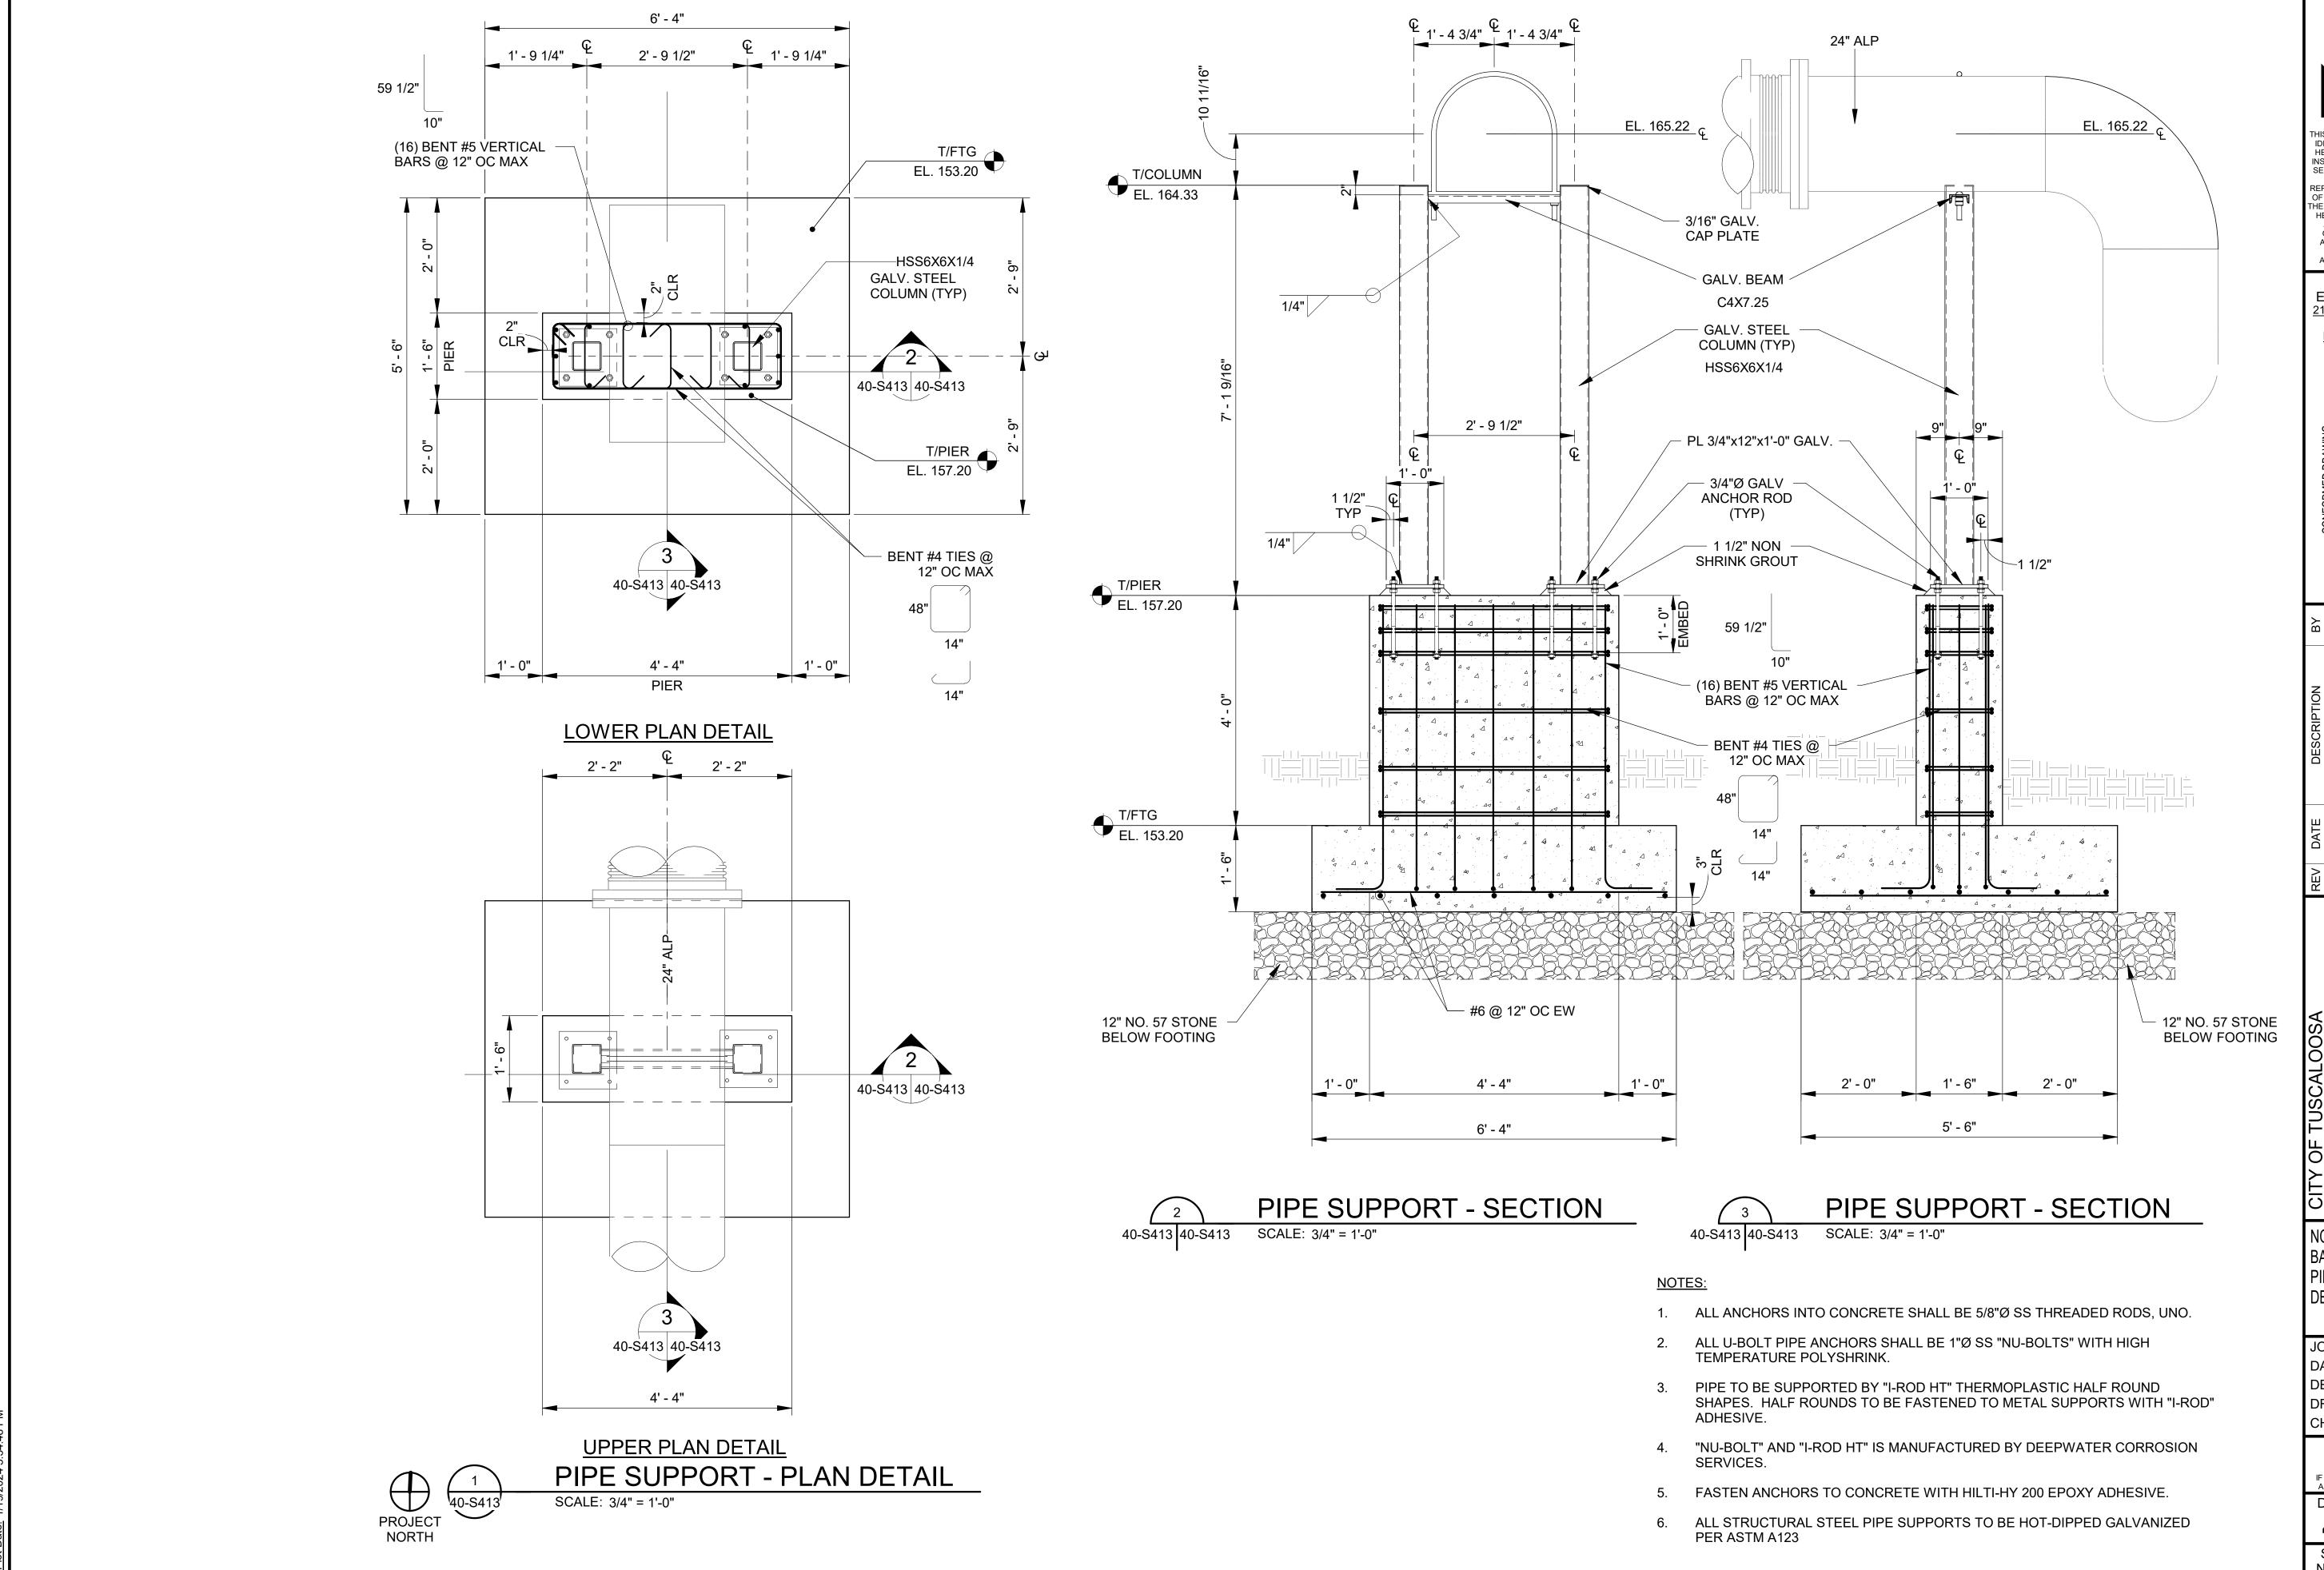
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TUSCALOOSA, AL
HILLIARD N. FLETCHE
RESOURCE RECOVER

NORTH AERATION BASINS - BLOWER PIPING SUPPORT DETAILS 6

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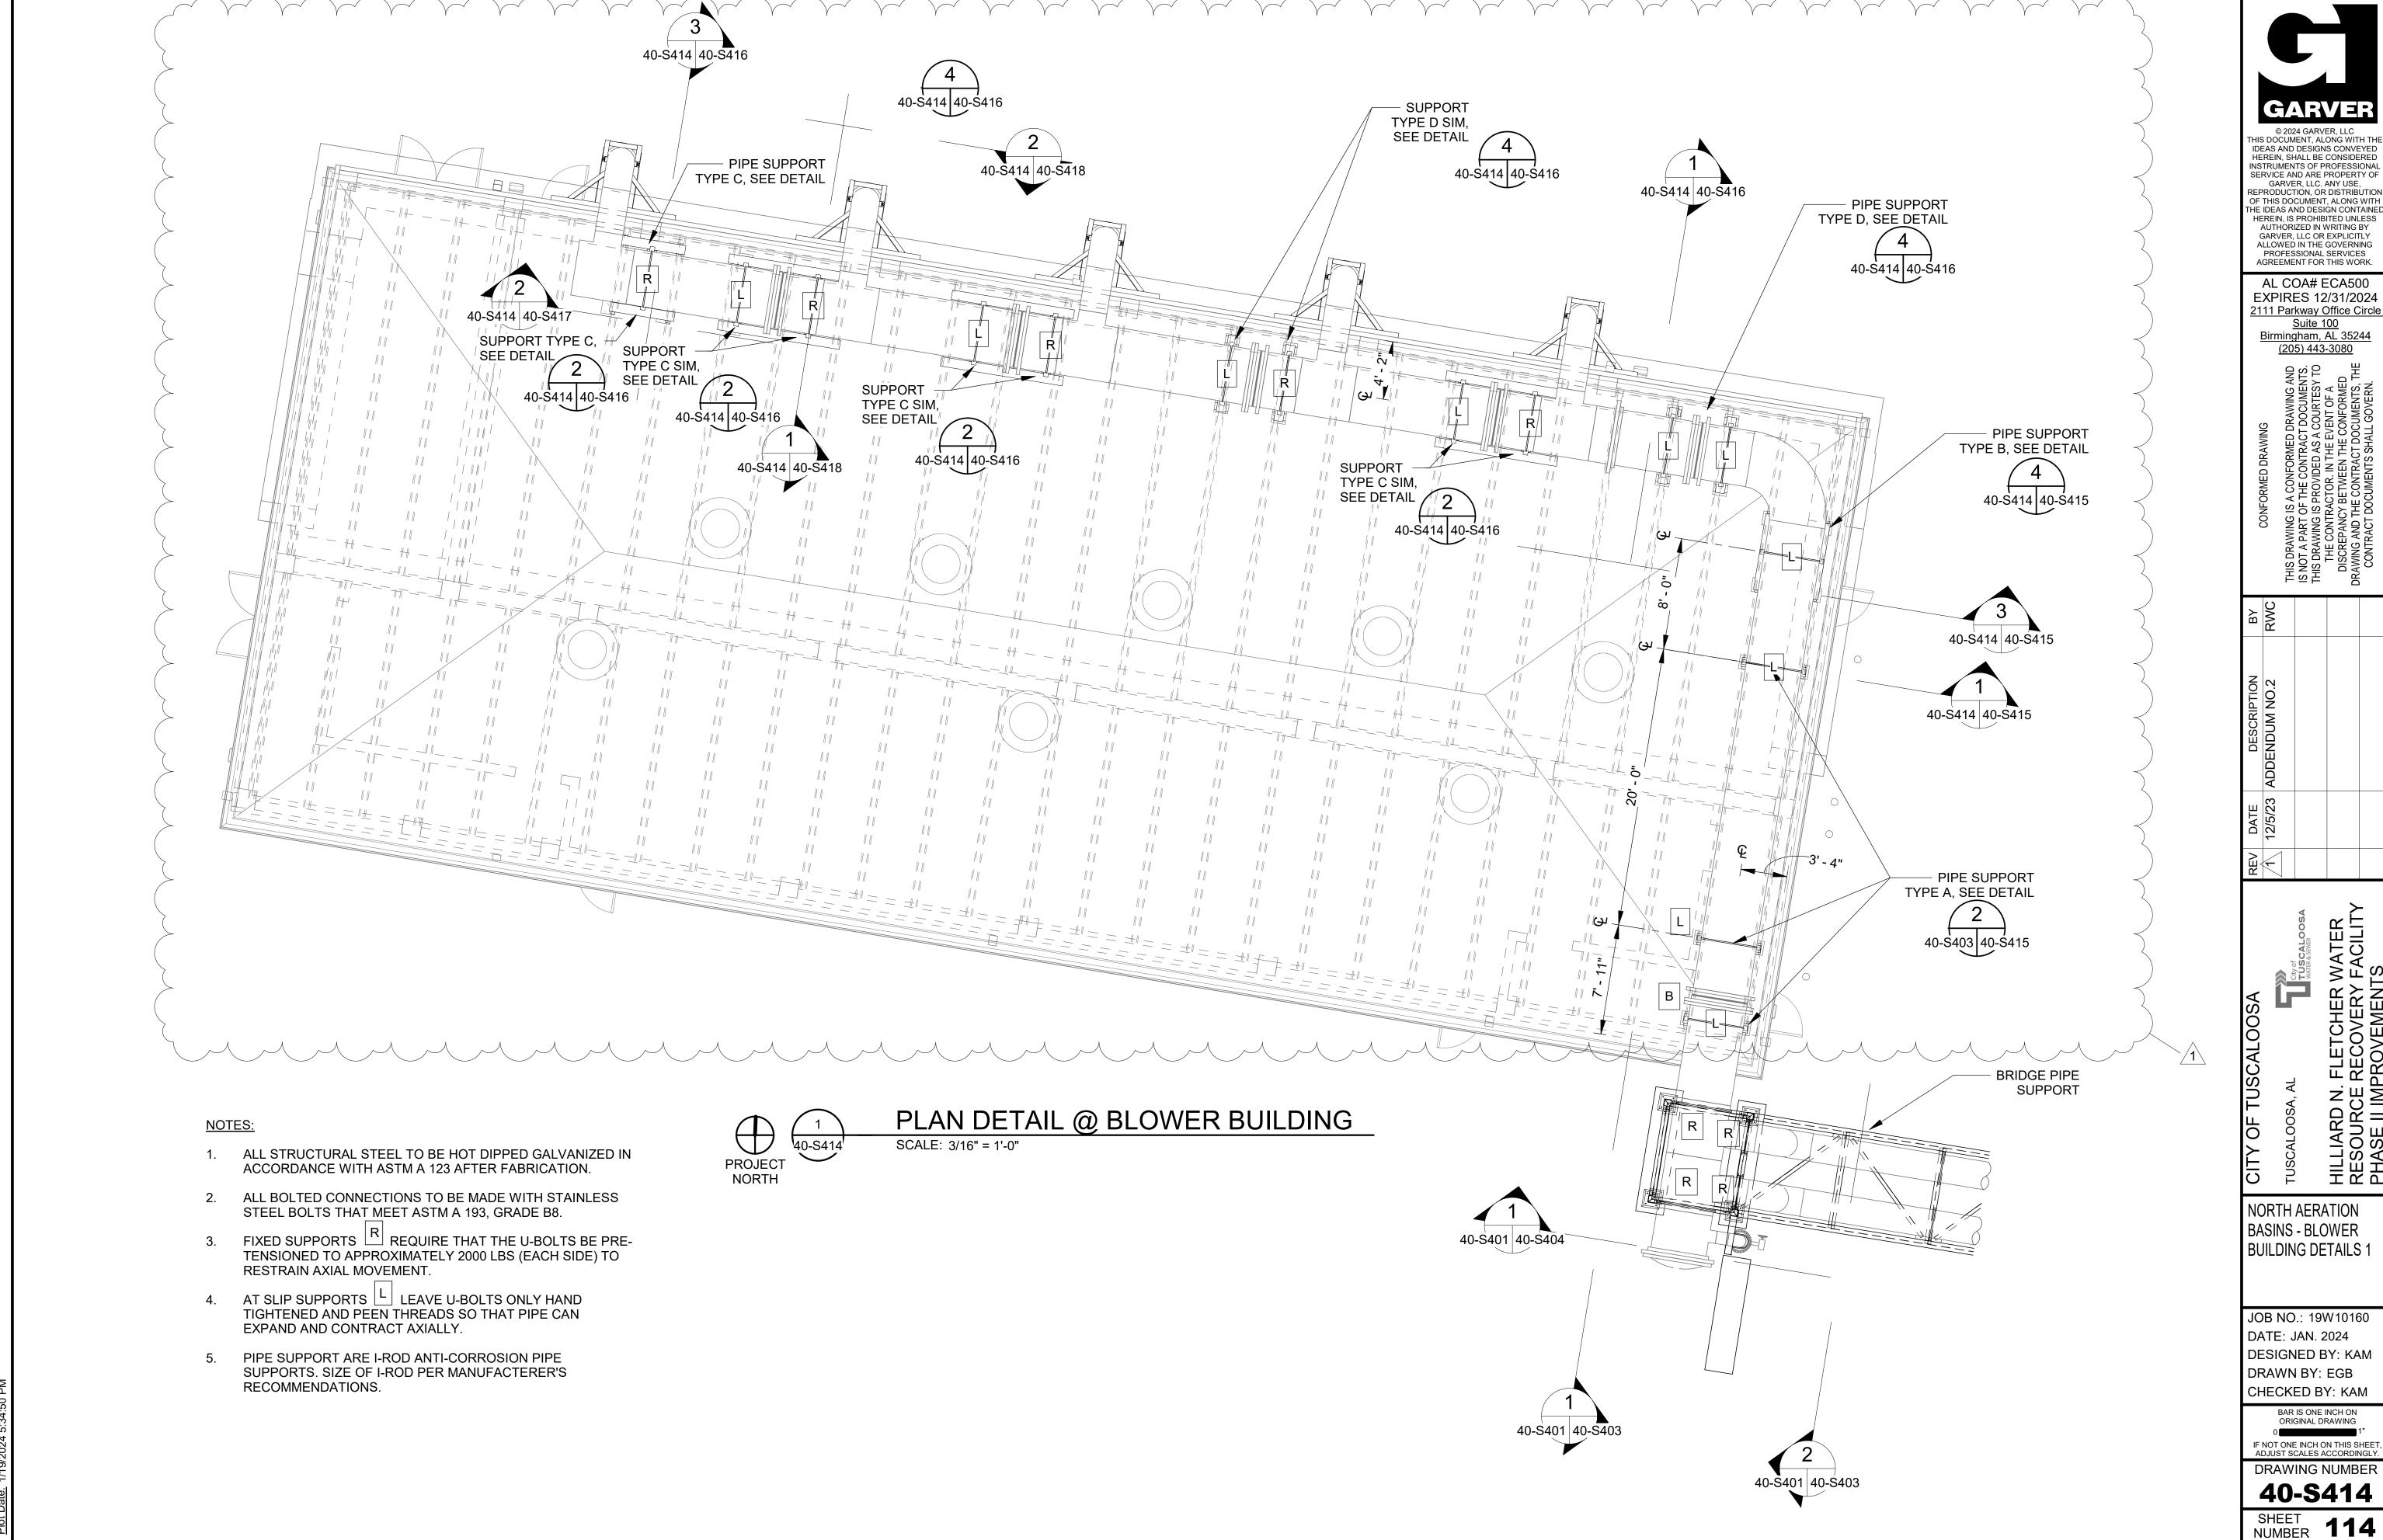
of 1"


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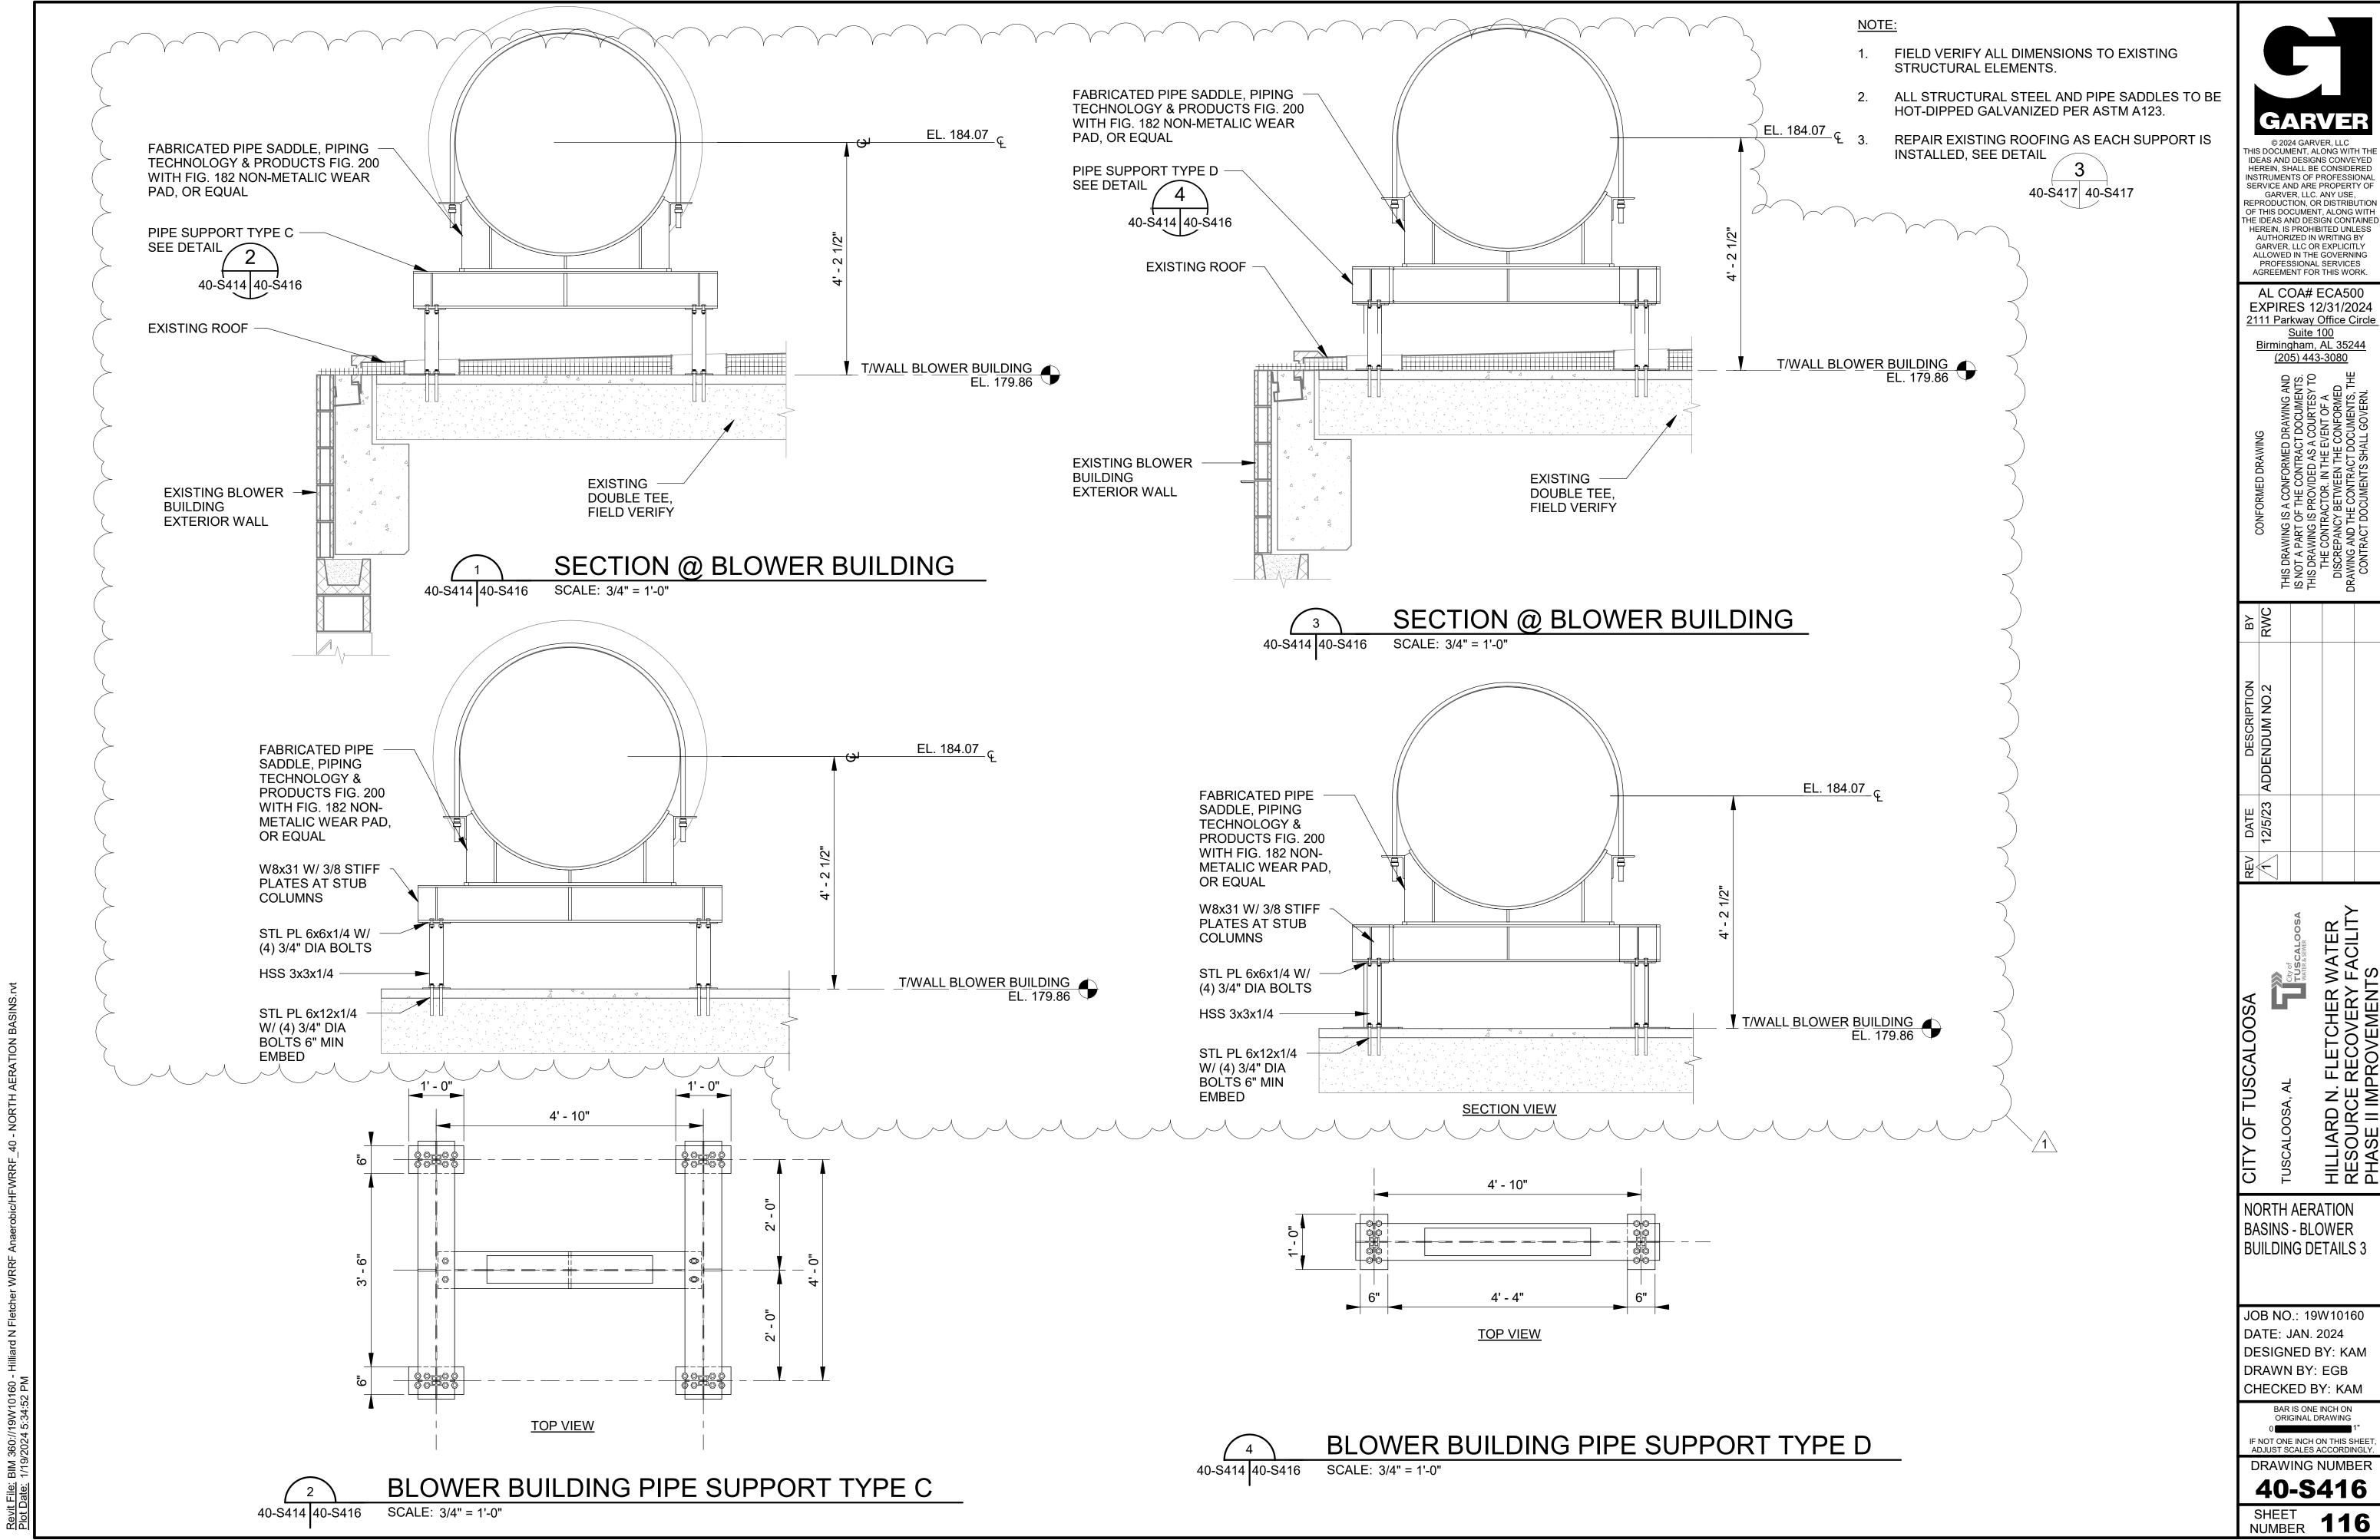
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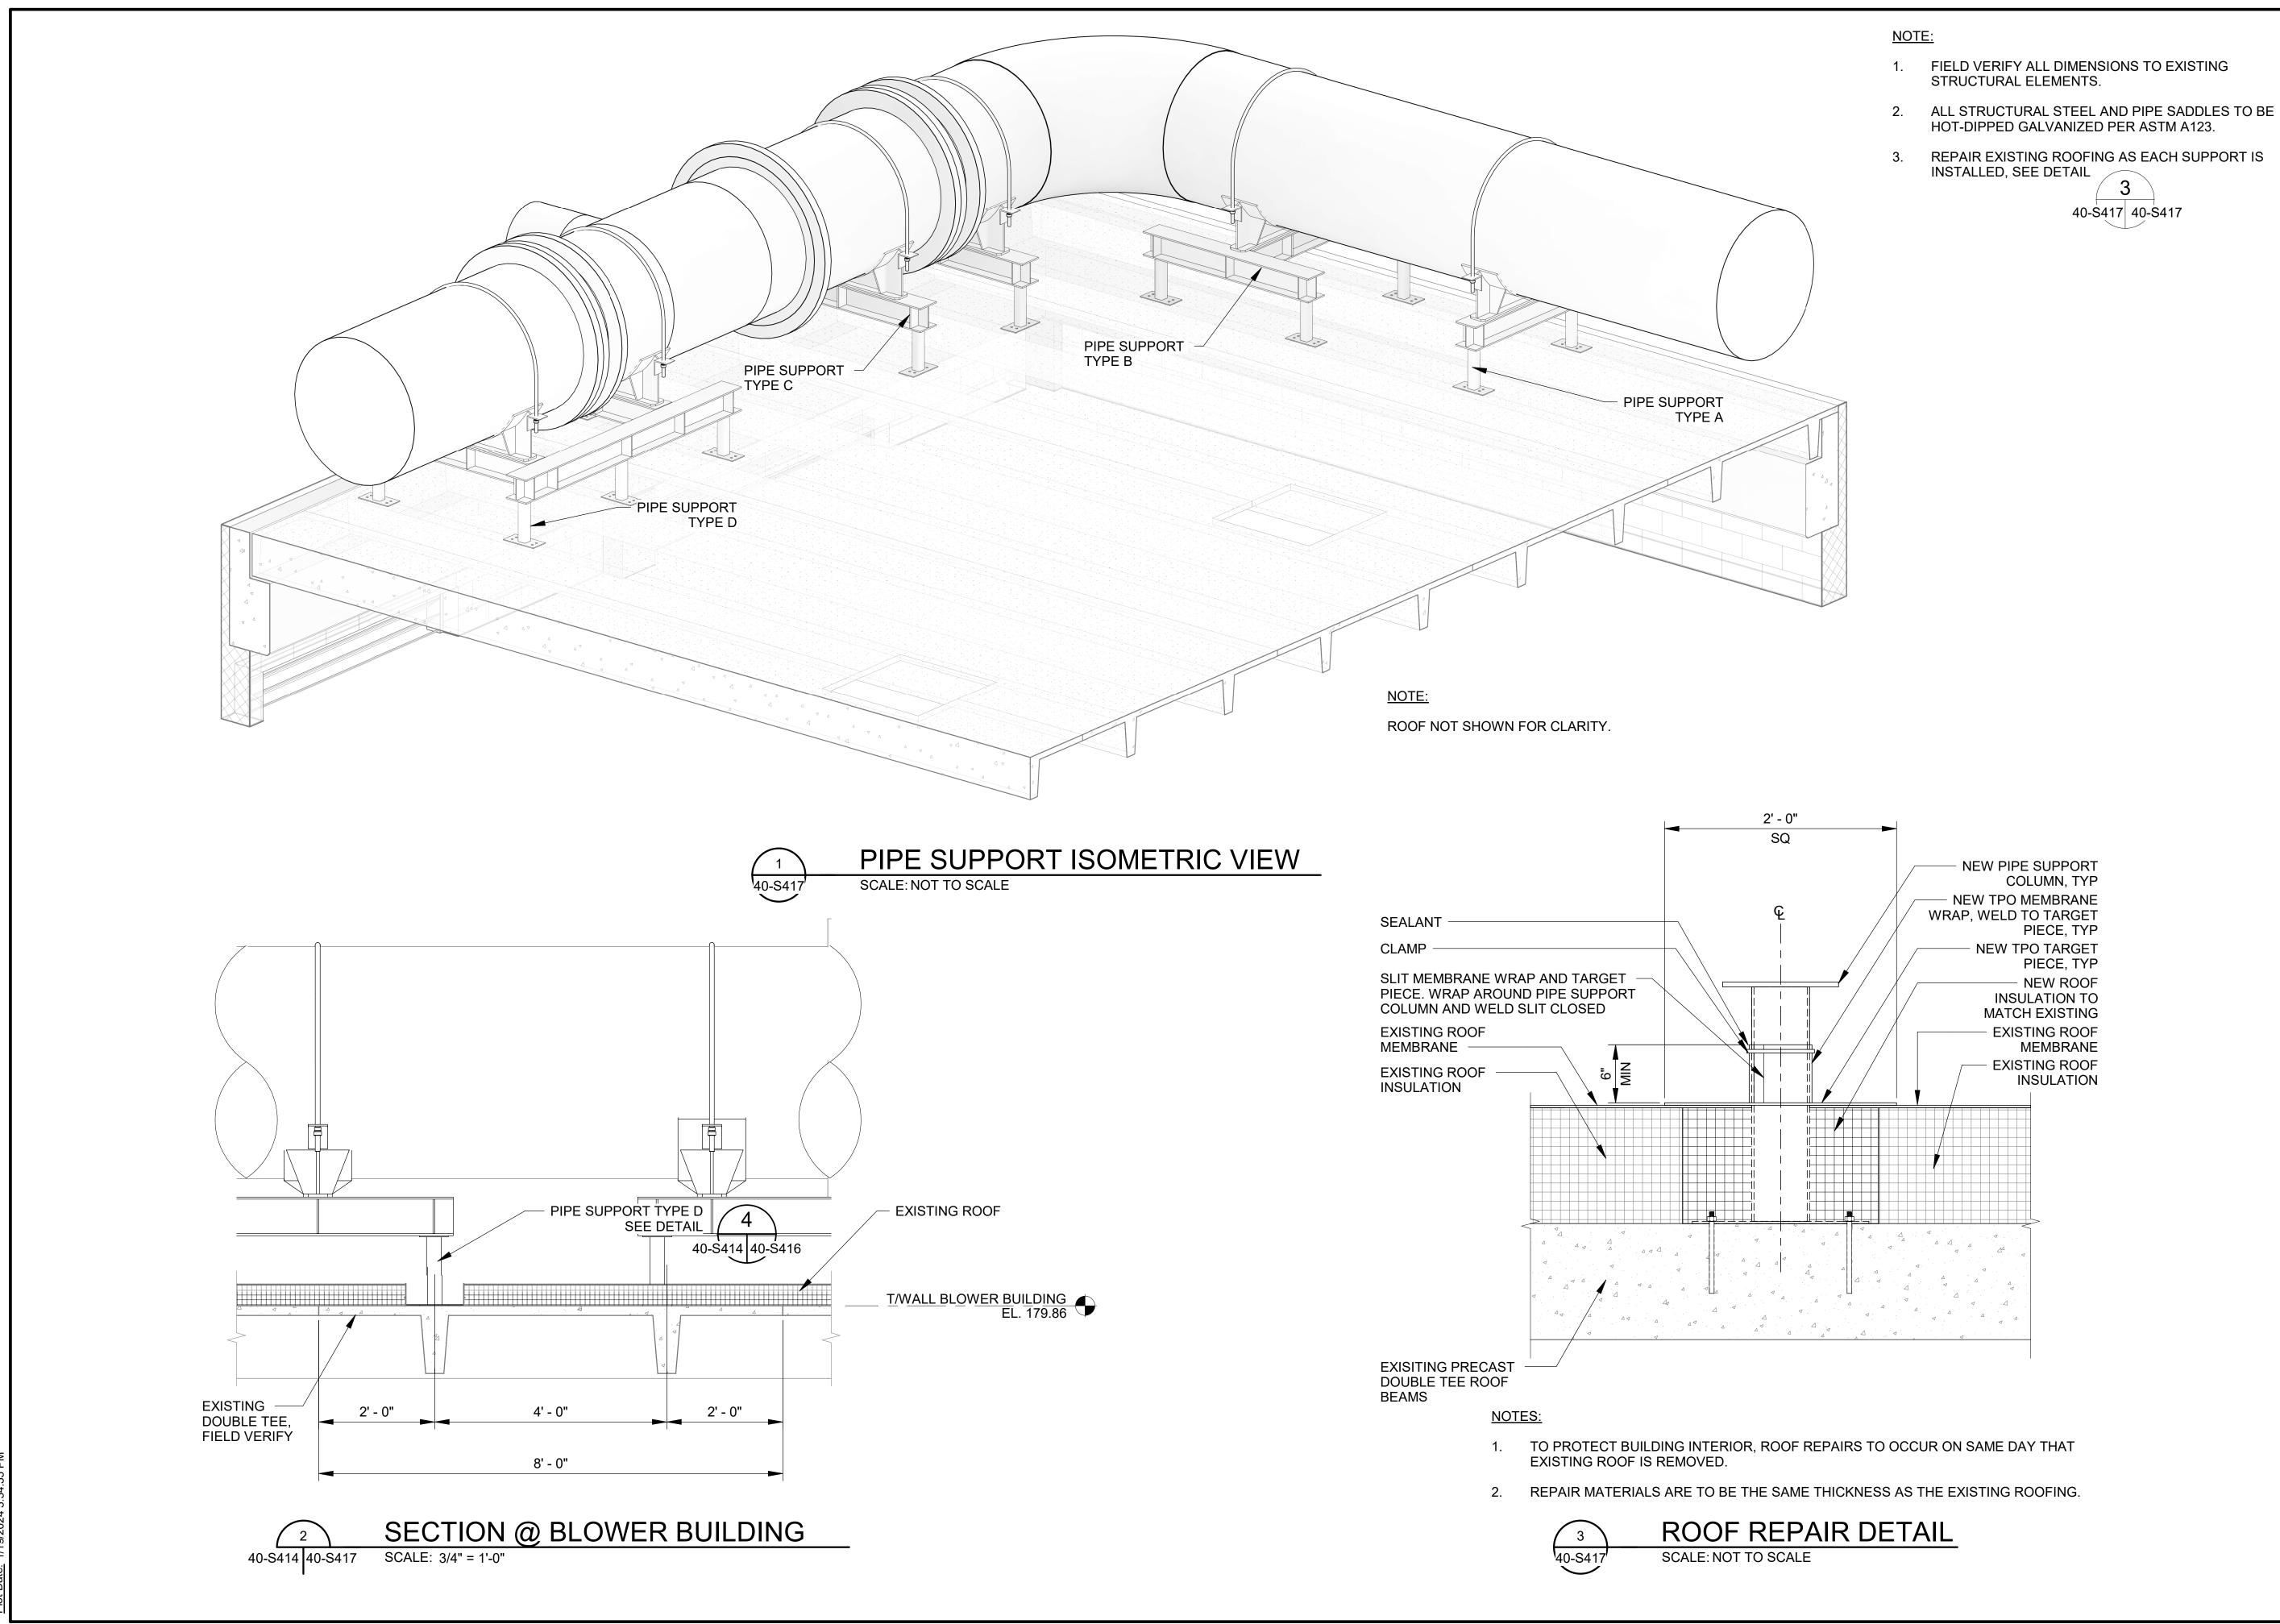
40-S413
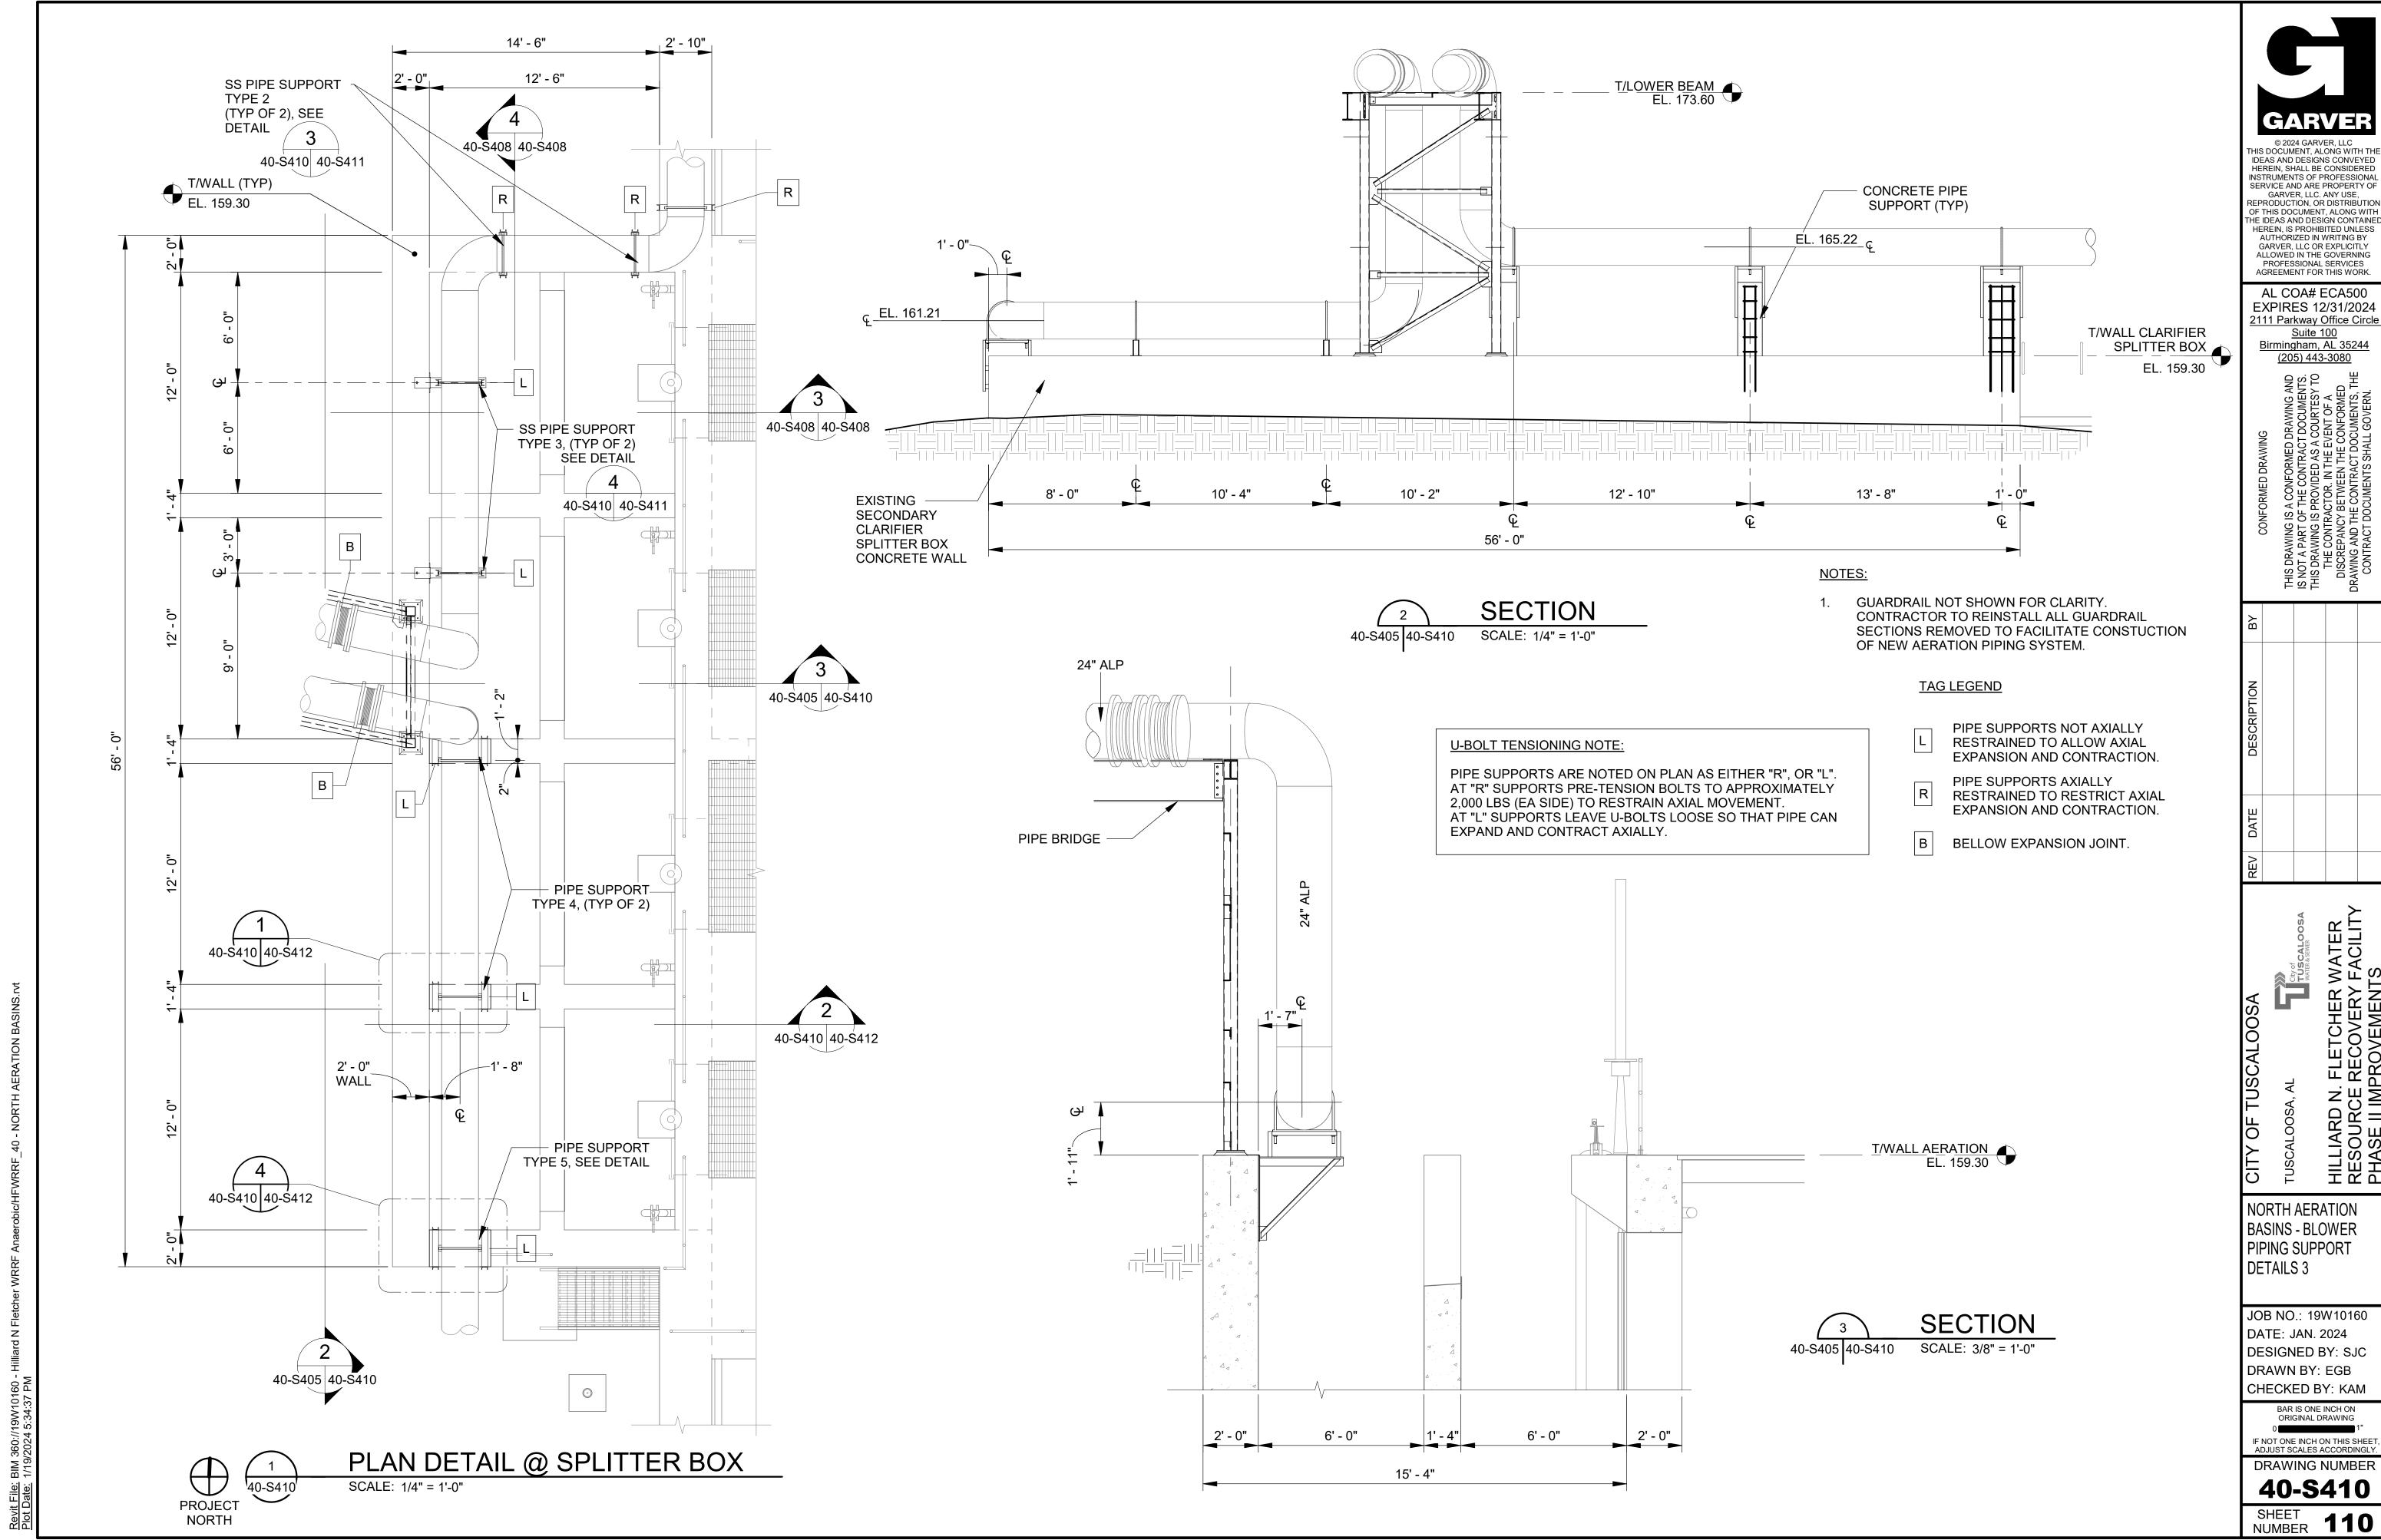
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OURCE RECOVERY FACILI

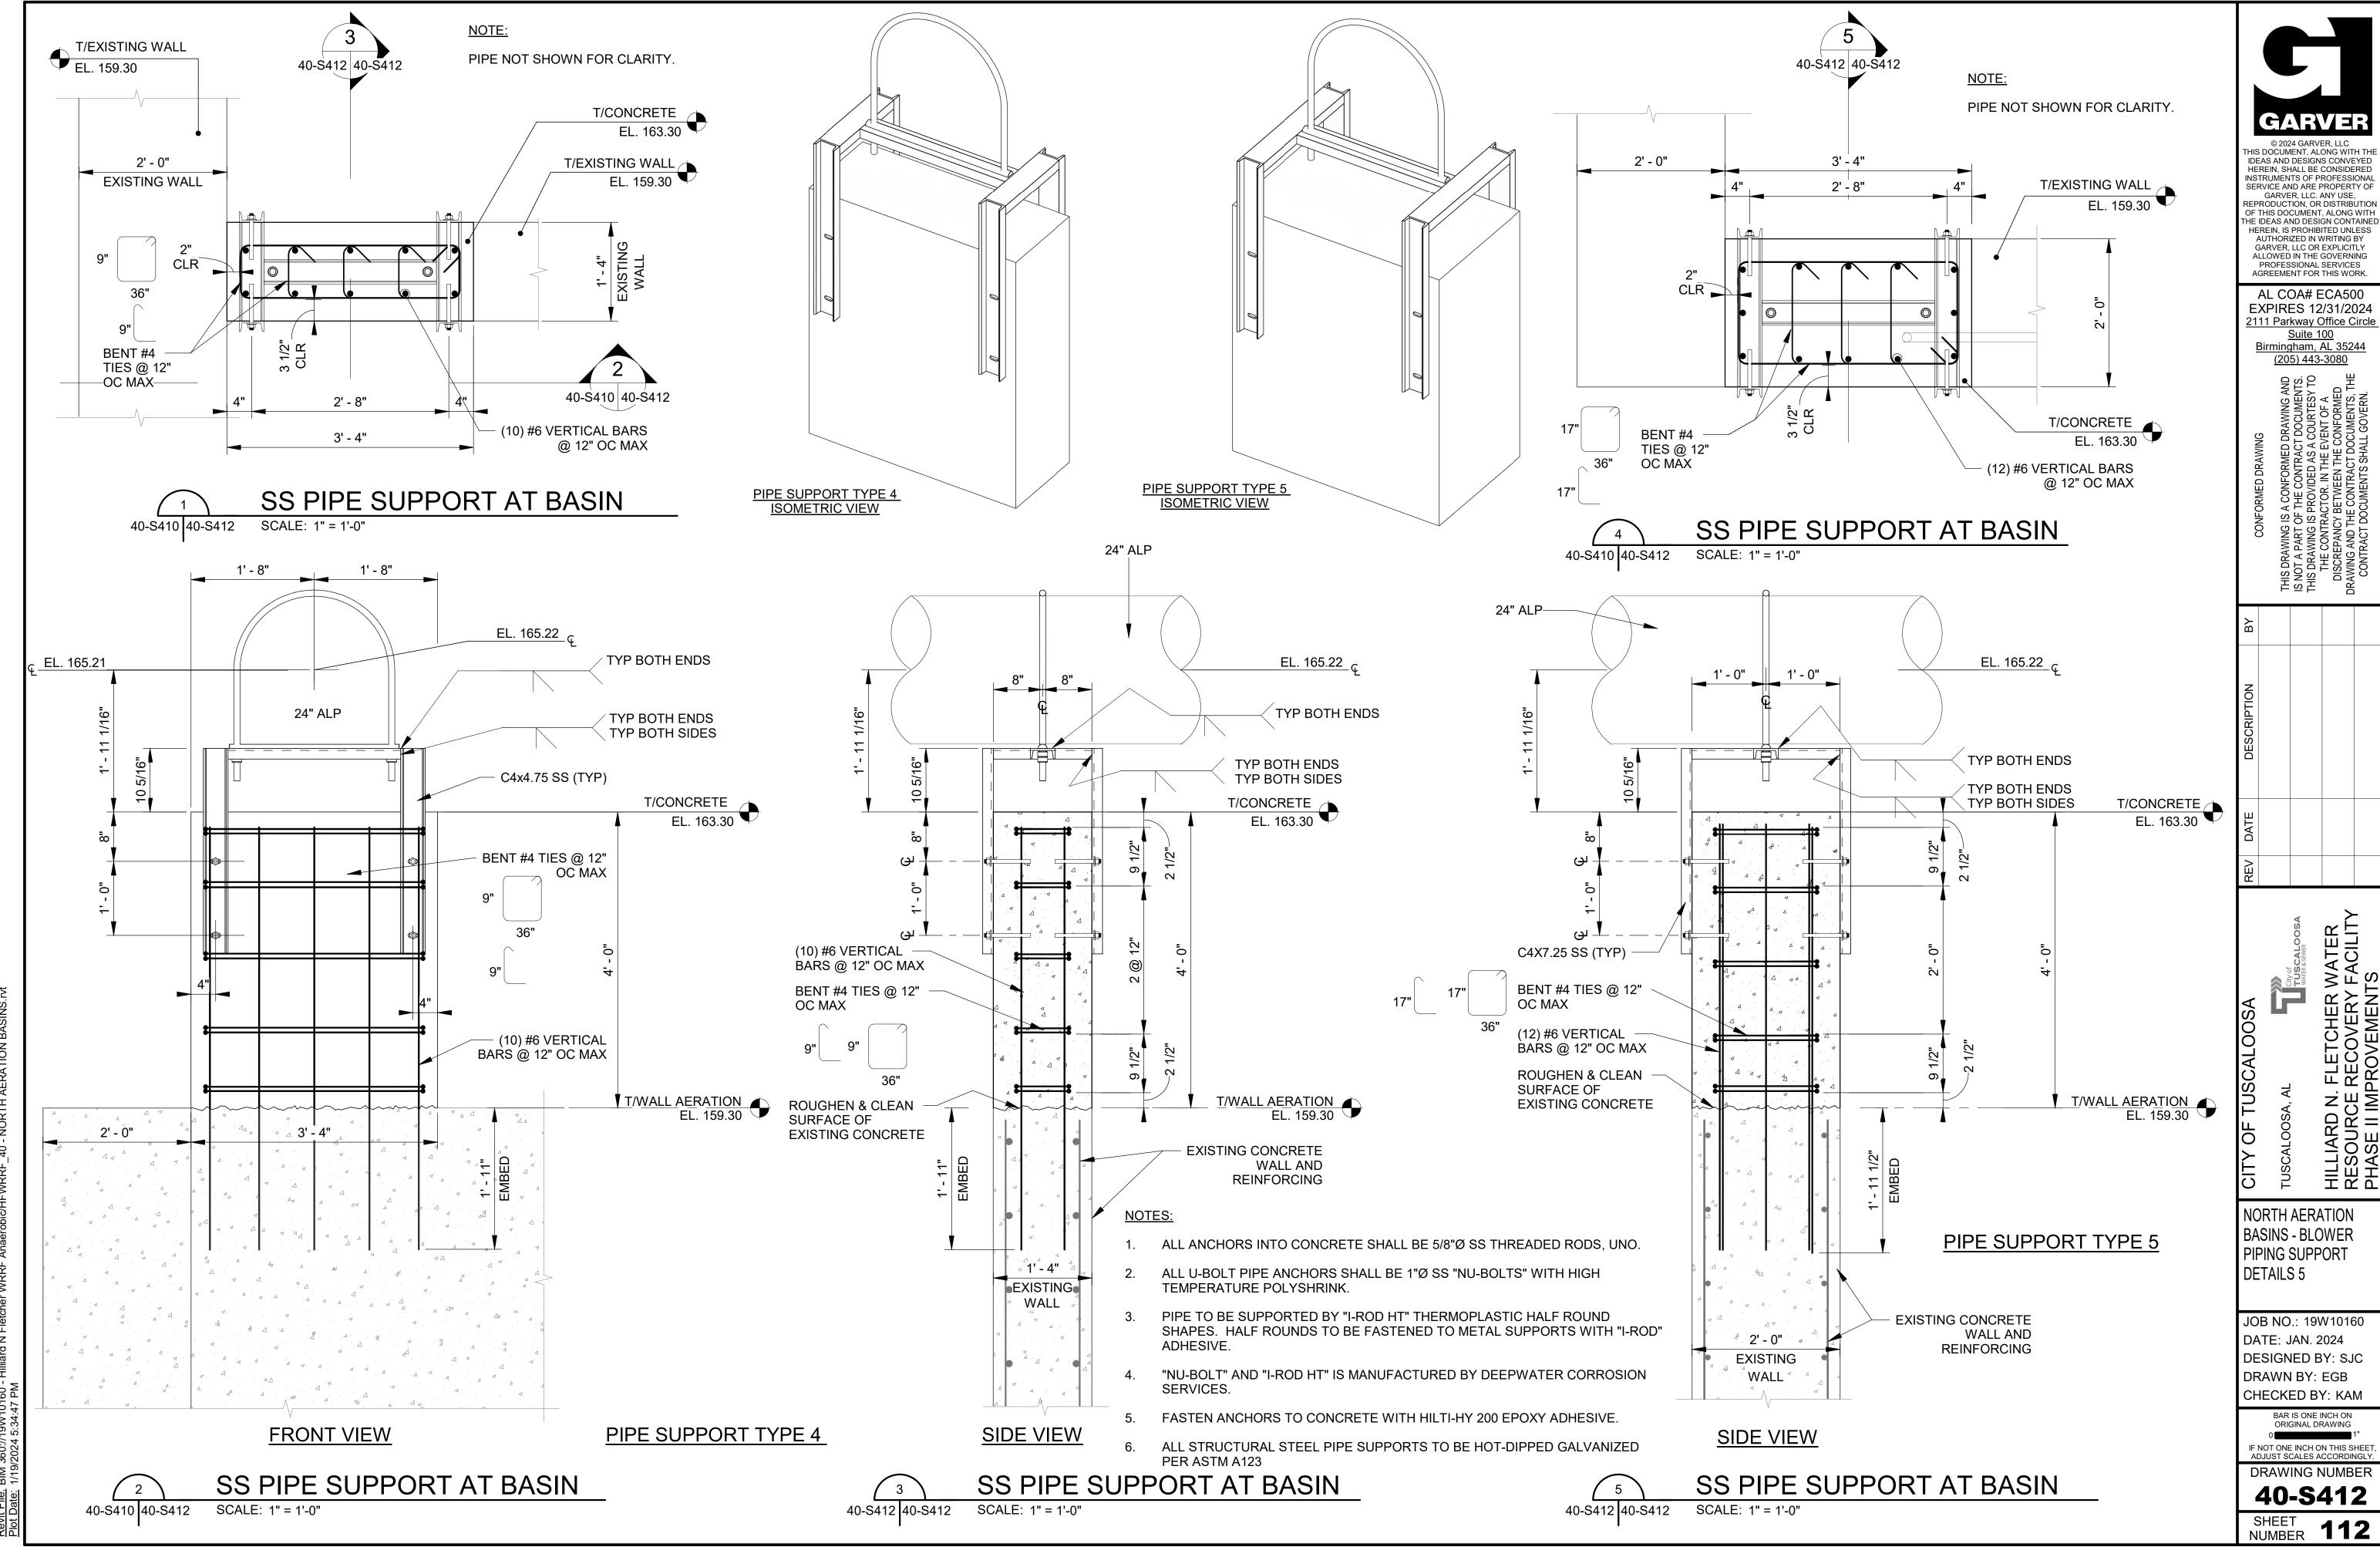NORTH AERATION BASINS - BLOWER BUILDING DETAILS 4

JOB NO.: 19W10160 DATE: JAN. 2024 DESIGNED BY: KAM DRAWN BY: EGB CHECKED BY: KAM


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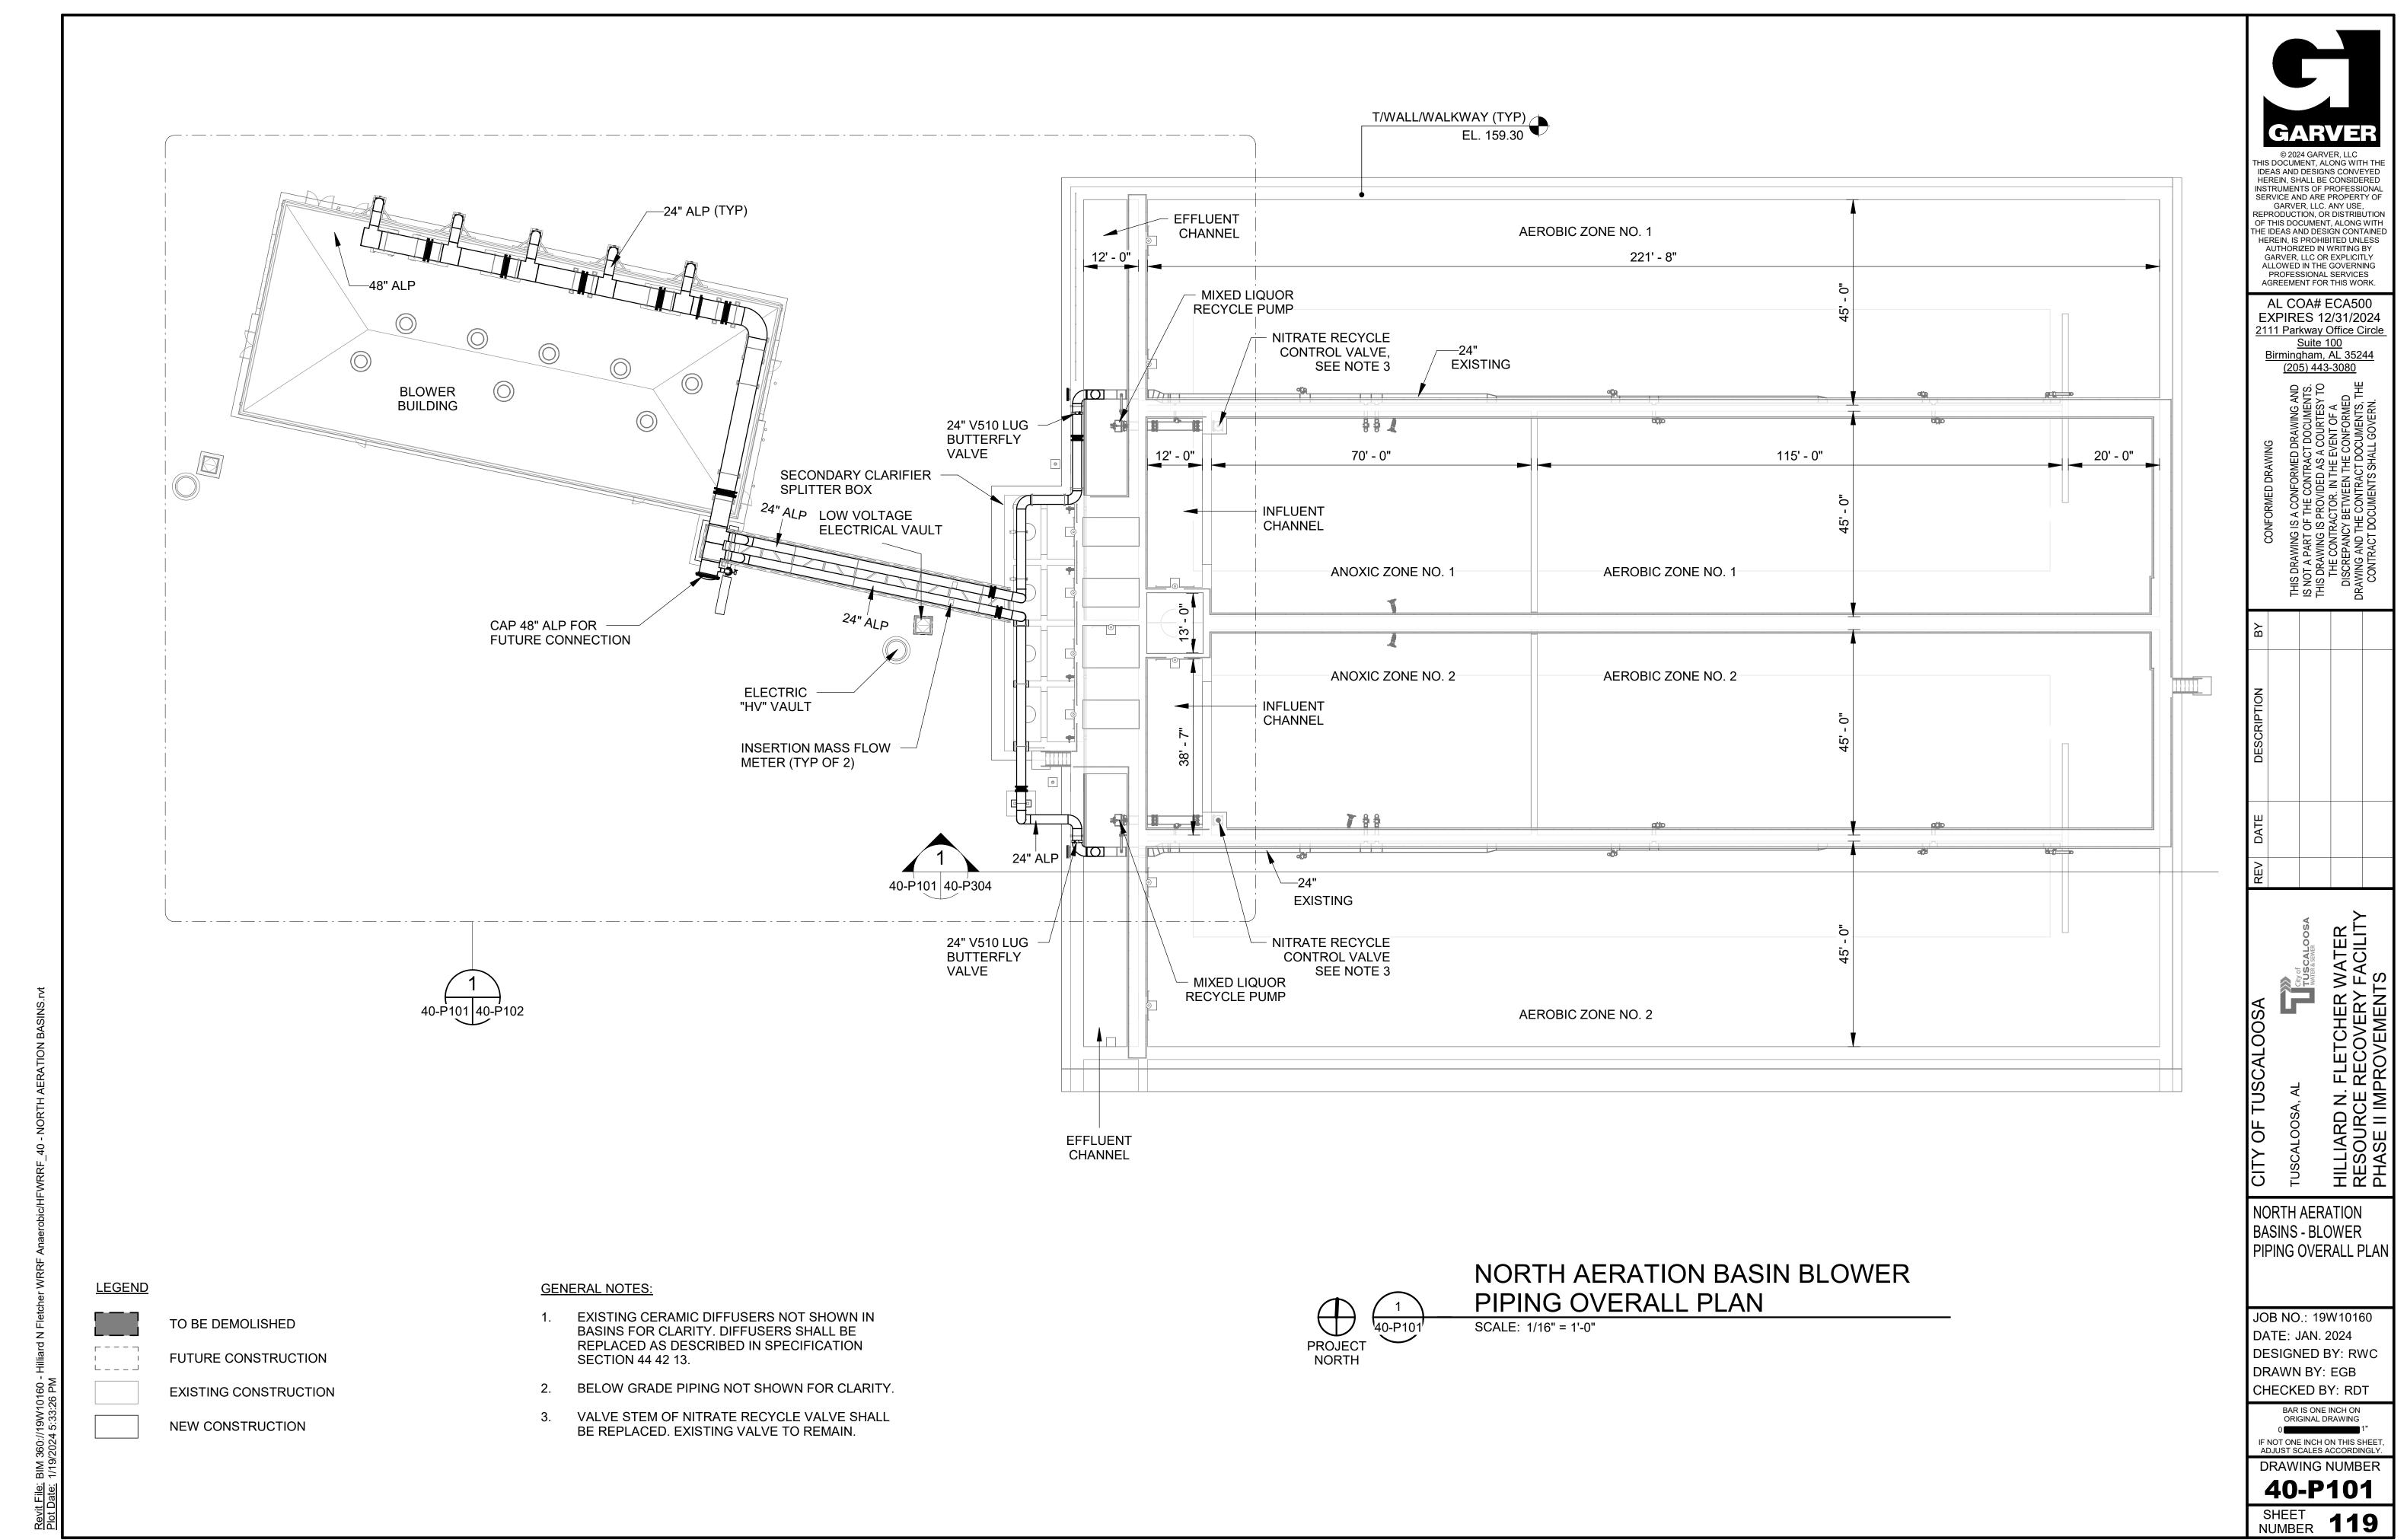
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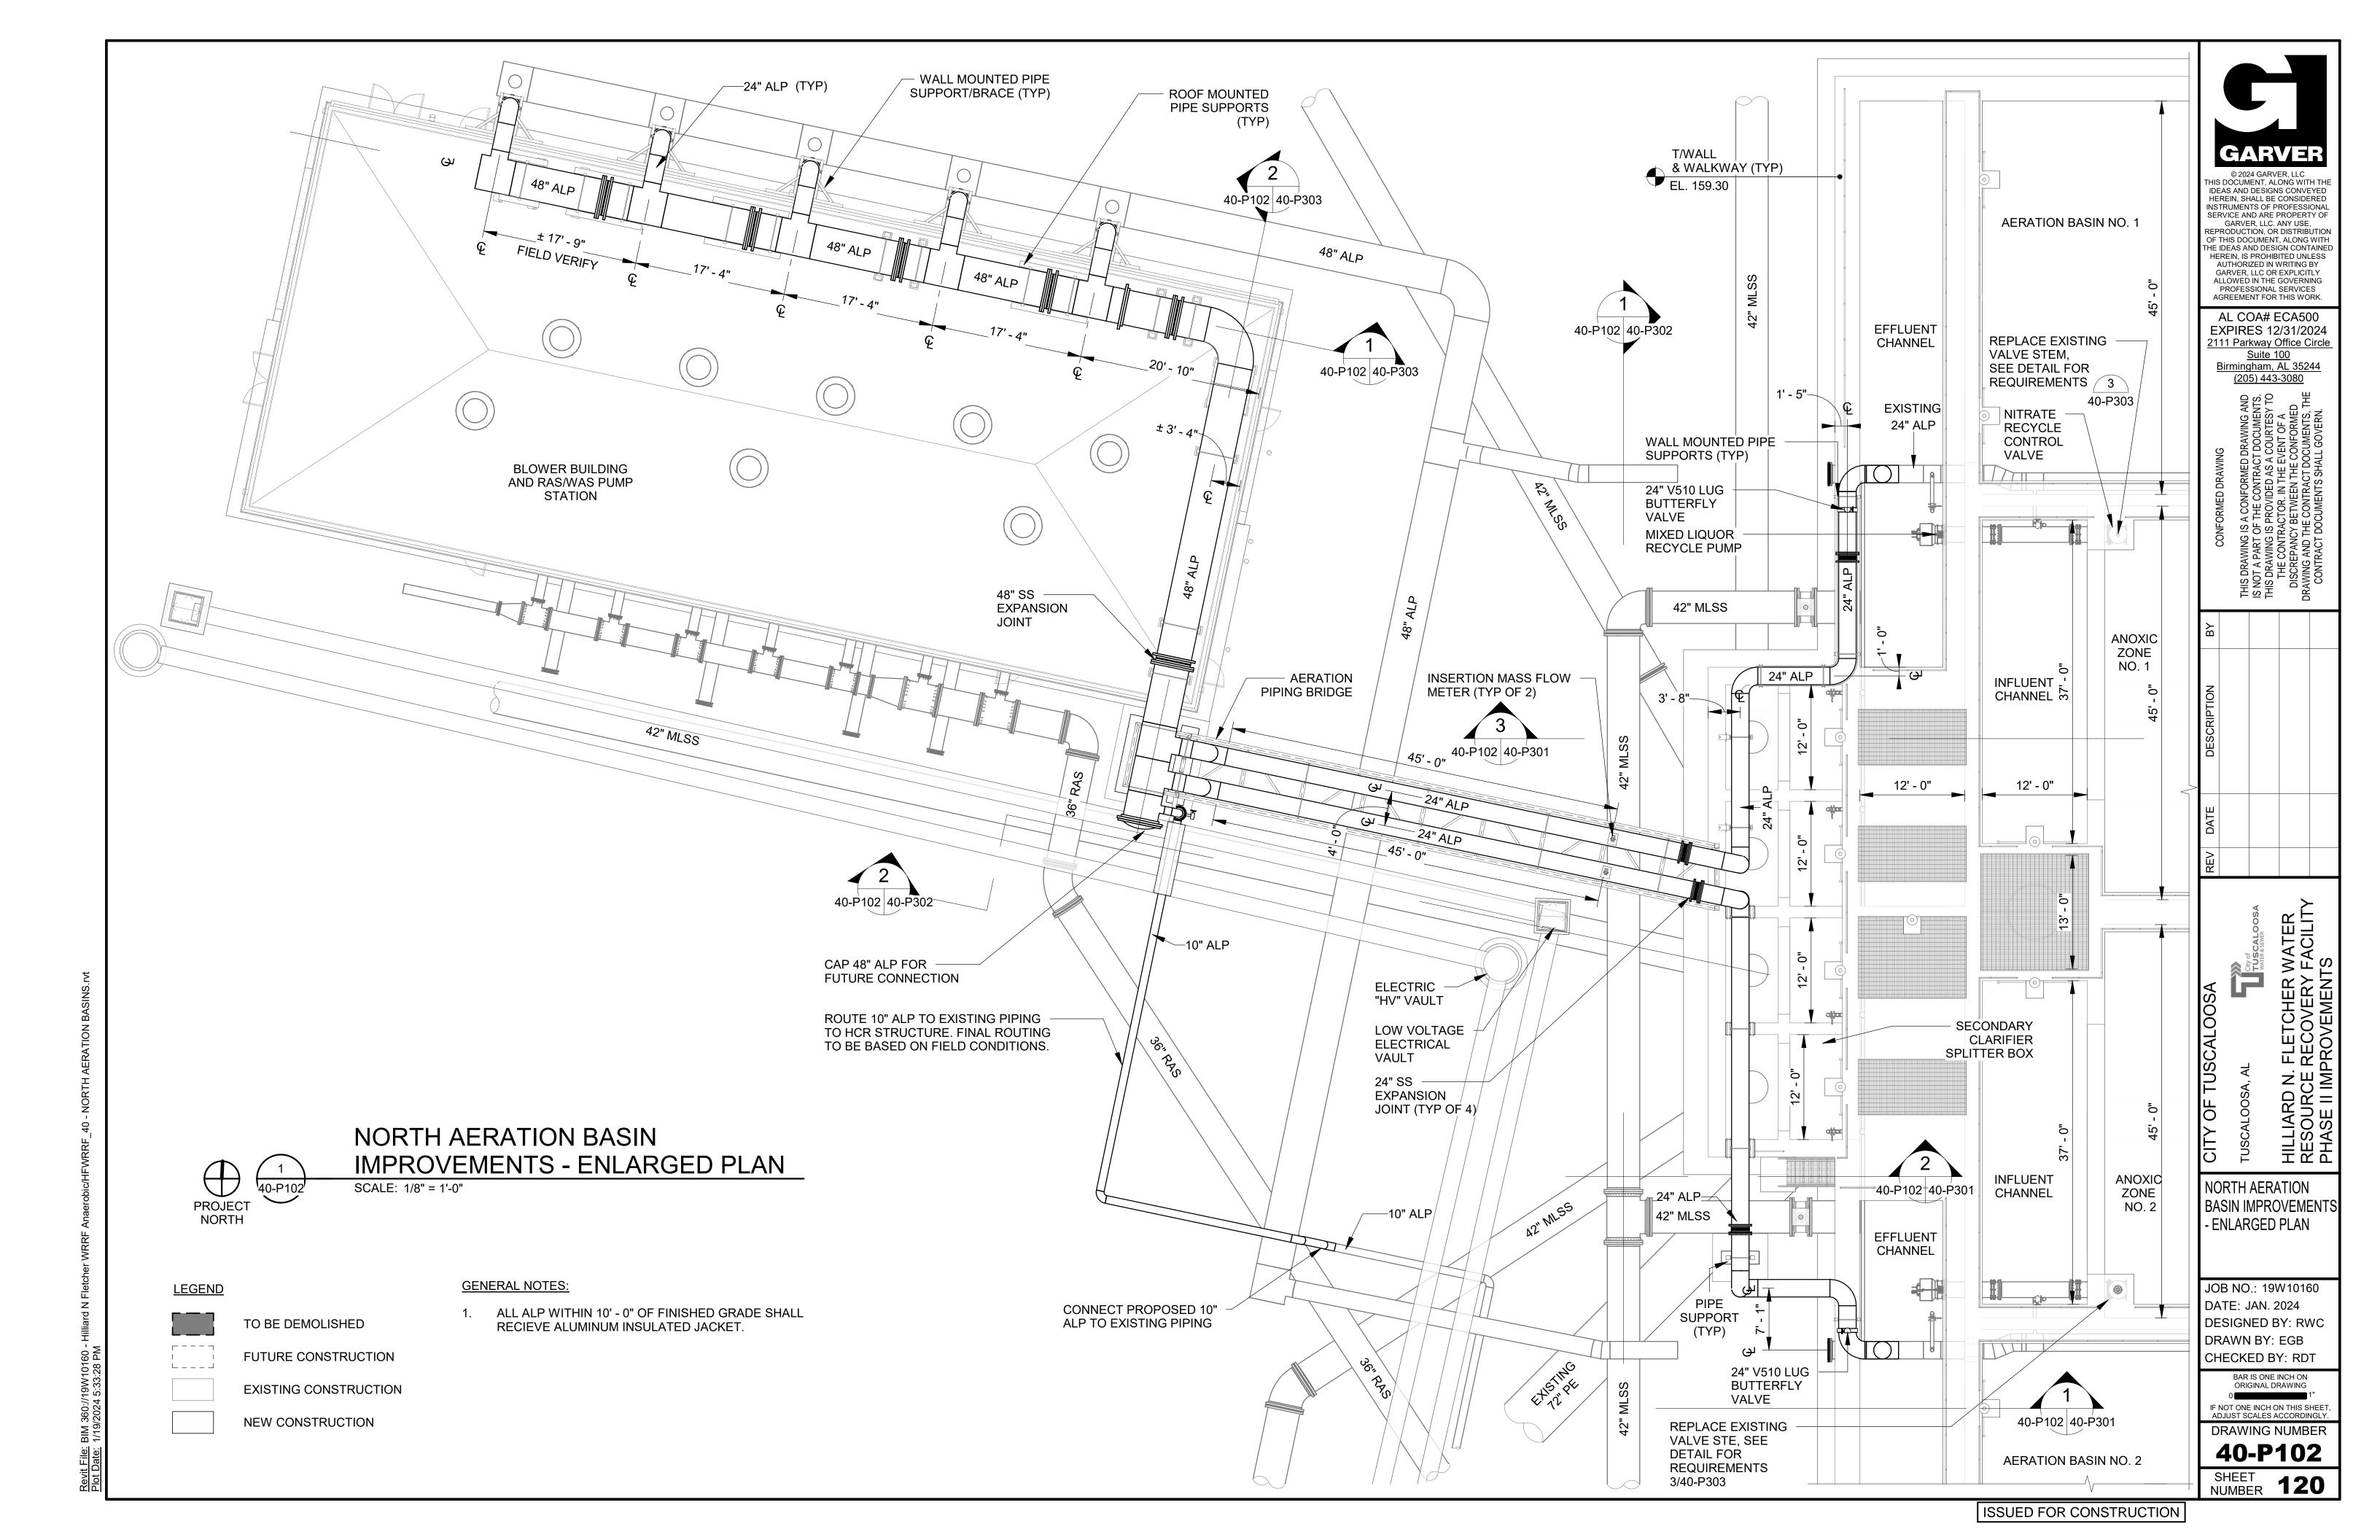
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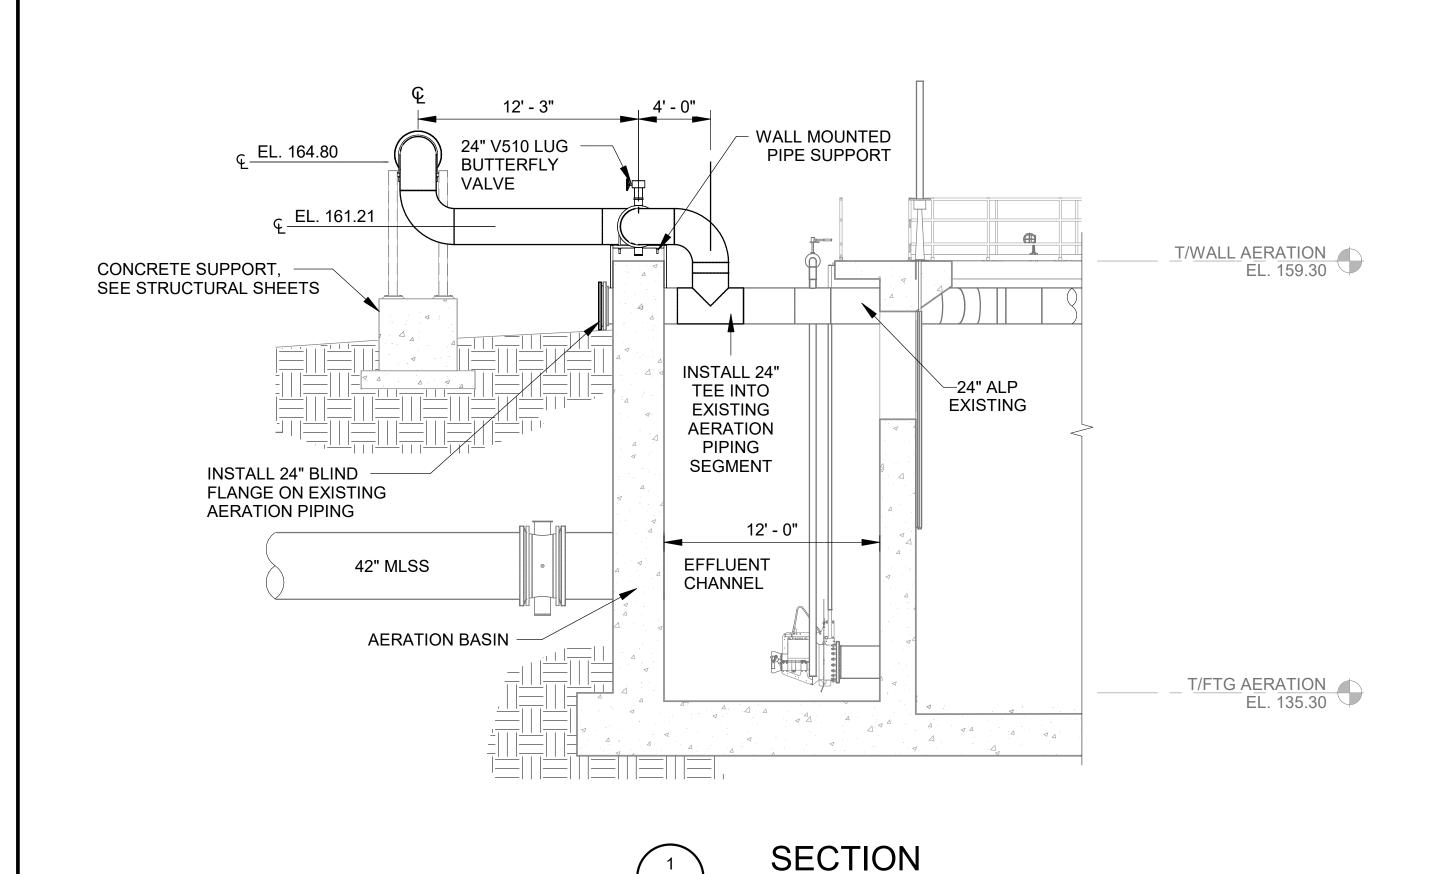
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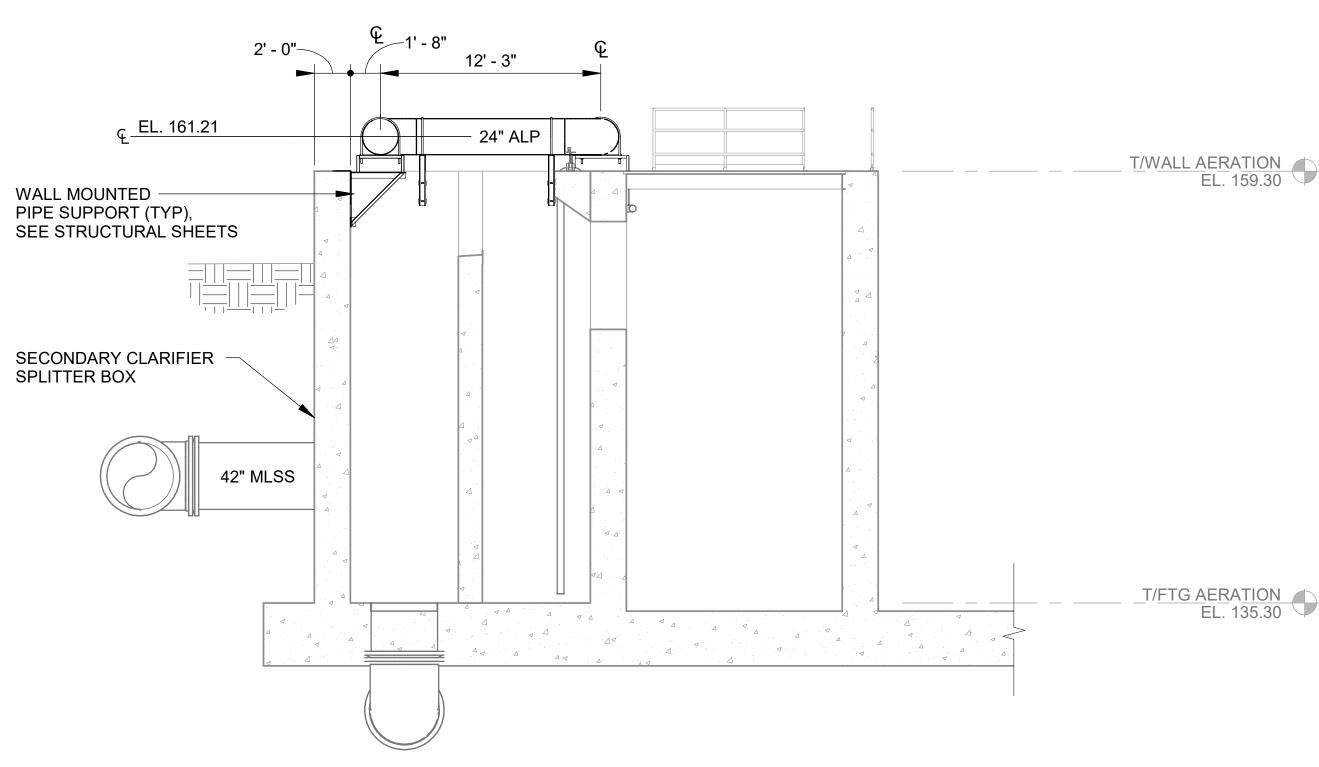
DRAWING NUMBER 40-S417

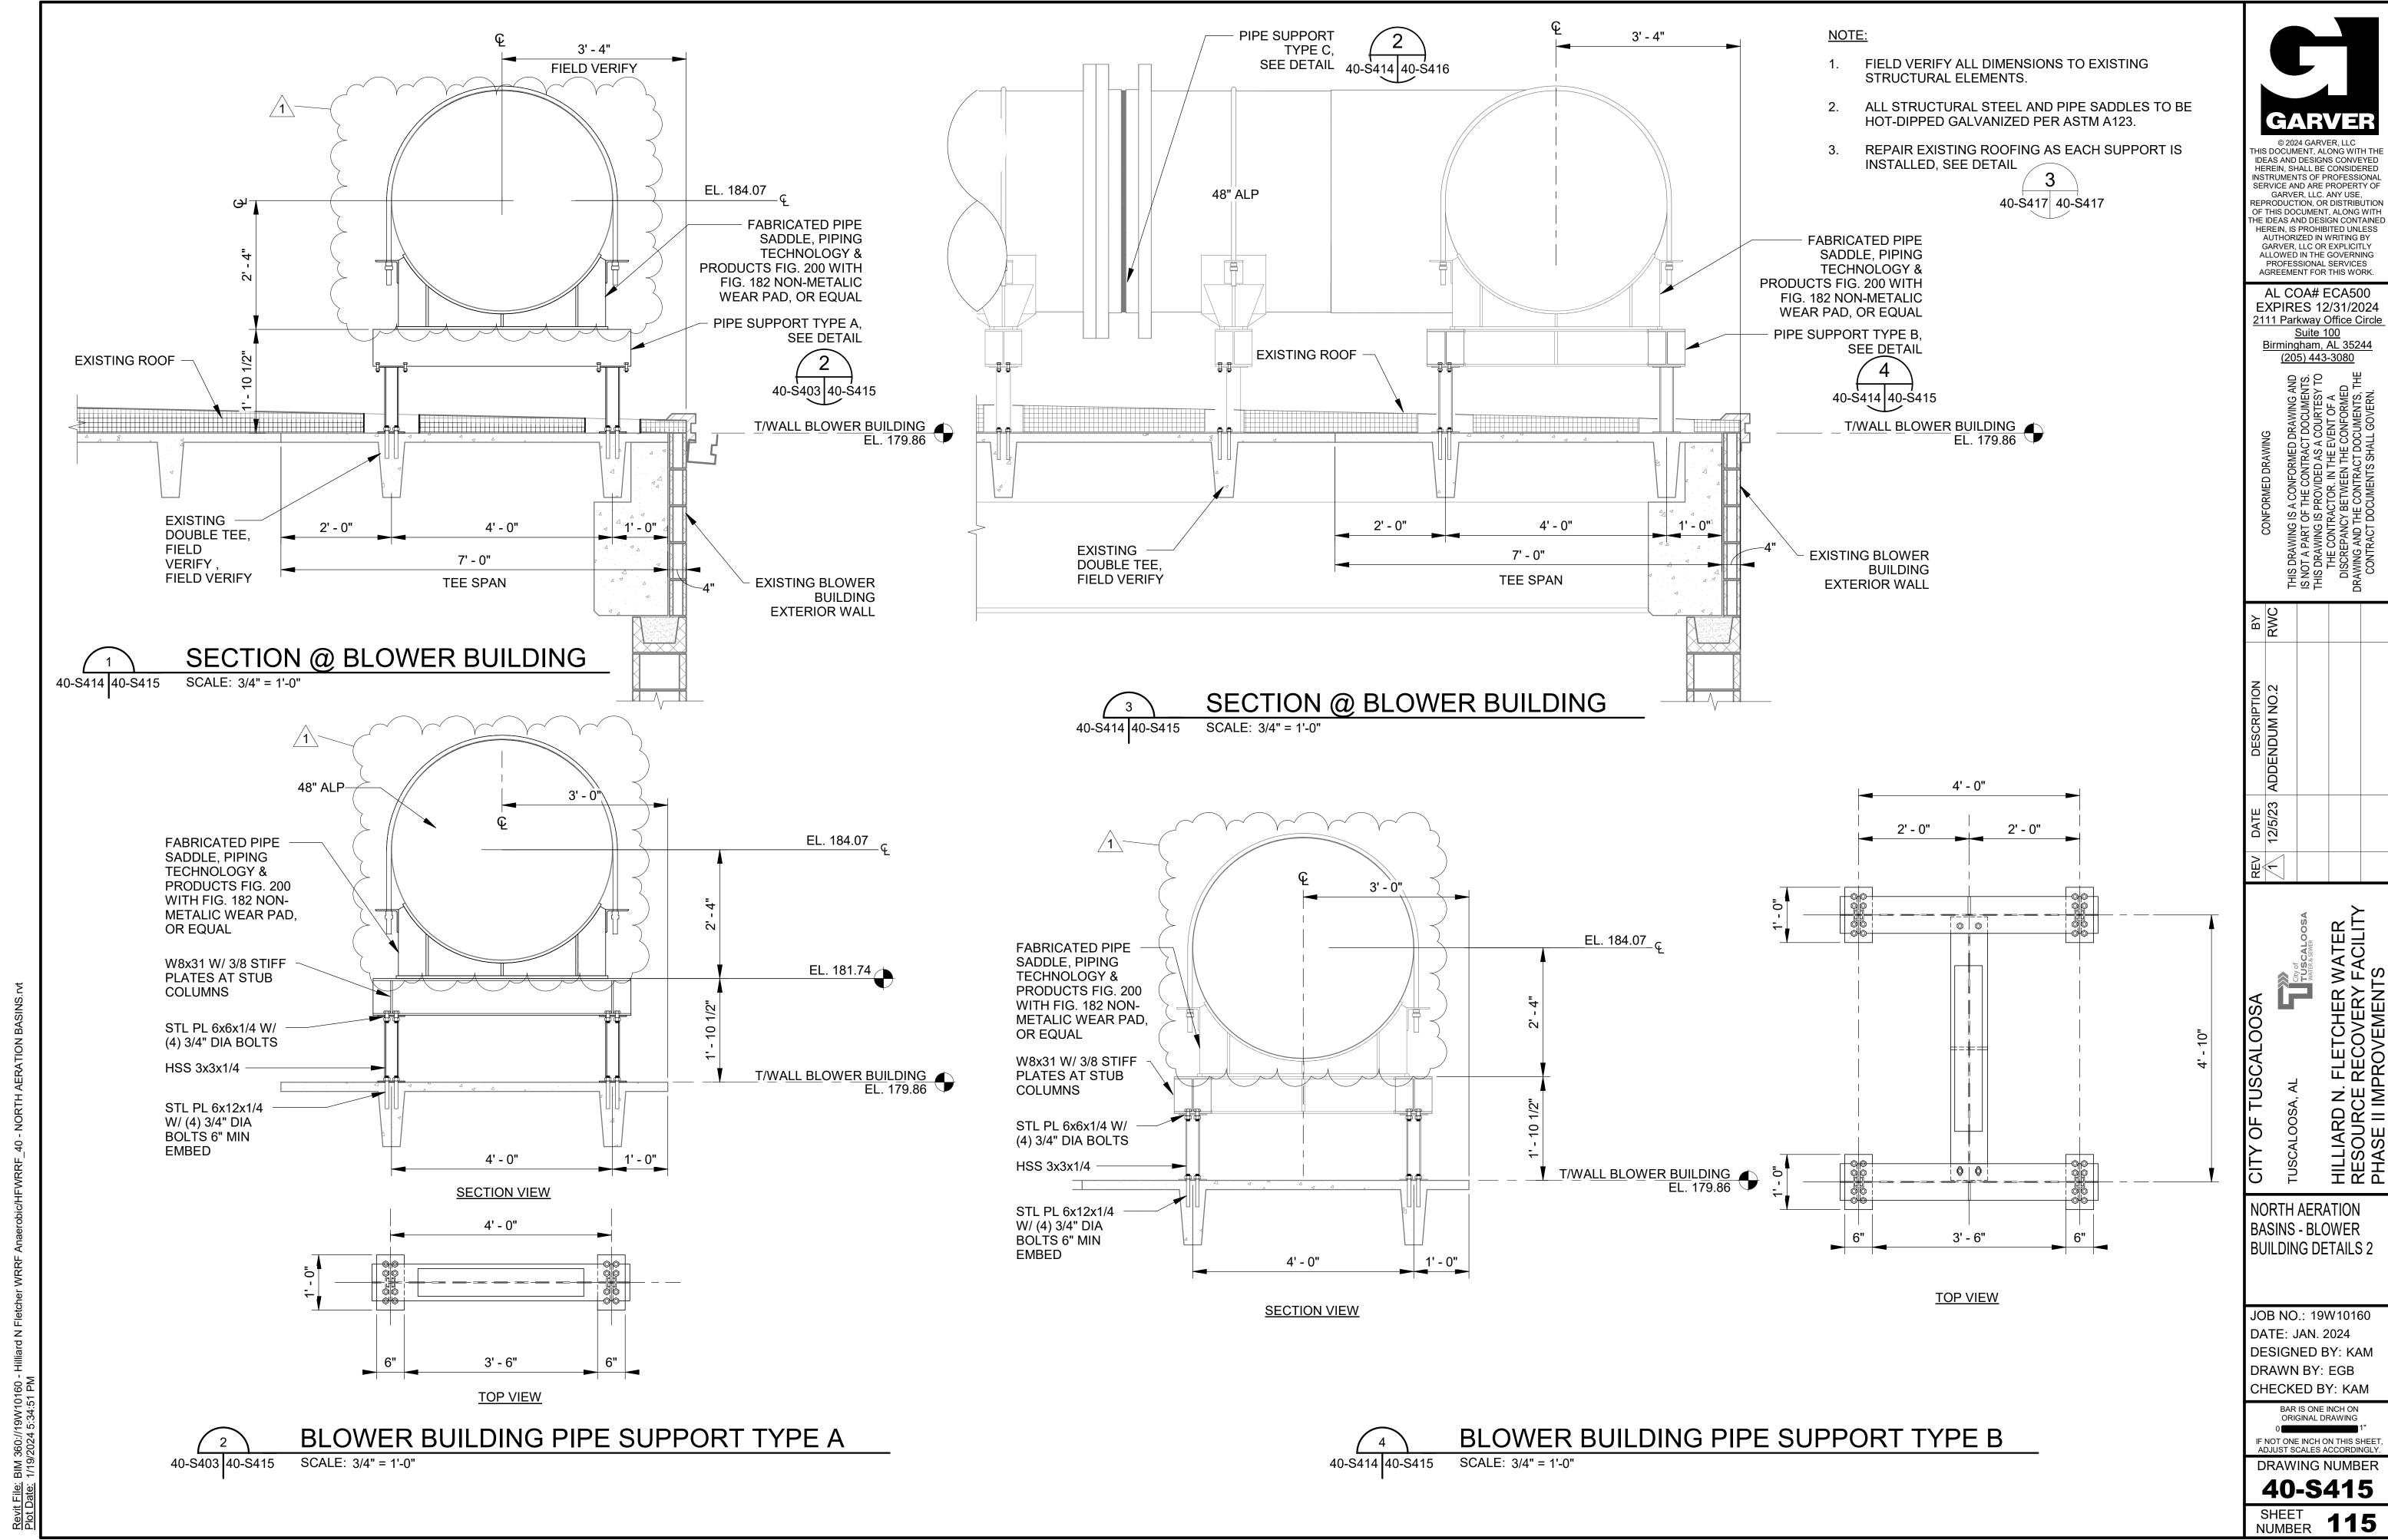








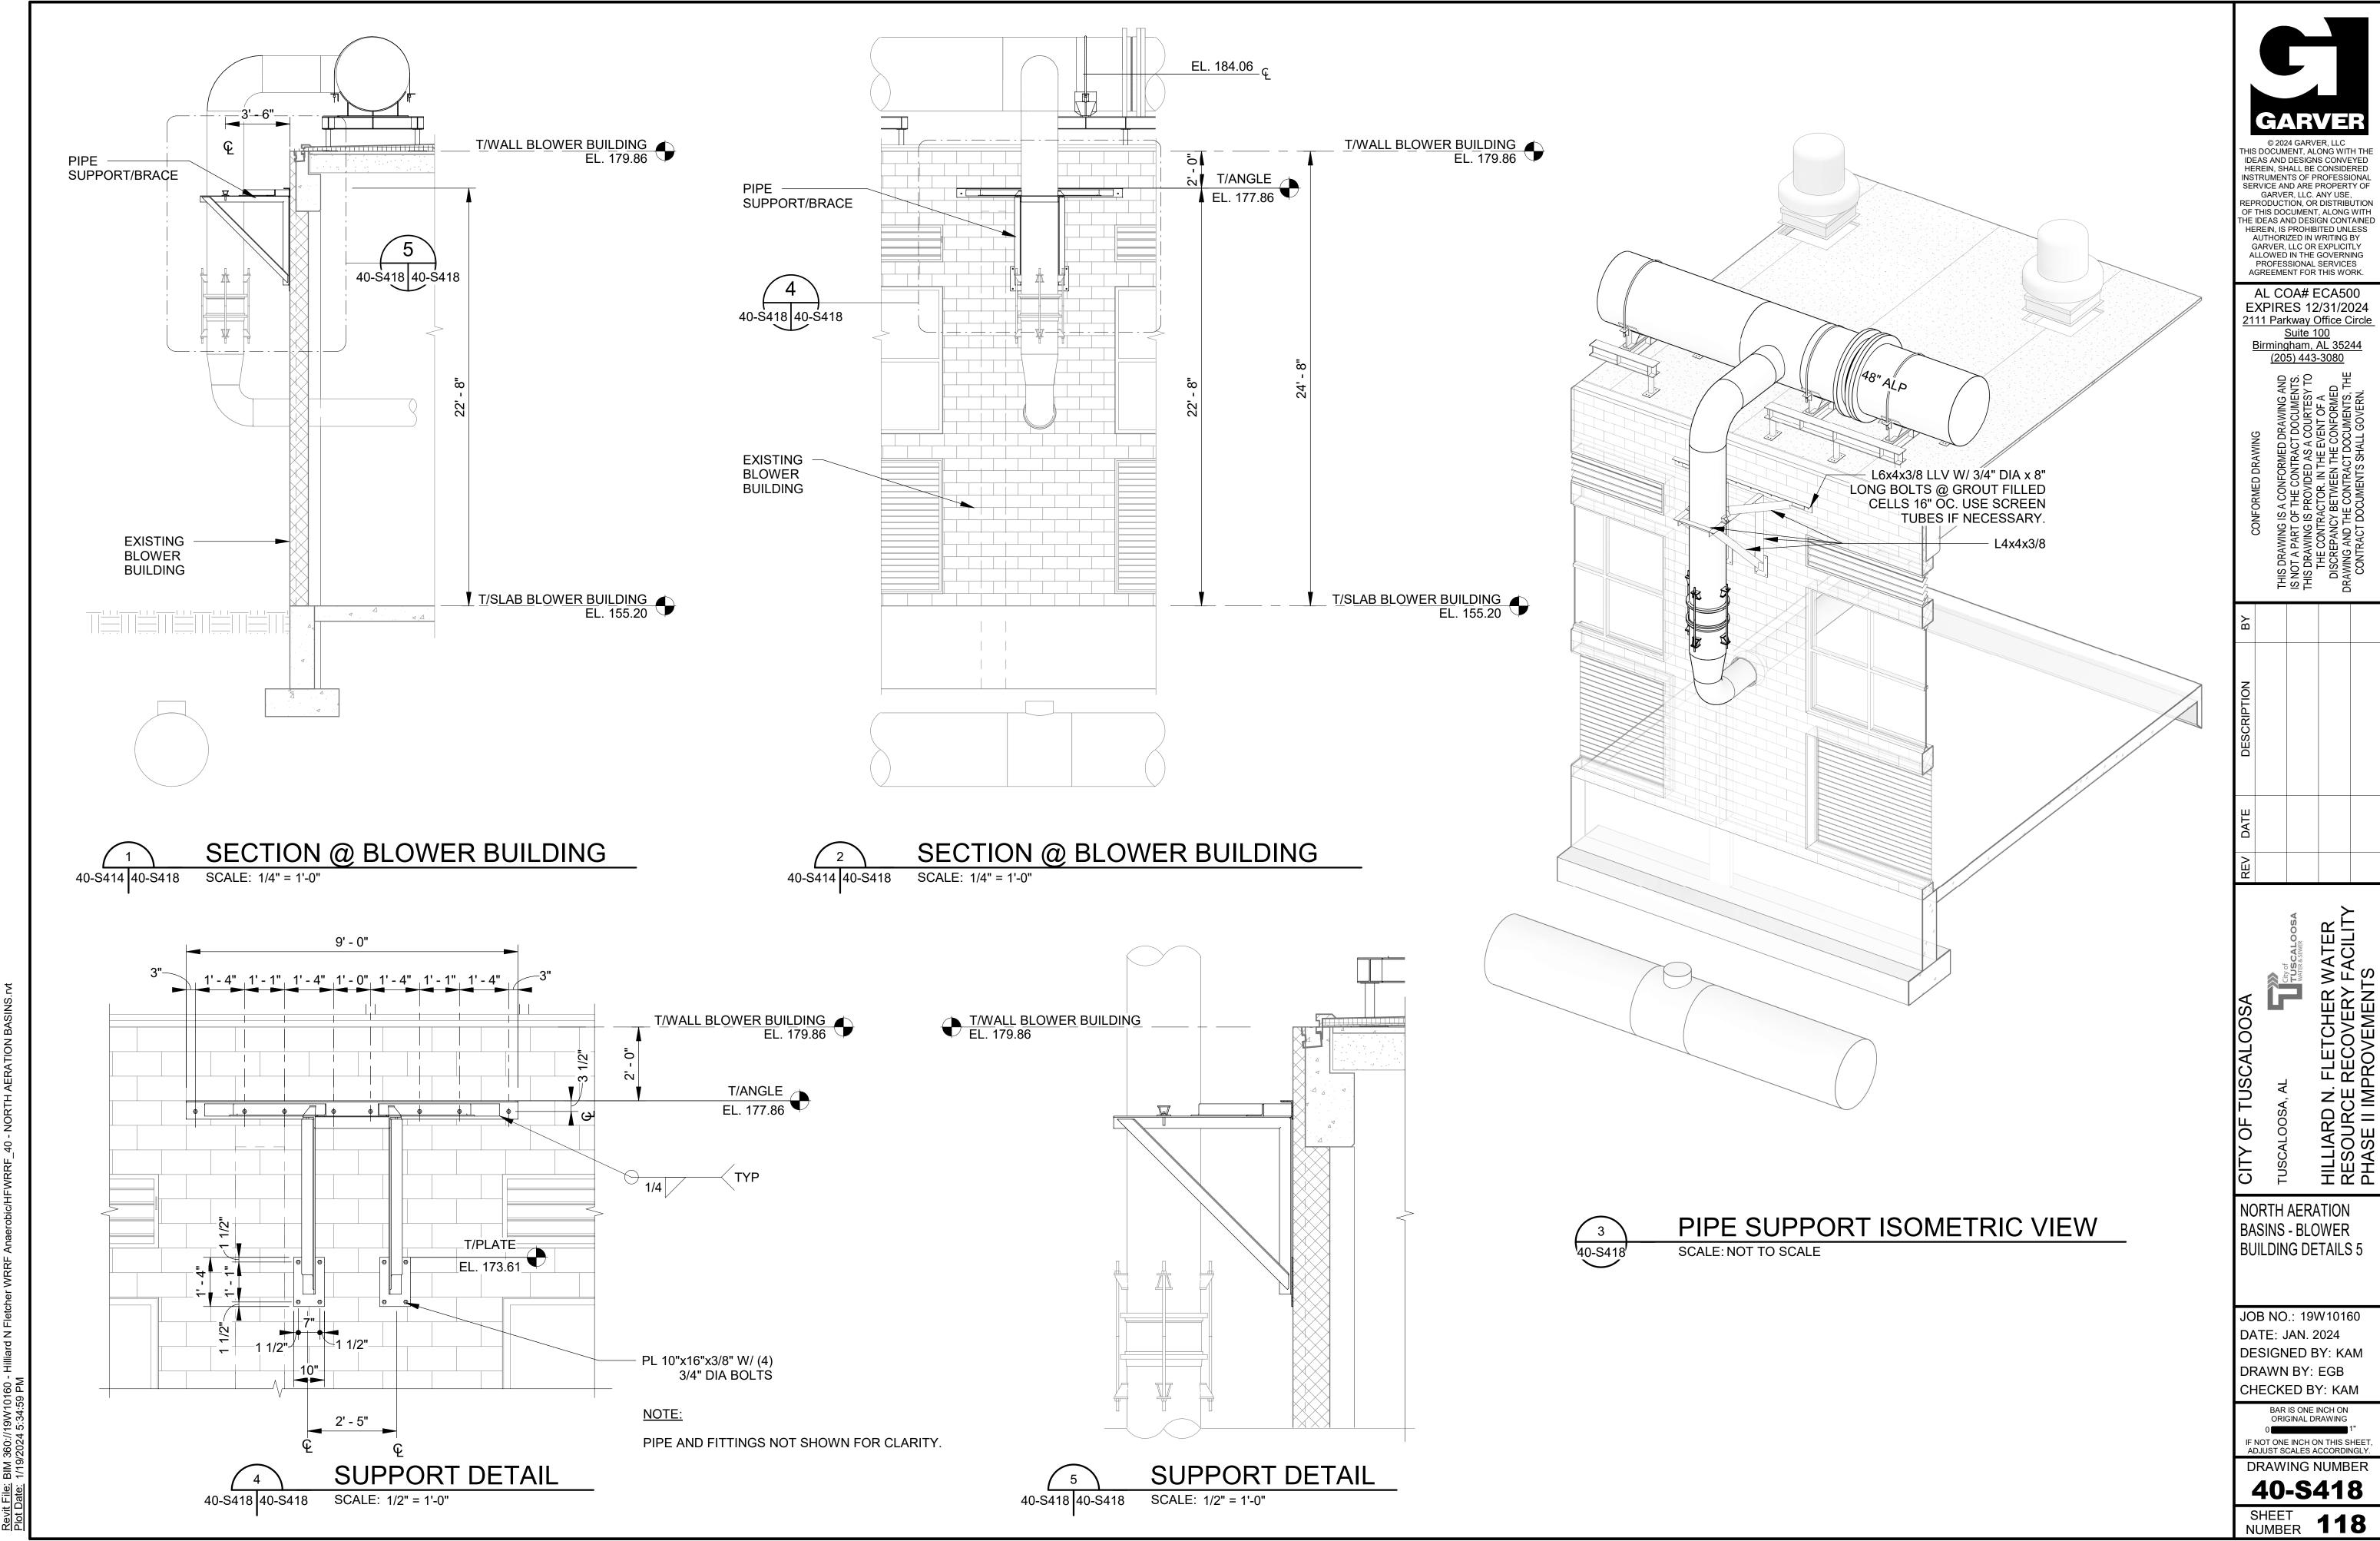

SECTION

SCALE: 3/16" = 1'-0"

SCALE: 3/16" = 1'-0"

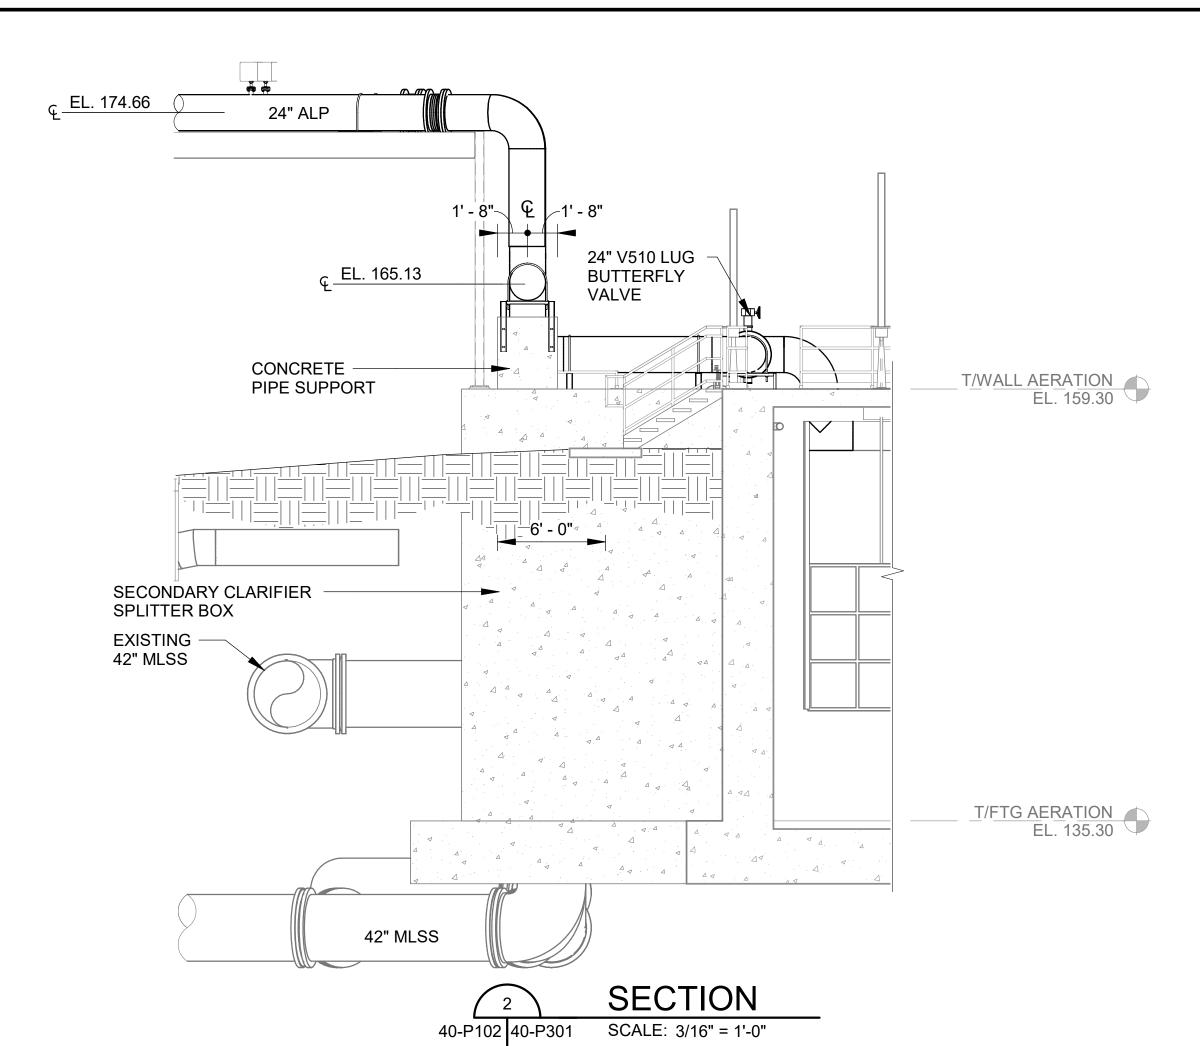




NORTH AERATION BASINS - BLOWER PIPING SECTIONS AND DETAILS 1

JOB NO.: 19W10160 DATE: JAN. 2024 DESIGNED BY: RWC DRAWN BY: EGB CHECKED BY: RDT


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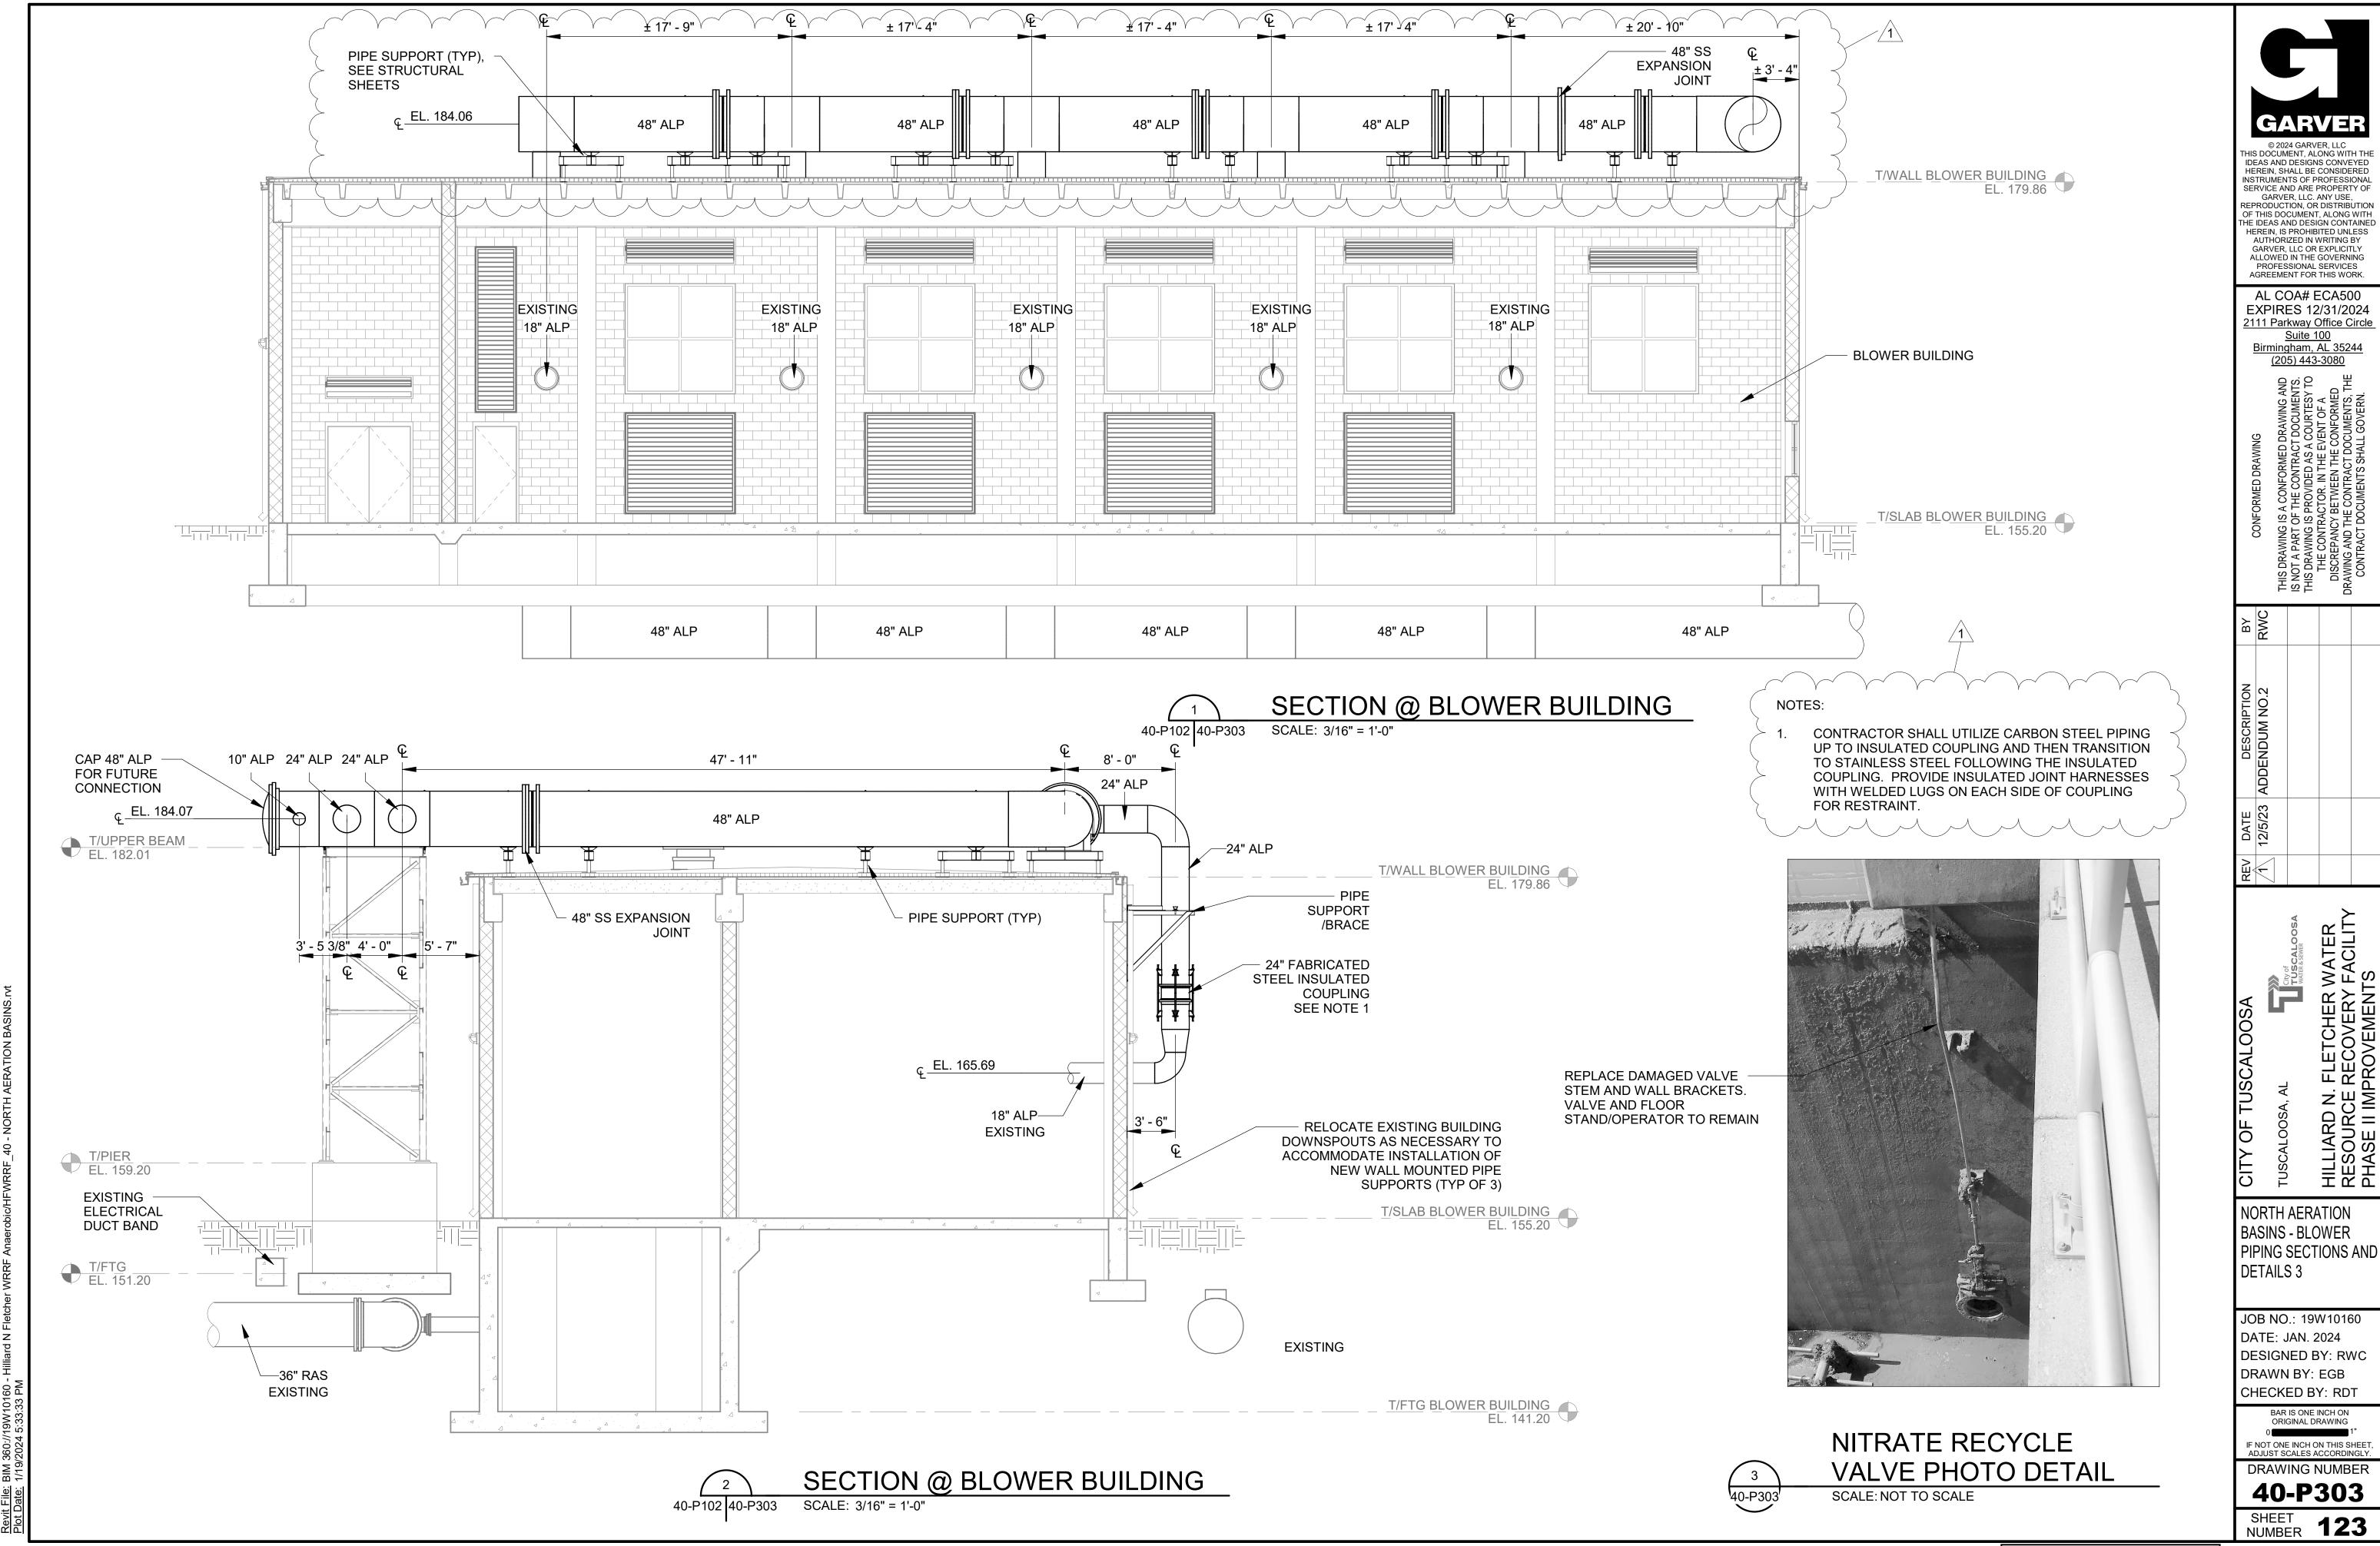
> 40-P301 SHEET 121




40-P102 40-P301

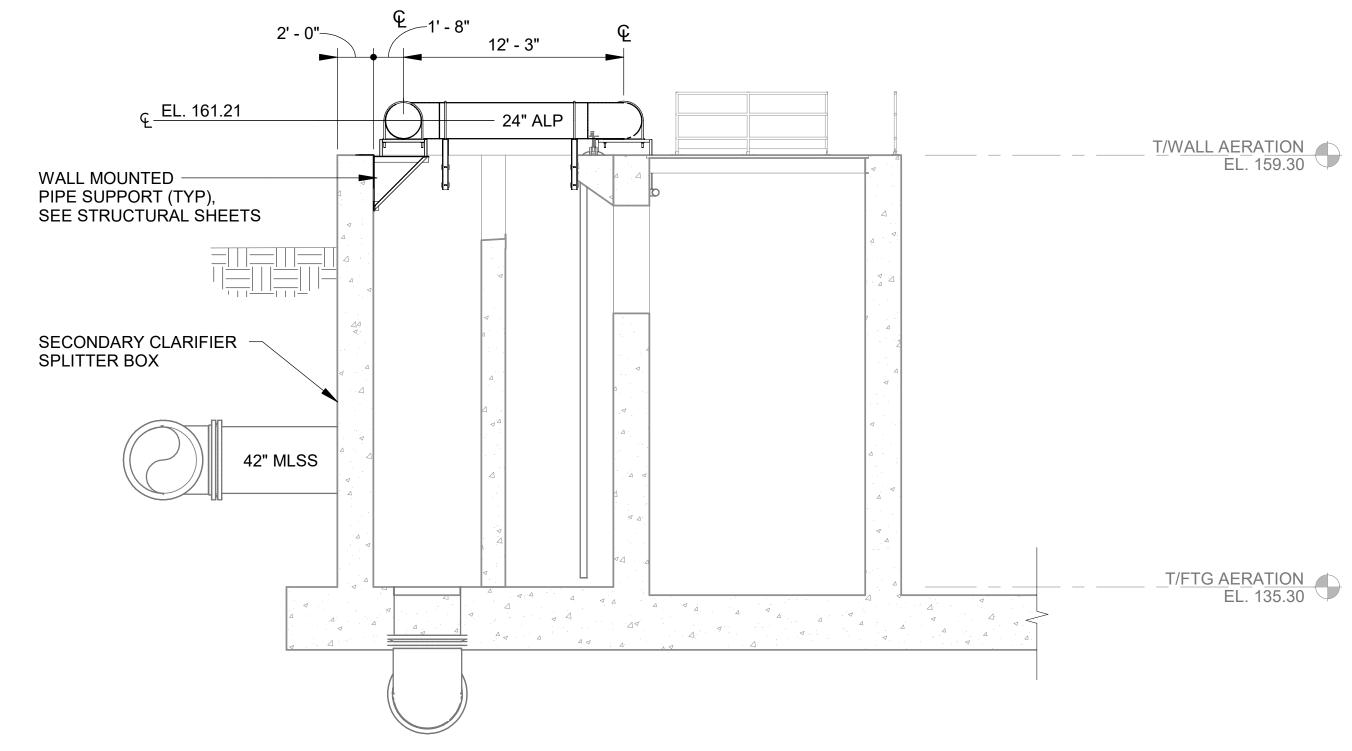

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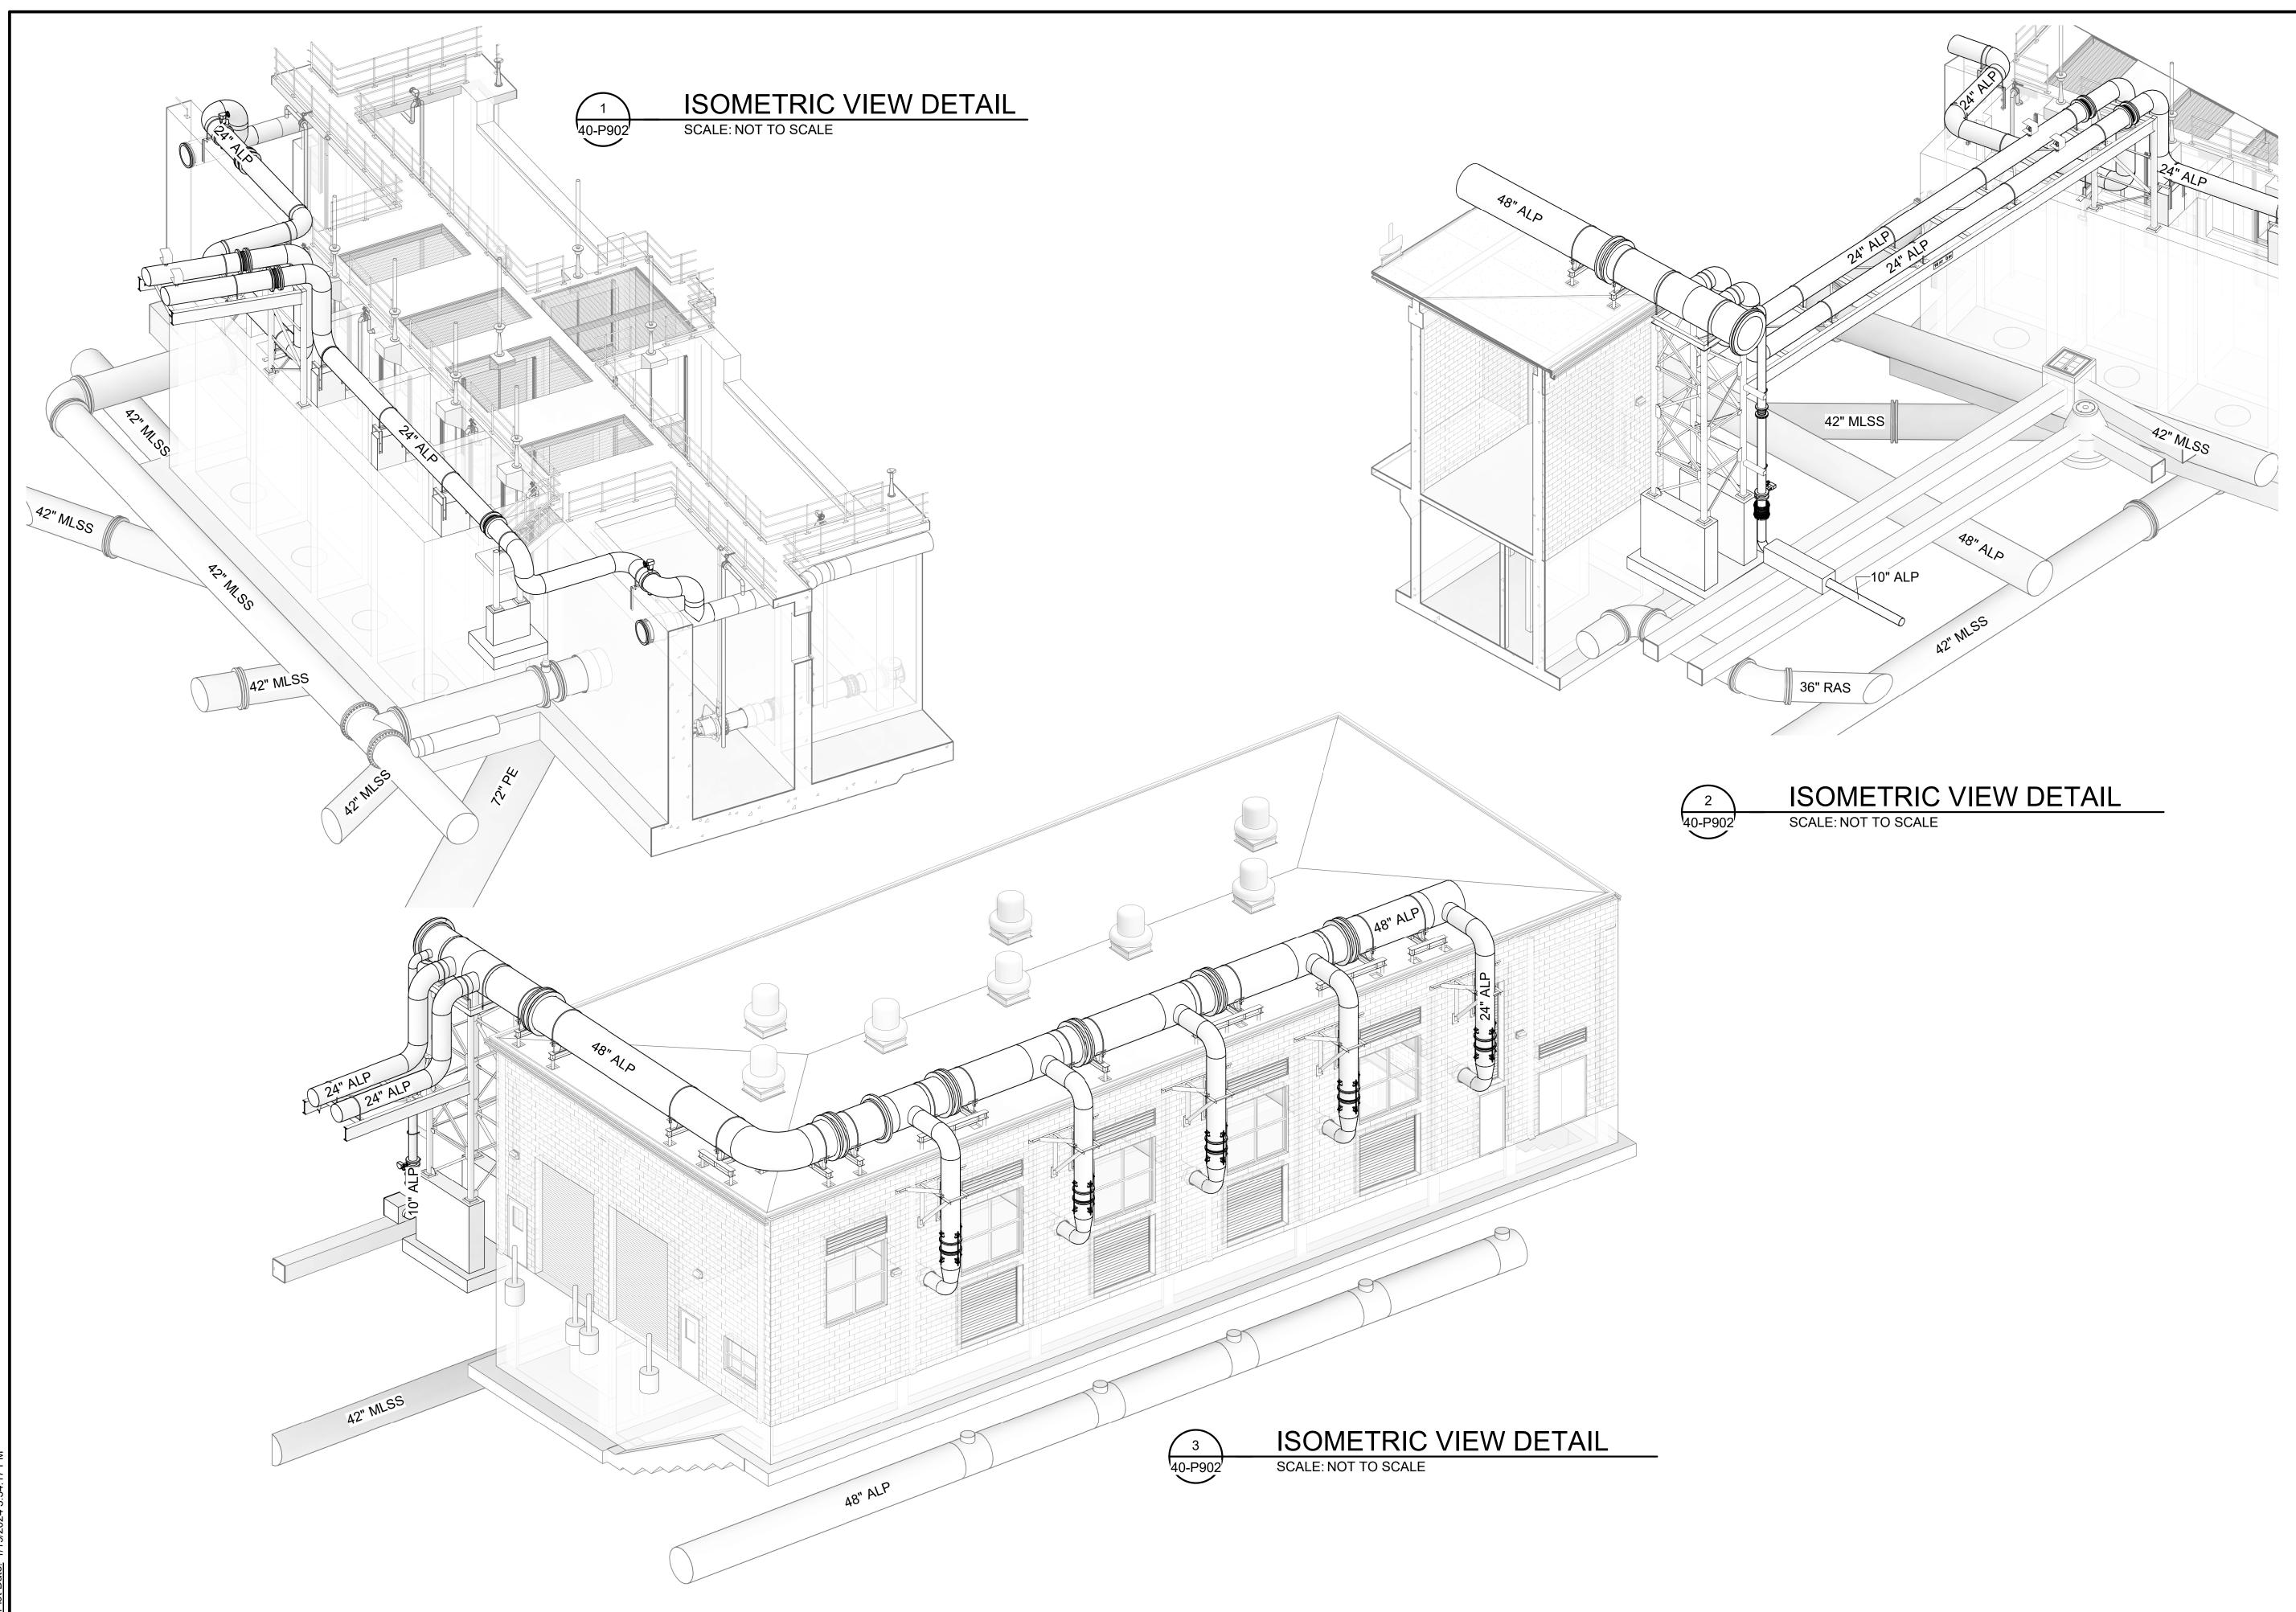
NORTH AERATION BASINS - BLOWER PIPING ISOMETRIC VIEW OVERALL
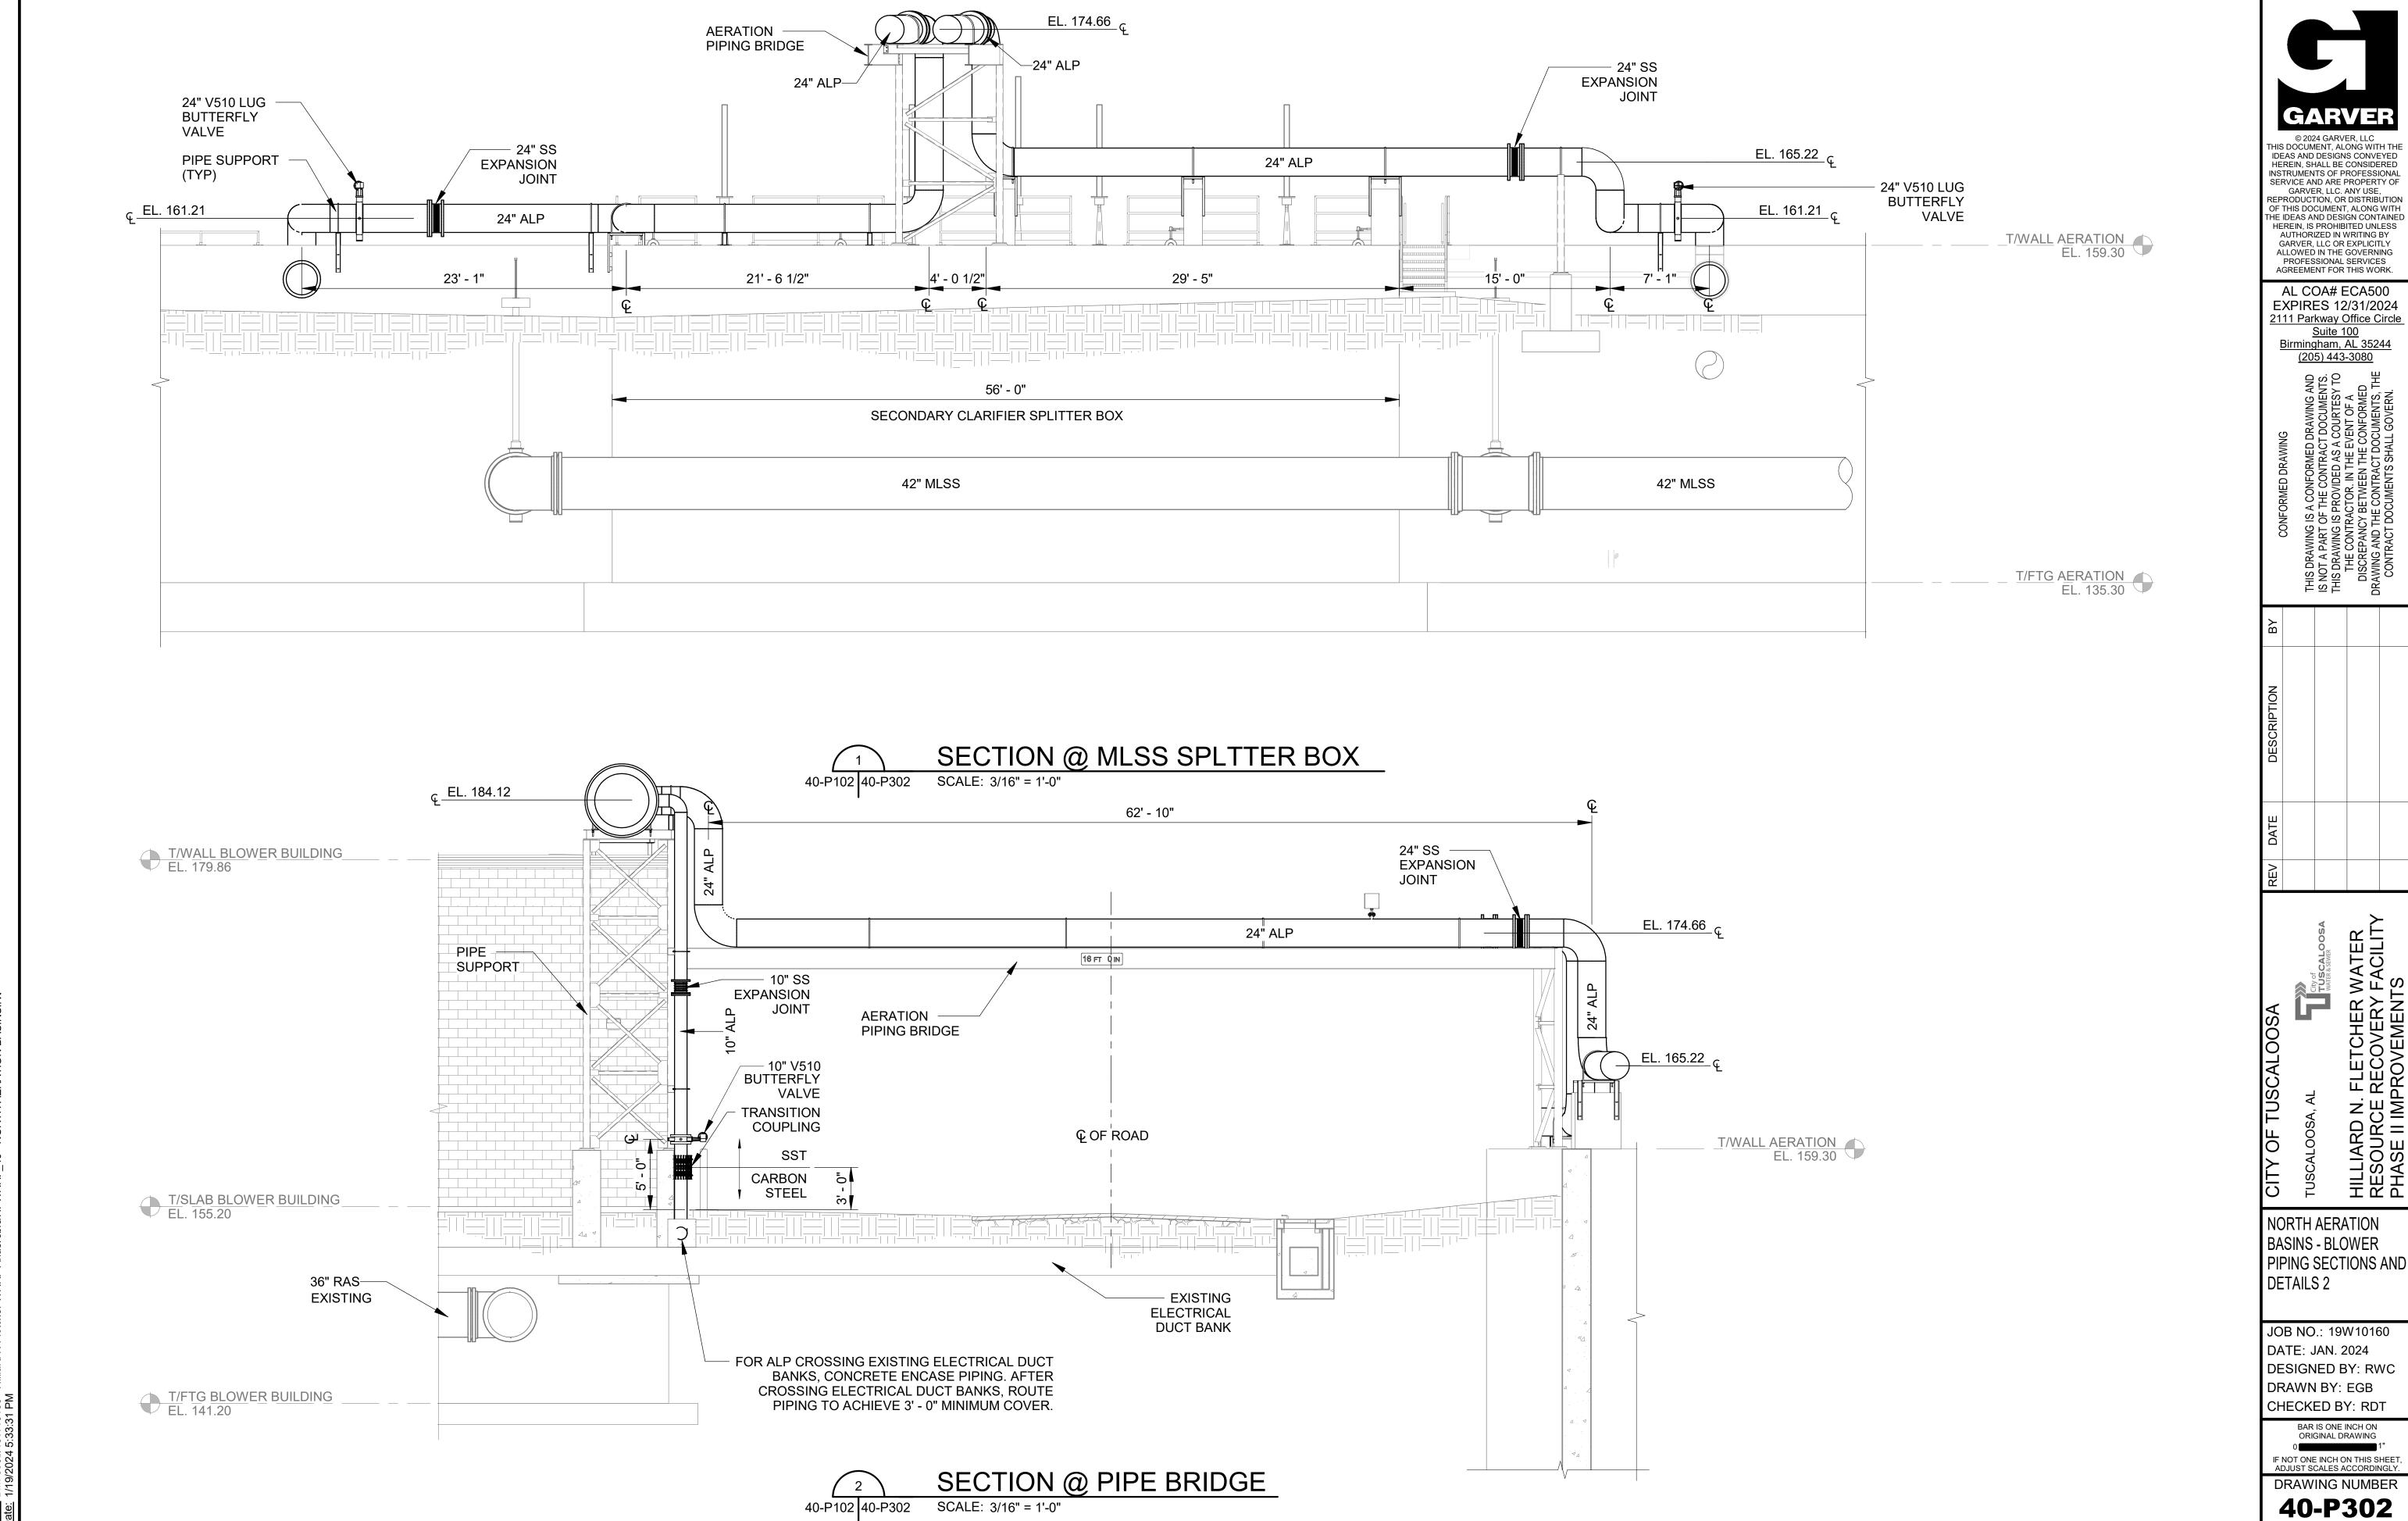
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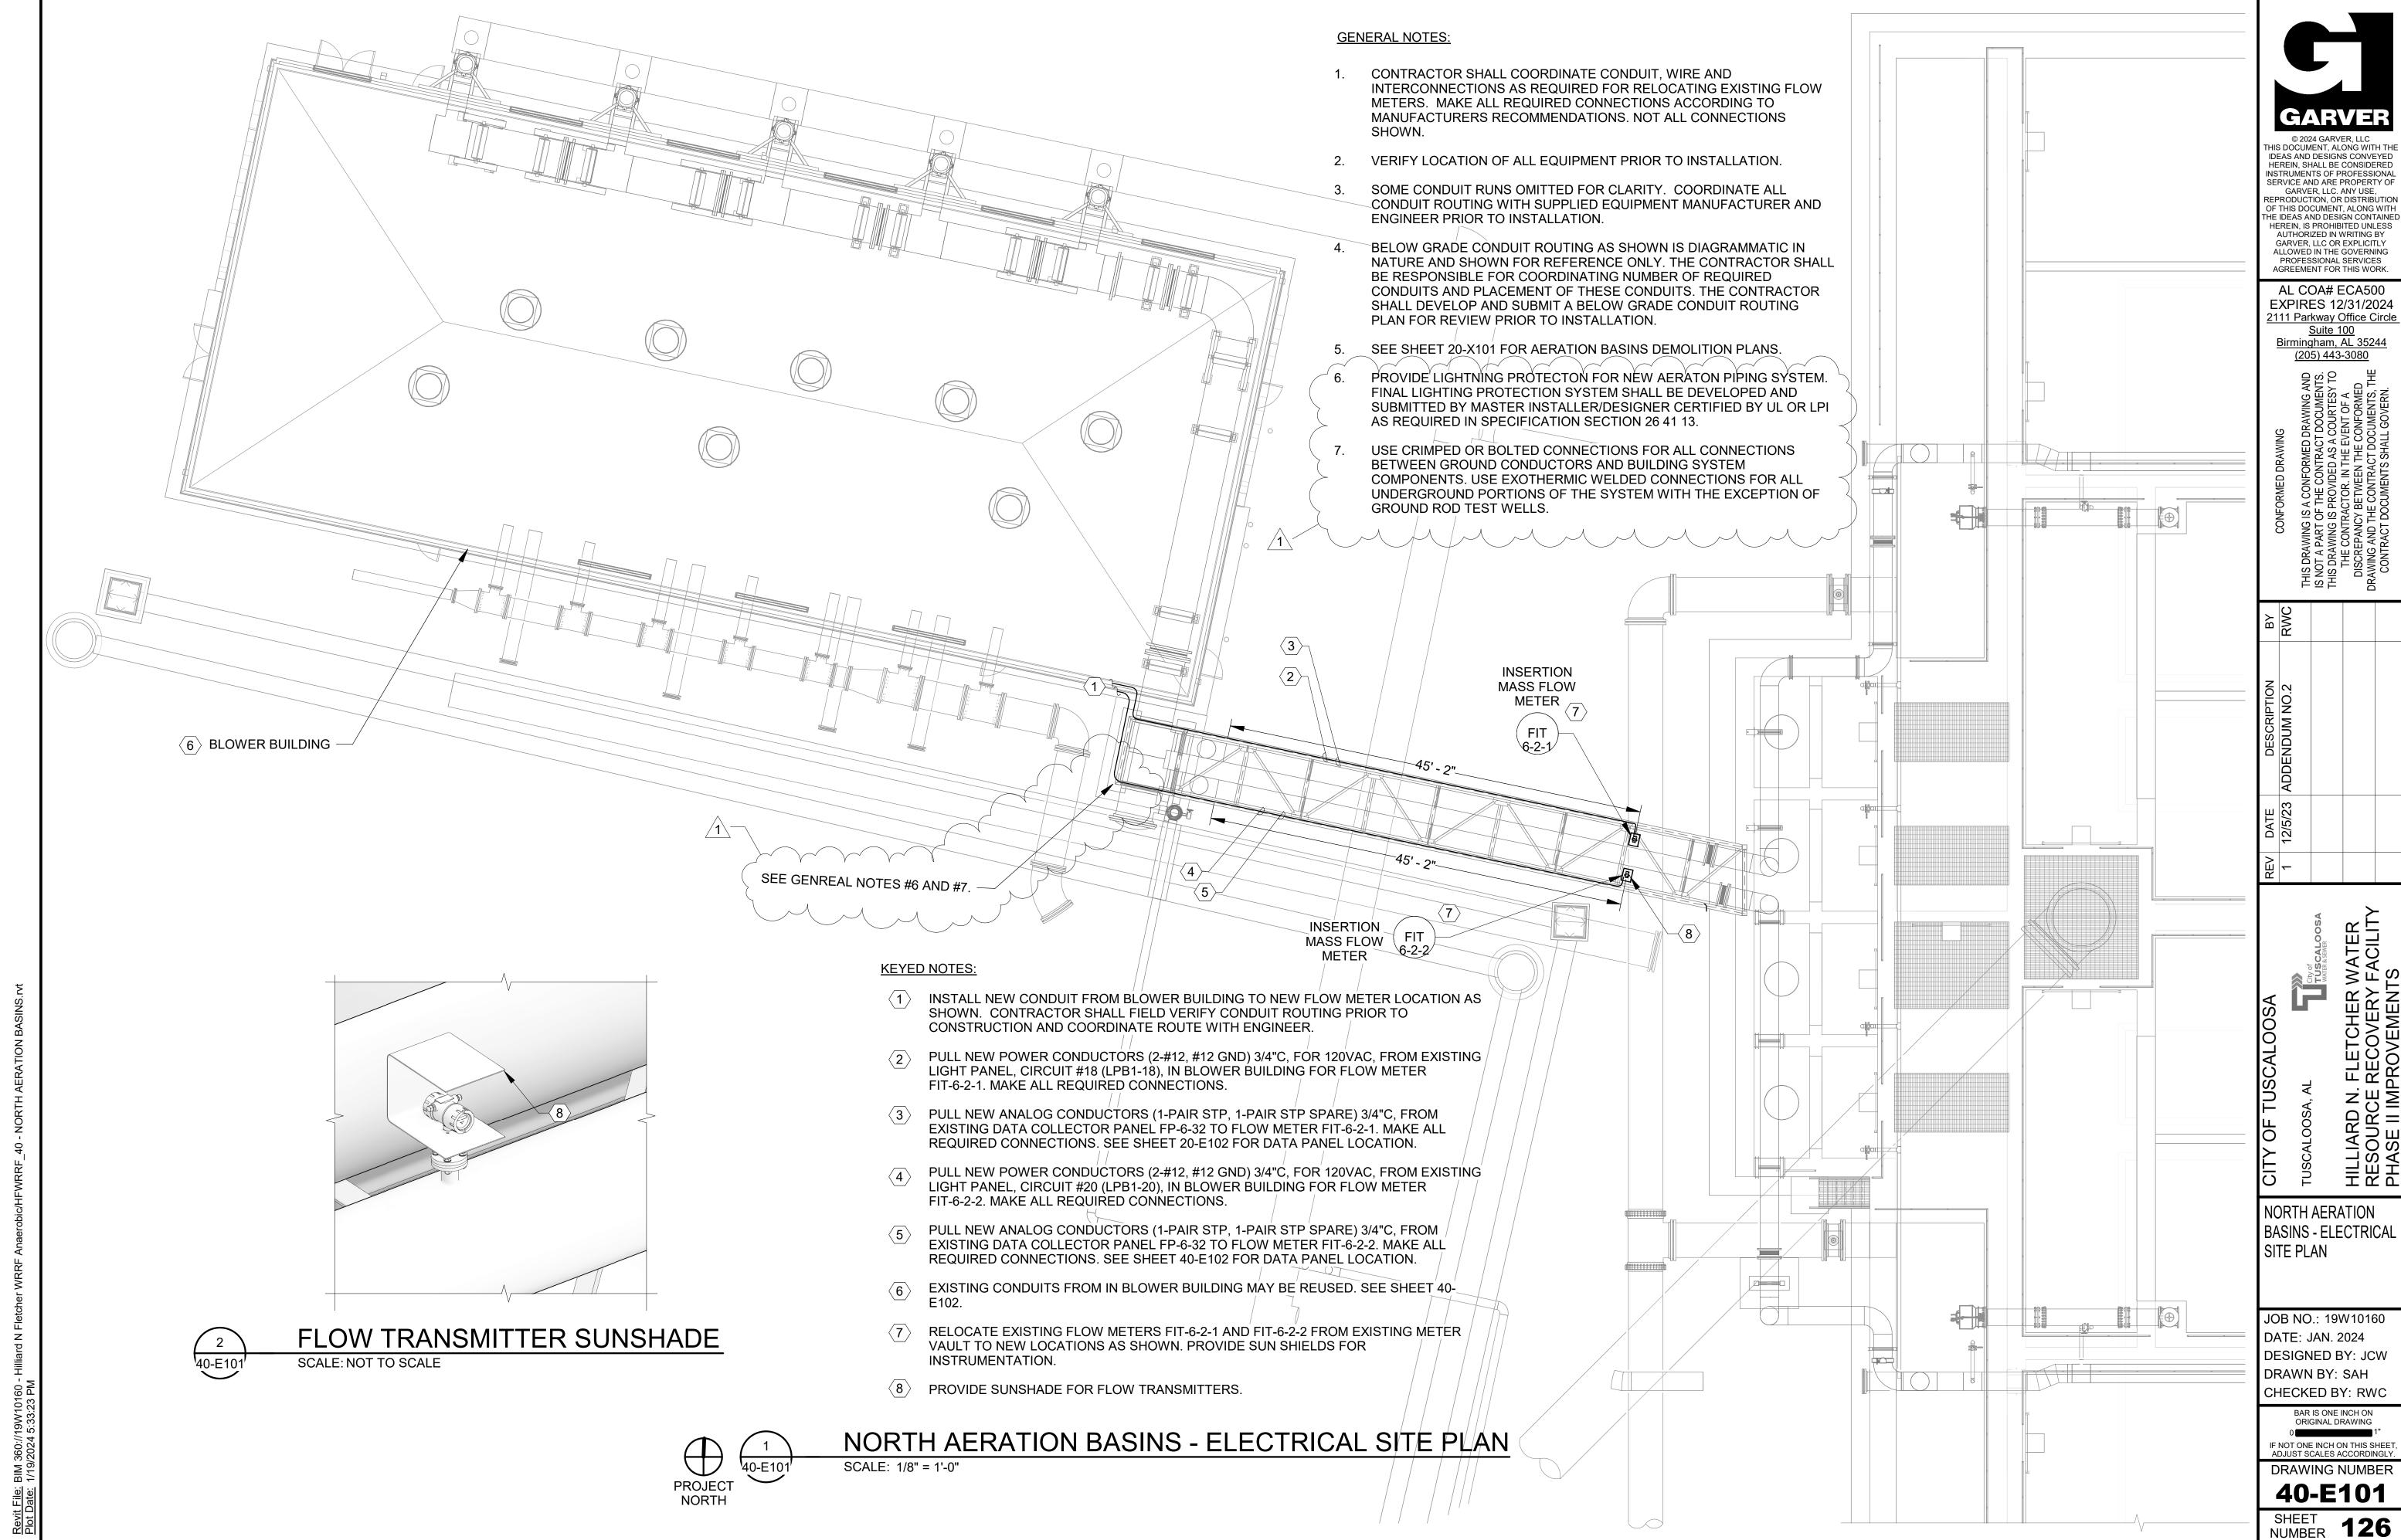
NORTH AERATION BASINS - BLOWER PIPING ISOMETRIC VIEWS

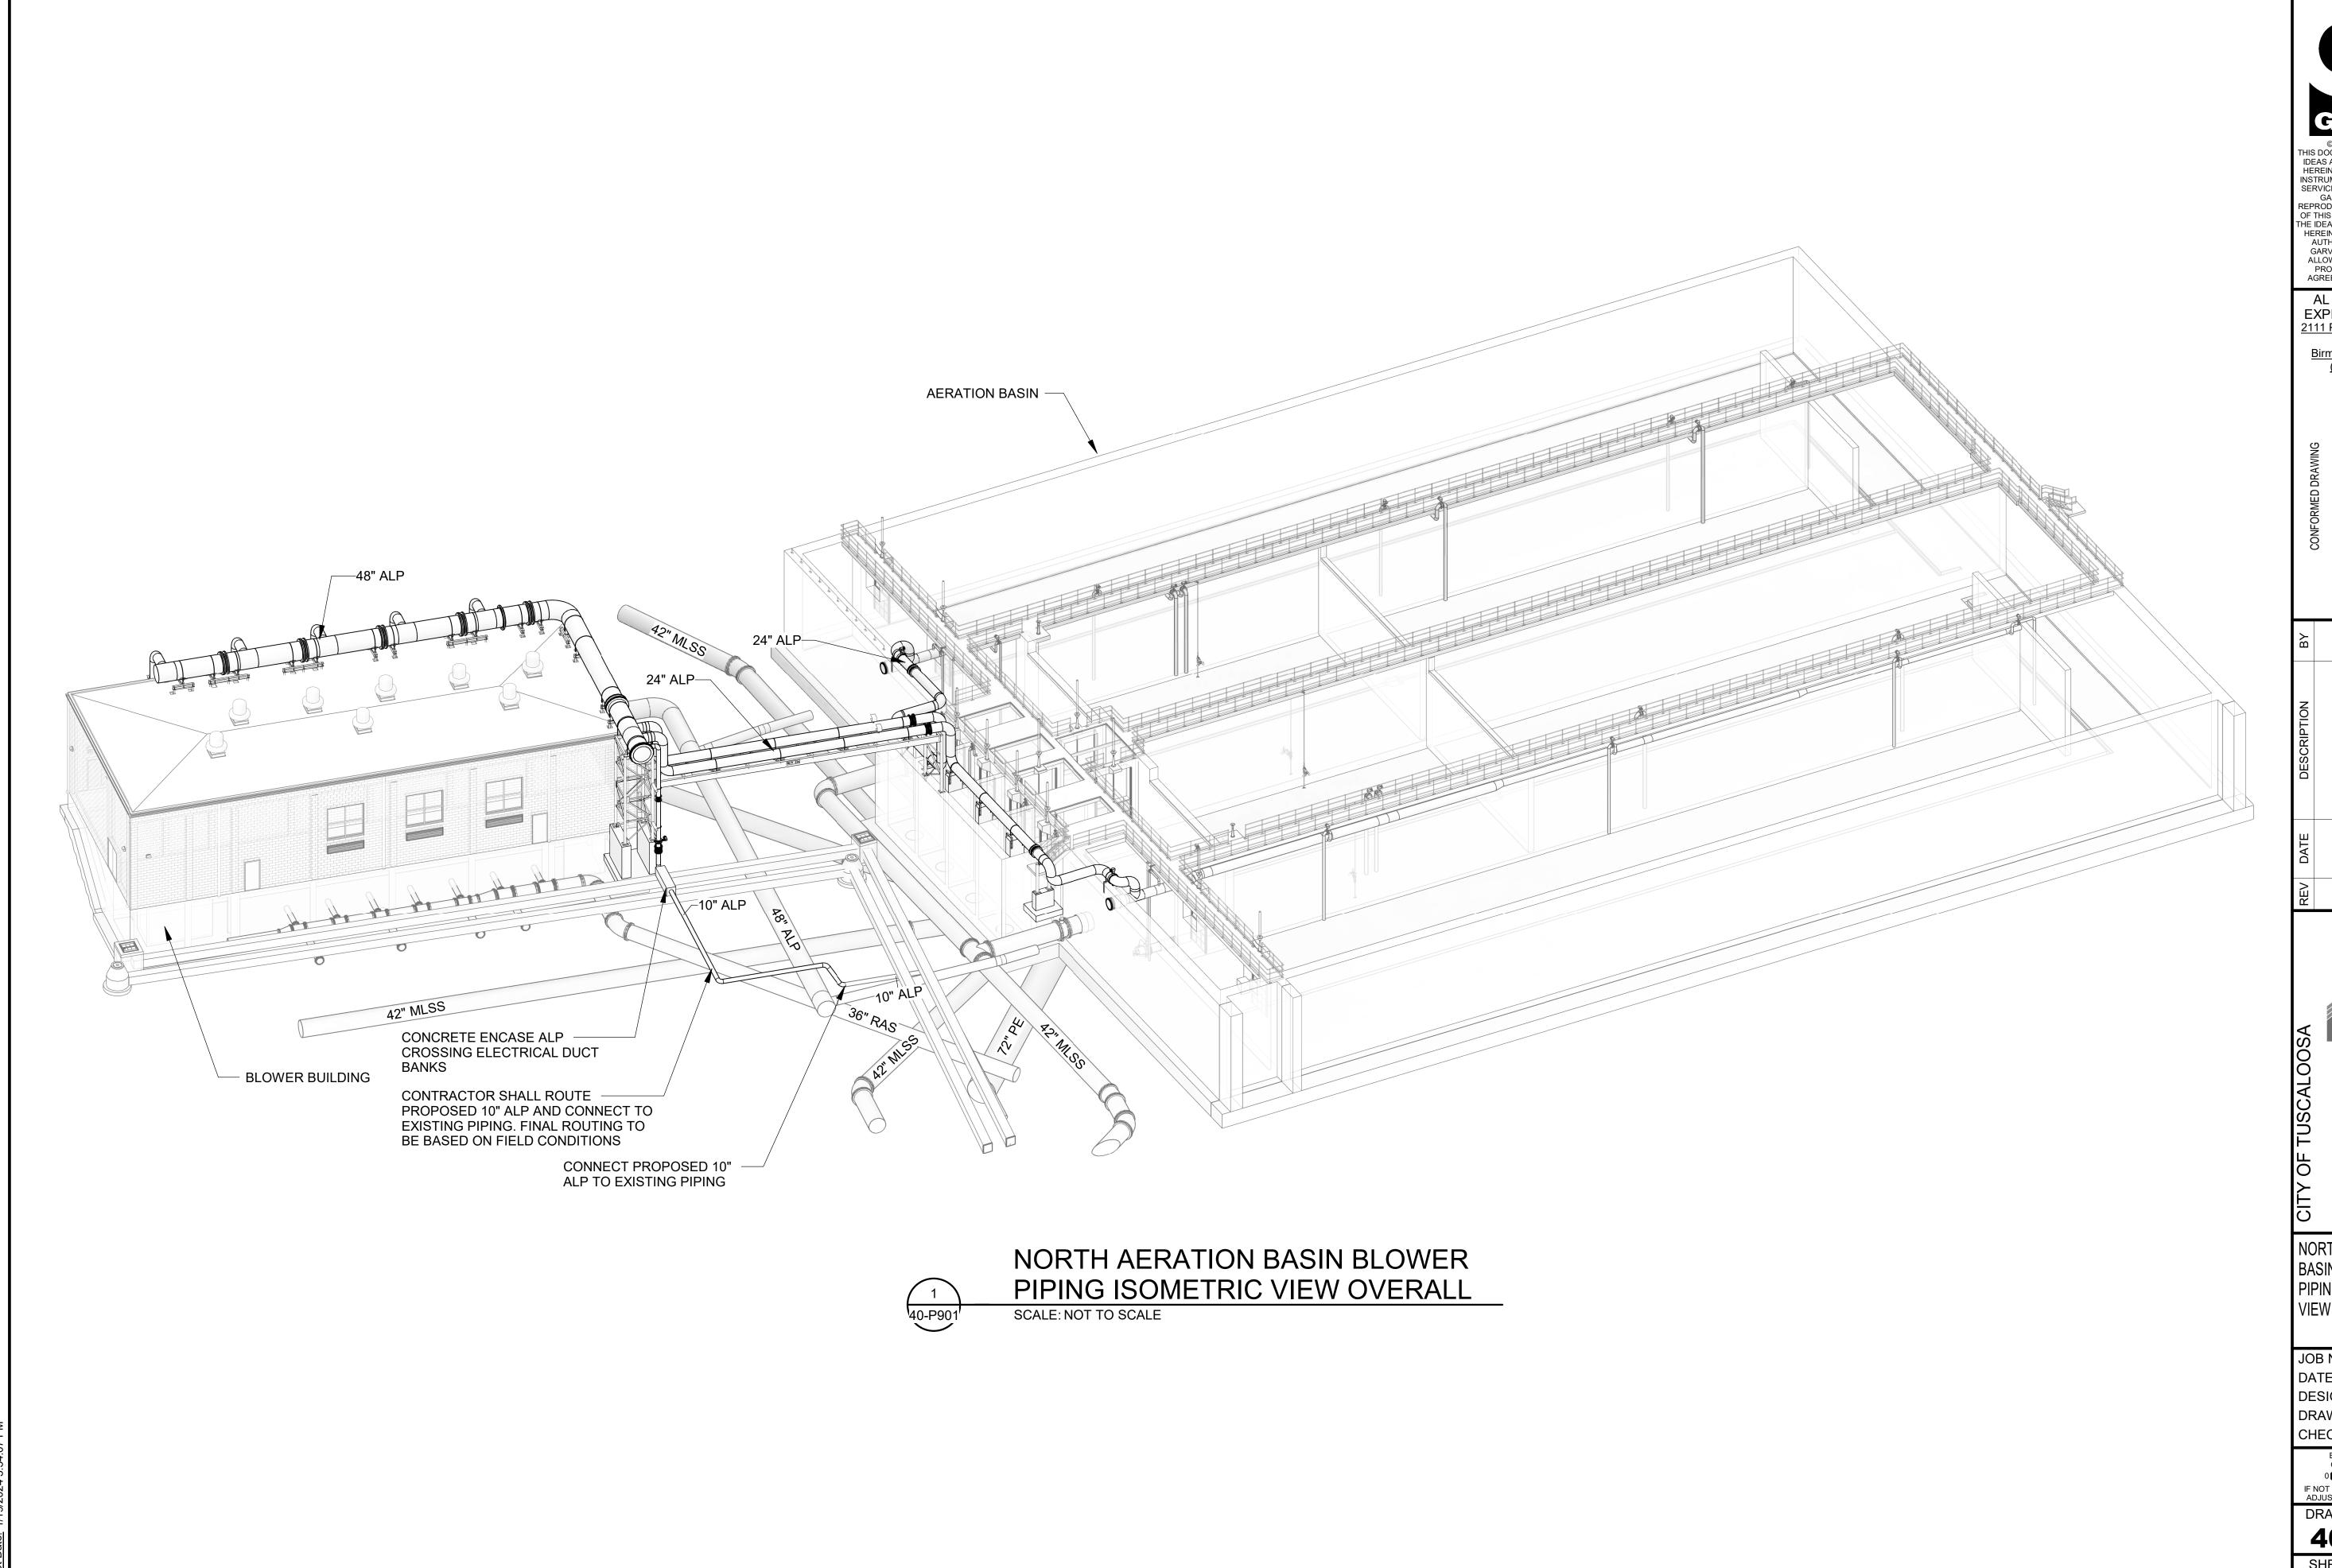
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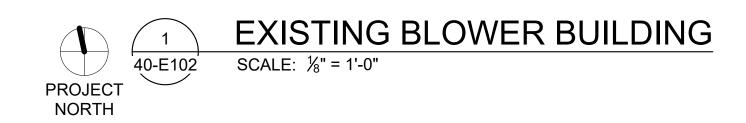
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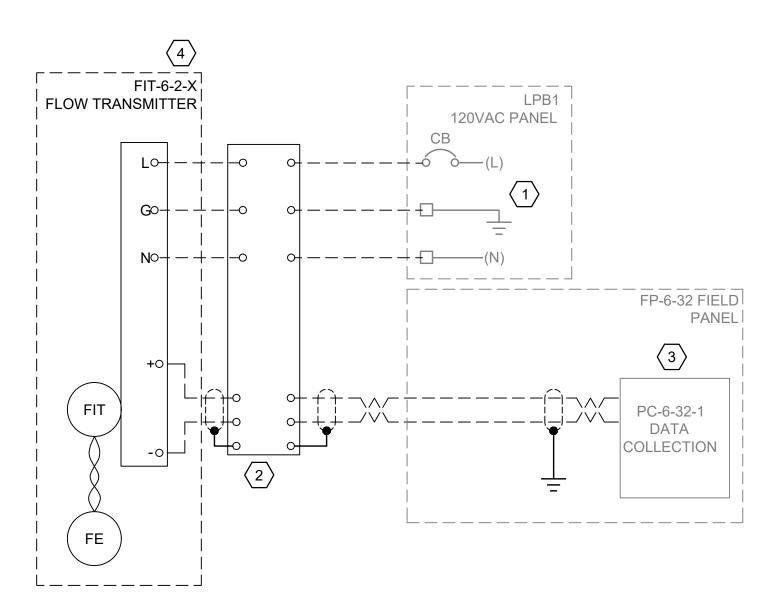
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40-P902 SHEET 125









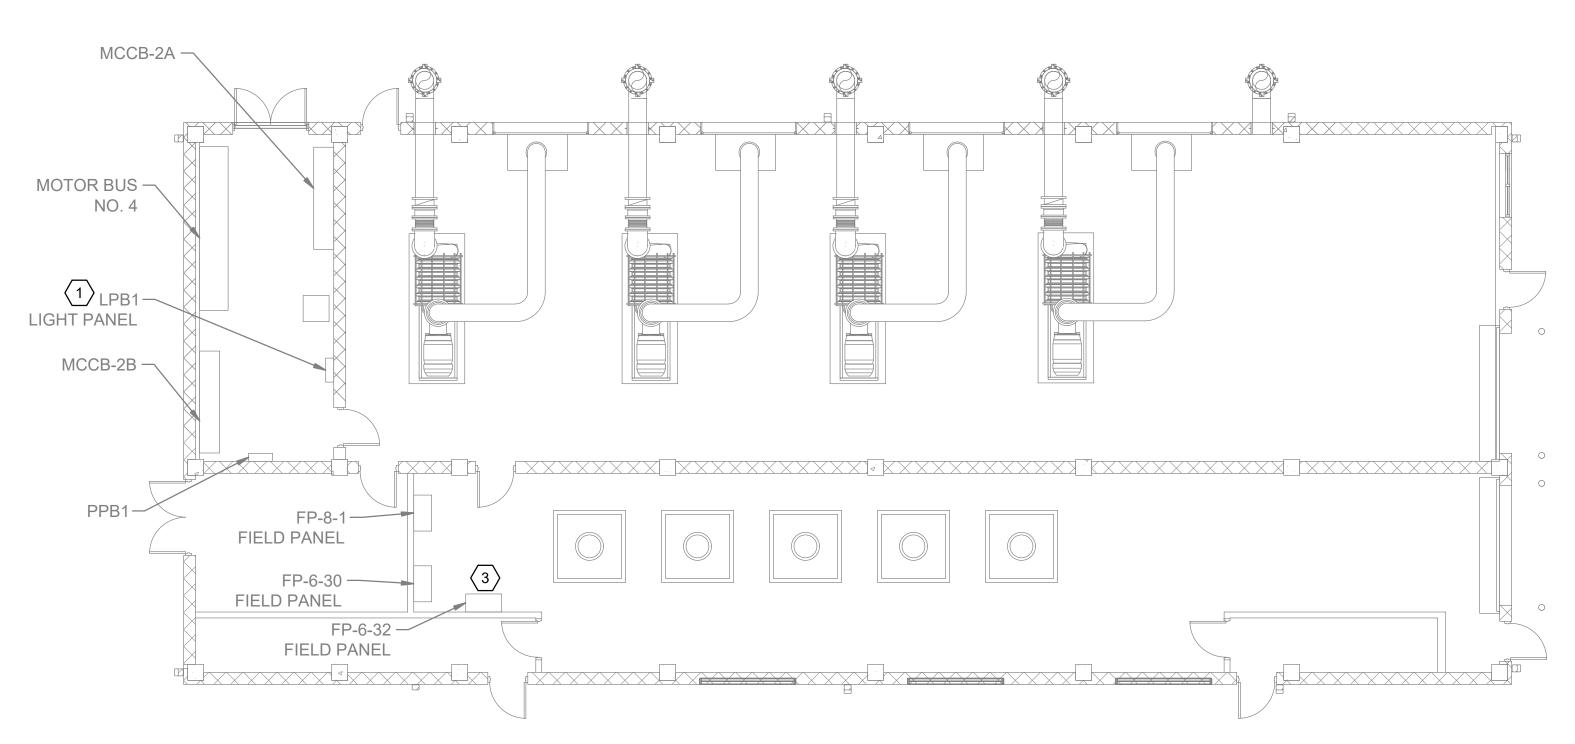

FIT-6-2-1 AND FIT-6-2-2 FLOW METER SCHEMATIC

SCALE: NONE

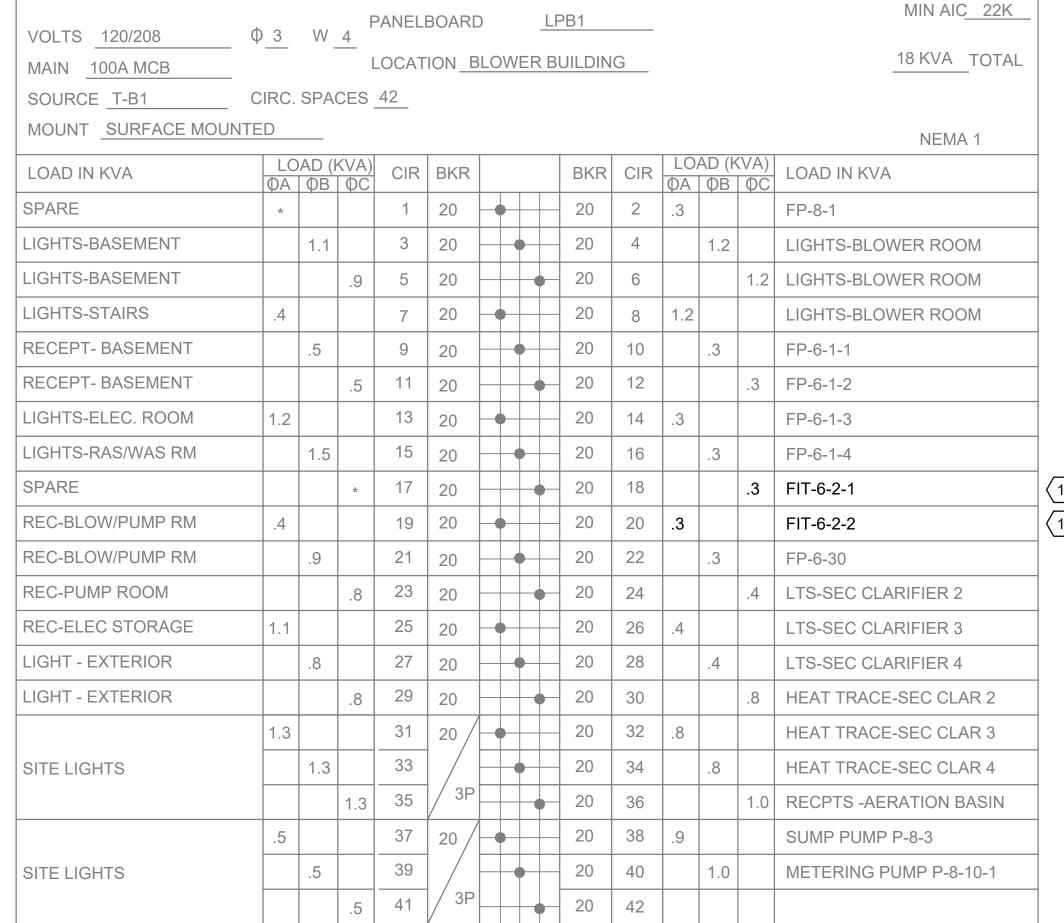

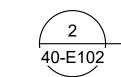

EX. LPB1 LIGHT PANEL SCHEDULE MODIFICATIONS

SCALE: NONE

KEYED NOTES:

- CIRCUITS #18 AND #20 IN EXISTING LIGHT PANEL LPB1 TO BE REUSED FOR RELOCATED FLOW TRANSMITTERS FIT-6-2-1 AND FIT-6-2-2. SEE SHEET 40-E101 FOR NEW LOCATIONS OF EXISTING FLOW TRANSMITTERS. PULL NEW CONDUCTORS. EXISTING CONDUIT WITHIN THE BLOWER BUILDING MAY BE REUSED. EXTEND NEW CONDUIT AND CONDUCTORS TO FLOW TRANSMITTERS.
- 2 FURNISH AND INSTALL NEW ASCO MODEL 265 OR EQUAL SURGE PROTECTIVE DEVICE AT FLOW TRANSMITTER.
- FIELD VERIFY FLOW TRANSMITTERS FIT-6-2-1 AND FIT-6-2-2 ANALOG SIGNAL TERMINATIONS IN FIELD PANEL PF-6-32. MAKE ALL REQUIRED MODIFICATIONS TO FIELD PANEL FP-6-32 FOR ANALOG SIGNAL COMMUNICATION FROM FLOW TRANSMITTERS FIT-6-2-1 AND FIT-6-2-2 TO EXISTING SCADA SYSTEM. PULL ALL NEW CONDUCTORS.
- FLOW TRANSMITTERS FIT-6-2-1 AND FIT-6-2-2 ARE TO BE REUSED IN A NEW LOCATION. PROVIDE SUN-SHIELD FOR TRANSMITTERS. SEE SHEET 40-E101 FOR LOCATION AND PULL ALL NEW CONDUCTORS.



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JSCALOOSA, ALABAMA

ILLIARD N. FLETCHER
FSOLIRGE RECOVERY

FLOW METER RELOCATION/ INSTALLATION

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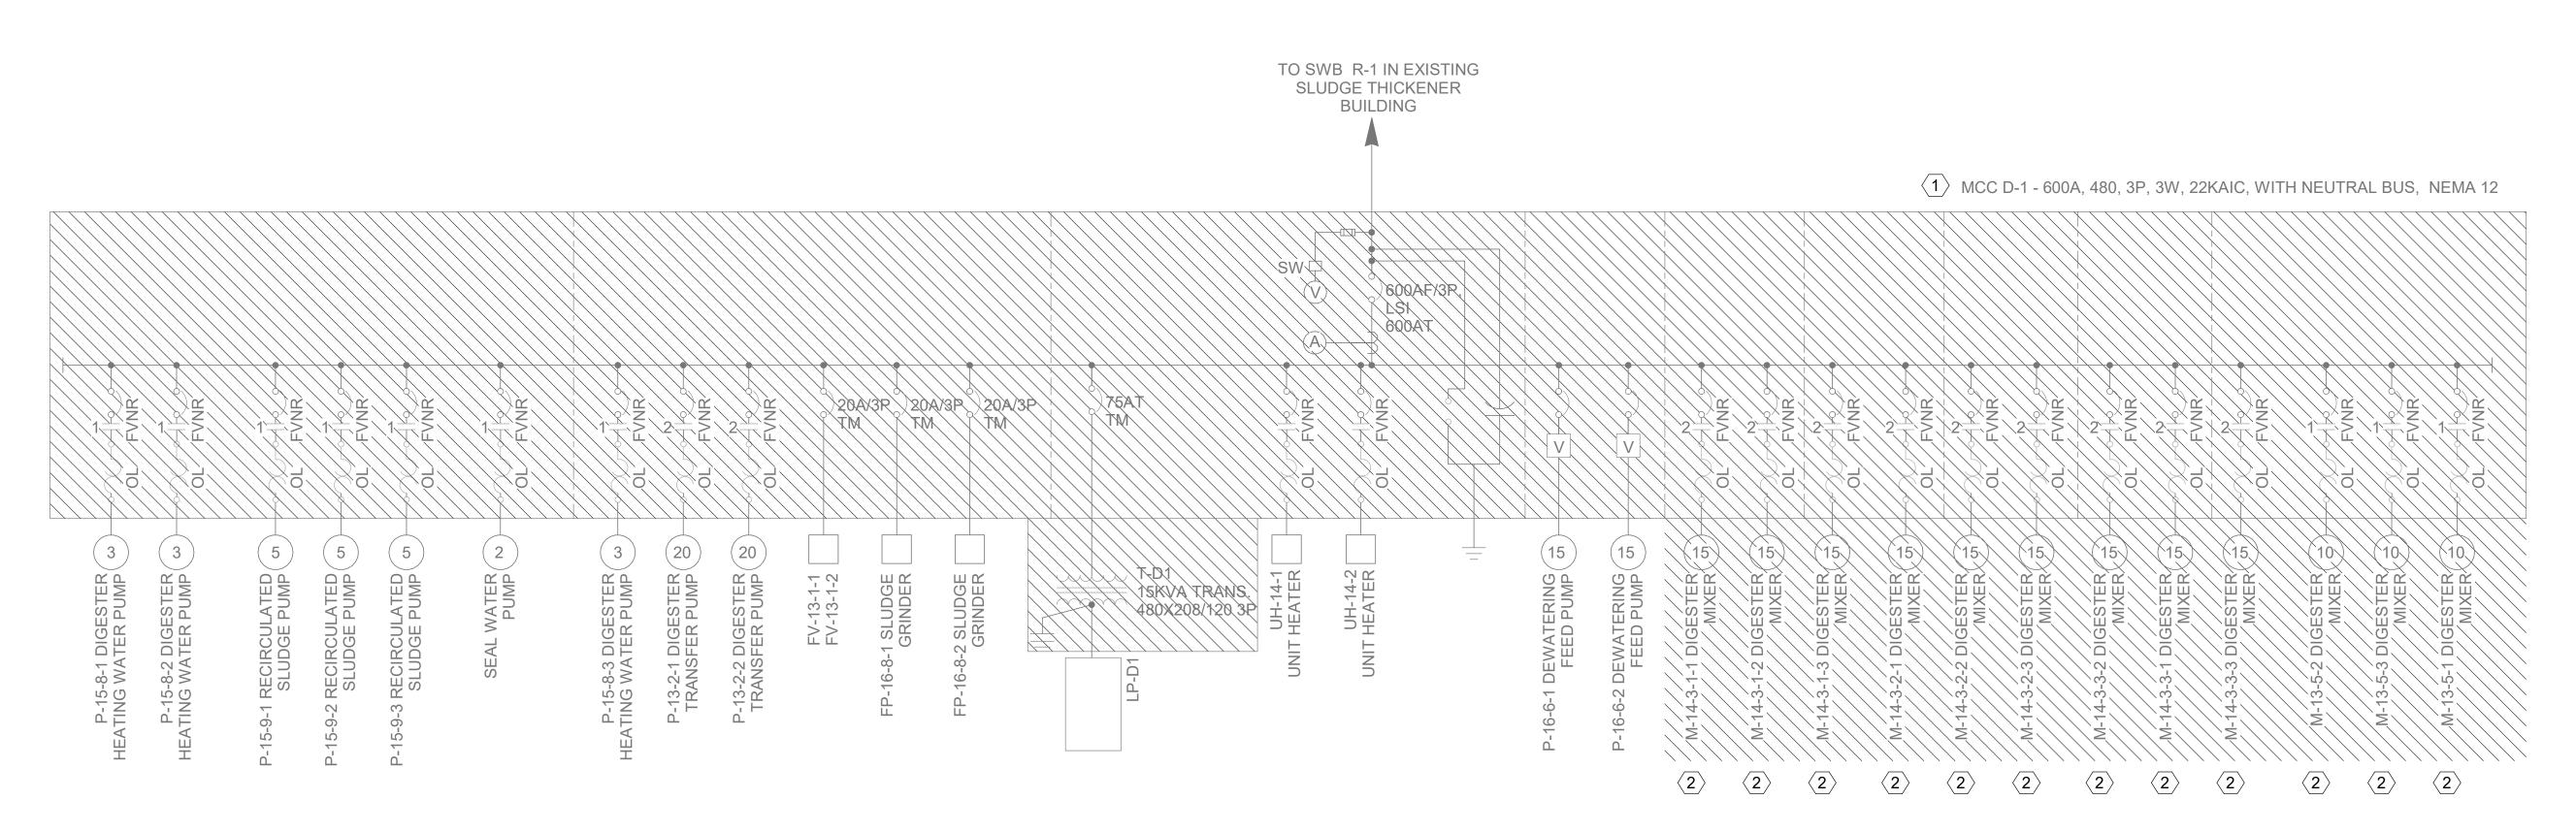
DRAWING NUMBER

40-E102

SHEET 127

NUMBER 127

KEYED NOTES 1 EXISTING MCC D-1 TO BE REMOVED AND REPLACED WITH NEW. COORDINATE DISPOSAL/SALVAGE WITH OWNER. REUSE EXISTING CONDUCTORS FOR LOADS THAT ARE TO REMAIN AND MAKE ALL REQUIRED CONNECTIONS. EXISTING MIXERS, CONDUIT AND CONDUCTORS TO BE REMOVED. COORDINATE DISPOSAL/SALVAGE WITH OWNER.



90-E501

ANAEROBIC DIGESTION EXISTING ONELINE DIAGRAM

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90-E501

ANAEROBIC DIGESTION MODIFIED ONELINE DIAGRAM

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TUSCALOOSA, AL HILLIARD N. FLETCH RESOURCE RECOVE

ANAEROBIC DIGESTION ONELINE DIAGRAM MODIFICATION

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90-E502 SHEET 129

		20CP1 I/O LIST	
I/O TYPE	UNITS	DESCRIPTION	SOURCE /
		VALVE POSITION "A"	ZS-13-1-1
		VALVE POSITION "B"	ZS-13-1-1
		VALVE POSITION "A"	ZS-13-1-2
		VALVE POSITION "B"	ZS-13-1-2
		DIGESTER 1 HIGH LEVEL	LSH-13-4-1
		DIGESTER 2 HIGH LEVEL	LSH-13-4-2
		DIGESTER 3 HIGH LEVEL	SLH-13-4-3
DI	120VAC	TRANSFER PUMP 1 RUNNING	20MCC1
		TRANSFER PUMP 2 RUNNING LOW FLOW SWITCH 1	20MCC1
		LOW FLOW SWITCH 1	FSL-14-2-1 FSL-14-2-2
		LOW FLOW SWITCH 2 LOW FLOW SWITCH 3	FSL-14-2-3
		PILOT FAIL	FP-14-6
		DIGESTER GAS HIGH PRESSURE	PSH-14-3
		DIGESTER GAS LOW PRESSURE	PSL-14-3
		EXPLOSIVE CONDITION	AIT-14-9
		LOW FUEL	PSL-15-1
		SLUDGE HEATER FAIL 1	FP-15-1-1
		SLUDGE HEATER FAIL 2	FP-15-1-2
		BOILER FAN 1 ON	FP-15-1-1
		BOILER FAN 2 ON	FP-15-1-2
		BOILER 1 TEMPERATURE LOW	TSL-15-10-1
		BOILER 1 TEMPERATURE 1 HIGH	TSH-15-7-1
DI	120VAC	BOILER 1 TEMPERATURE 2 HIGH	TSH-15-10-1
	1207710	BOILER 2 TEMPERATURE LOW	TSL-15-10-2
		BOILER 2 TEMPERATURE 1 HIGH	TSH-15-7-2
		BOILER 2 TEMPERATURE 2 HIGH	TSH-15-10-2
		BOILER 3 TEMPERATURE LOW	TSL-15-10-3 TSH-15-7-3
		BOILER 3 TEMPERATURE 1 HIGH BOILER 3 TEMPERATURE 2 HIGH	TSH-15-7-3
		DEWATERING FEED PUMP 1 RUNNING	20MCC1
		DEWATERING FEED PUMP 2 RUNNING	20MCC1
		DEWATERING FEED PUMP 1 FAULT	20MCC1
		DEWATERING FEED PUMP 2 FAULT	20MCC1
		MIXER #1 RUNNING	20MCC1
		MIXER #2 RUNNING	20MCC1
		MIXER #3 RUNNING	20MCC1
		MIXER #1 FAULT	20MCC1
		MIXER #2 FAULT	20MCC1
DI	120VAC	MIXER #3 FAULT	20MCC1
J.	120 77 10	DEWATERING FEED PUMP 1 HIGH PRESSURE	PSH-16-6-1
		DEWATERING FEED PUMP 2 HIGH PRESSURE	PSH-16-6-2
		DEWATERING FEED PUMP RUN COMMAND	FP-16-2-1
		DEWATERING FEED PUMP RUN COMMAND	FP-16-2-2 20MCC1
		DIGESTER HEATING WATER PUMP #1 RUNNING DIGESTER HEATING WATER PUMP #2 RUNNING	20MCC1
		DIGESTER HEATING WATER PUMP #3 RUNNING	20MCC1
		RECIRCULATING SLUDGE PUMP #1 RUNNING	20MCC1
		RECIRCULATING SLUDGE PUMP #2 RUNNING	20MCC1
		RECIRCULATING SLUDGE PUMP #3 RUNNING	20MCC1
		BOILER CIRCULATION PUMP 1 RUNNING	FP-15-1-1
		BOILER CIRCULATION PUMP 2 RUNNING	FP-15-1-2
		SPARE	
		SPARE	
		SPARE	
DI	120VAC	SPARE	
וט	120170	SPARE	
		SPARE SPARE	
		SPARE	


GENERAL NOTES:

I/O LIST PROVIDED REPRESENTS I/O GENERATED FROM EXISTING ALLEN BRADLEY MICROLOGIX PLC PROGRAM AND AVAILABLE RECORD DRAWINGS. CONTRACTOR TO FIELD VERIFY REQUIRED I/O AND ADJUST AS REQUIRED.

		20CP1 I/O LIST	
		VALVE OPEN	FV-13-1-1
		VALVE CLOSE	FV-13-1-1
		VALVE OPEN	FV-13-1-2
		VALVE CLOSE	FV-13-1-2
		VALVE POSITION FAULT TO CMP	CMP PANEL
		HIGH DIGESTER LEVEL TO CMP	CMP PANEL
		LOW FLOW TO CMP	CMP PANEL
DO	N.O.	GAS FAIL TO CMP	CMP PANEL
DO	RELAY	EXPLOSIVE CONDITION TO CMP	CMP PANEL
		LOW FUEL TO CMP	CMP PANEL
		HEATER FAIL TO CMP	CMP PANEL
		SLUDGE HEATER FAIL #1	OL-15-1-1-2
		SLUDGE HEATER FAIL #2	OL-15-1-2-2
		DIGESTER HEATING WATER PUMP #1 RUN	20MCC1
		DIGESTER HEATING WATER PUMP #2 RUN	20MCC1
		DIGESTER HEATING WATER PUMP #3 RUN	20MCC1
		RECIRCULATING SLUDGE PUMP #1 RUN	20MCC1
		RECIRCULATING SLUDGE PUMP #2 RUN	20MCC1
		RECIRCULATING SLUDGE PUMP #3 RUN	20MCC1
		DEWATERING FEED PUMP 1 RUN	20MCC1
		DEWATERING FEED PUMP 2 RUN	
			20MCC1
		DEWATERING FEED PUMP RUNNING	FP-16-2-1
		DEWATERING FEED PUMP RUNNING	FP-16-2-2
D0	N.O.	DEWATERING FEED PUMP FAULT	FP-16-2-1
DO	RELAY	DEWATERING FEED PUMP FAULT	FP-16-2-2
	-	SPARE	
		SPARE	
		SPARE	
		SPARE	
		SPARE	
		SPARE	
D.C.	N.O.	SPARE	
DO	RELAY	SPARE	
		SPARE	
		31.1.1.1.1.1	
		SPARE	
			LIT 40.0
AI 4		DIGESTER 4 LEVEL	LIT-13-3
	4-20MA	DIGESTER GAS PRESSURE	PIT-14-3
		DIGESTER GAS FLOW RATE	FT-14-7
		DIGESTER 1 GAS FLOW RATE	FT-14-1-1
		DIGESTER 2 GAS FLOW RATE	FT-14-1-2
		DIGESTER 3 GAS FLOW RATE	FT-14-1-3
		DIG 1 HEATING WATER TEMPERATURE	TIT-7-1
		DIG 2 HEATING WATER TEMPERATURE	TIT-7-2
		DIG 3 HEATING WATER TEMPERATURE	TIT-7-3
		DIG 1 RECIRC WATER TEMPERATURE	TIT-10-1
	4-20MA		
		DIG 2 RECIRC WATER TEMPERATURE	TIT-10-2
ΑI		DIG 3 RECIRC WATER TEMPERATURE	TIT-10-3
ΛI		BOILER WATER TEMPERATURE	TIT-15-4
		DEWATERING FEED PUMP 1 SPEED	20MCC1
		DEWATERING FEED PUMP 2 SPEED	
			20MCC1
		DEWATERING FEED PUMP 1 SPEED SETPOINT	FP-16-2-1
		DEWATERING FEED PUMP 2 SPEED SETPOINT	FP-16-2-2
		DIGESTER #1 LEVEL	LIT-13-4-1
	4-20MA	DIGESTER #2 LEVEL	LIT-13-4-2
ΑI		DIGESTER #3 LEVEL	LIT-13-4-3
	25177	SPARE	
		SPARE	
		CDADE	1
		SPARE	

	20CP1 I/O LIST				
		GAS FLOW TO CMP	CMP PANEL		
		DIGESTER 1 GAS FLOW RATE	CMP PANEL		
		DIGESTER 2 GAS FLOW RATE	CMP PANEL		
AO	4-20MA	DIGESTER 3 GAS FLOW RATE	CMP PANEL		
AU	4-ZUIVIA	BOILER WATER VALVE POSITION CONTROL	TCV-15-5		
		DEWATERING FEED PUMP 1 SPEED SETPOINT	20MCC1		
		DEWATERING FEED PUMP 2 SPEED SETPOINT	20MCC1		
		HEAT EXCHANGER 1 3-WAY TEMP CONTROL VALVE	TCV-15-7-1		
		HEAT EXCHANGER 2 3-WAY TEMP CONTROL VALVE	TCV-15-7-2		
		HEAT EXCHANGER 3 3-WAY TEMP CONTROL VALVE	TCV-15-7-3		
		SPARE			
AO	4-20MA	SPARE			
AU	4-∠UIVIA	SPARE			
		SPARE			
		SPARE			
		SPARE			


FIELD PANEL FP-15-1 TO BE REMOVED

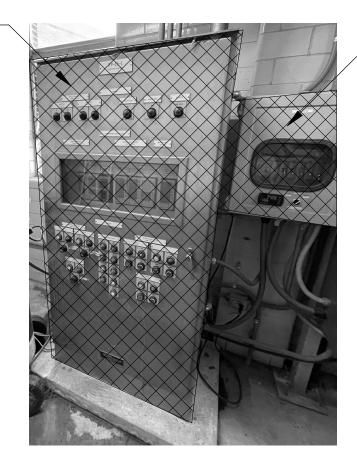


— GAS LEAK
DETECTION PLC
CONTROL PANEL TO
BE REMOVED


CONTROL PANEL DEMO
90-E701 SCALE: NOT TO SCALE

FP-16-7 ENCLOSURE TO -REMAIN. REMOVE CONTROL COMPONENTS AND EXTEND I/O WIRING TO NEW PLC CONTROL PANEL. COVER PANEL OPENINGS.

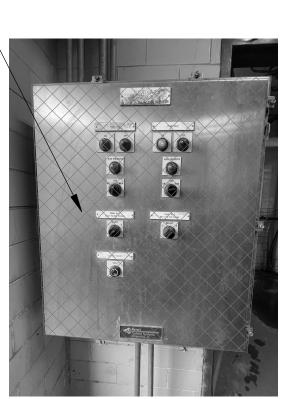

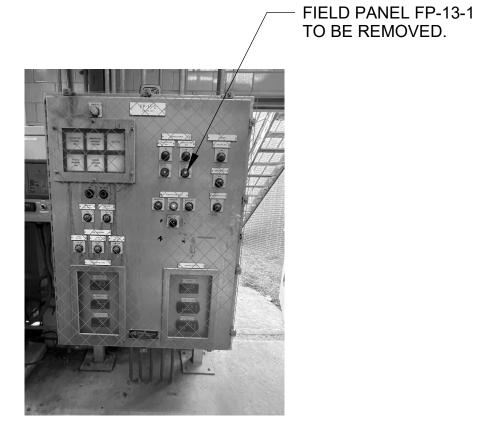

2 CONTROL PANEL DEMO
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TUSCALOOSA, AL HILLIARD N. FLET RESOURCE RECC

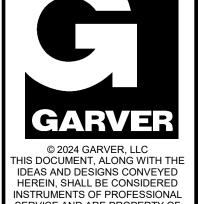20CP1 PLC I/O

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